

# PLANNING COMMISSION MEETING AGENDA TUESDAY SEPTEMBER 16, 2025

### 7:30 PM REGULAR MEETING

- 1. Call to Order
- 2. Roll Call
- 3. Approval of Minutes:
  - a. July 15, 2025, Planning Commission Meeting Minutes.
  - b. September 2, 2025, City Council Meeting Minutes (For Information Only).
- 4. <u>PUBLIC HEARING:</u> AT&T (Applicant) requests that the City consider the following action for the property located at 3310 County Line Road, Independence, MN (PID No. 07-118-24-33-0004):
  - a. A conditional use permit amendment to allow the upgrade and replacement of cellular antennas on the existing wireless tower and ground equipment located on the subject property.
- 5. <u>PUBLIC HEARING:</u> Greg A Jurvakainen (Applicants) and Carter Berkleman (Owner) request that the City consider the following action for the properties located at 6785 Highway 12, Independence, MN (PID No. 22-118-24-42-0001) and the property to the south that does not have an address but is identified by the following PID Number (PID No. 22-118-24-31-0002):
  - a. A minor subdivision to allow a lot line rearrangement between the two subject properties. The minor subdivision would add approximately 50' to the south side of the 6785 Highway 12 property.
- 6. <u>PUBLIC HEARING:</u> Scott Kirchner (Applicant) and Leroy Kowalke Et Al (Owner) requests that the City consider the following action for the Property located at 6551 County Road 6, Independence, MN (PID No. 34-118-24-12-0001):
  - a. A minor subdivision to allow a rural view lot subdivision. The proposed rural view lot would be 16.9 acres and located on the south side of County Road 6 along the east property line.
  - b. A variance to allow a rural view lot to exceed the maximum size of 10 acres.
- 7. Open/Misc.
- 8. Adjourn.



PLANNING COMMISSION MEETING AGENDA TUESDAY, JULY 15, 2025

## 7:30 PM REGULAR MEETING

## 1. Call to Order

Pursuant to due call and notice thereof, a work session of the Independence Planning Commission was called to order by Chair Thompson at 7:30 p.m.

# 2. Roll Call

PRESENT: Gardner, Tearse, Volkenant, Dumas, Alternate Usset

ABSENT: Thompson and Story

STAFF: City Administrator Kaltsas, Administrative Services Director Simon

VISITORS: See Sign in

# 3. Approval of Minutes:

a. June 24, 2025, Planning Commission Meeting Minutes.

b. June 24, 2025, City Council Meeting Minutes (For Information Only).

Motion by Dumas, seconded by Usset to approve the minutes. Ayes: Gardner, Dumas, Tearse, Volkenant and Usset. Nays: None. Absent: Thompson & Story. Abstain: None. Motion Approved. 5-0

- 4. **PUBLIC HEARING:** Sean Keating (Applicant/Owner) requests that the City consider the following action for the Properties located at 1875 Highsted Dr., Independence, MN (PID No.s 20-118-24-42-0002 and 20-118-24-42-0001):
  - a. A minor subdivision to allow a lot line rearrangement to realign the existing property line that separates the two properties. The proposed lot line rearrangement would shift the boundary away from the existing house and to the east which would bring the existing house into conformance with applicable building setbacks.

City Administrator Mark Kaltsas presented the request, explaining that Sean Keating owns both subject properties at 1875 Highstead Drive. He noted there was "a unique situation where there's 2 properties and there's a home which was constructed, and the property line dividing those 2

properties actually runs through a little piece of the home." Kaltsas stated he was "not sure the history of how that actually occurred or when or where that occurred," but noted both properties would be considered legal nonconforming in their current condition.

Kaltsas detailed that Highstead Drive comes off Pioneer Creek Drive just west of County Road 92. The property at 1875 Highstead has the existing home and is zoned agriculture, guided by the city's comprehensive plan as agriculture. In the before condition, it's about 29 acres. The second property with an unassigned address is directly adjacent and also zoned agriculture, comprising 10.42 acres in the before condition.

The applicant proposed to relocate the lot lines to "create more of a proper lot that would then also allow frontage for the existing 1875 Highstead property." Kaltsas explained, "In the after condition, we'd really end up with still a 29 acre and a 10 acre parcel. We just have a different orientation of the 10 acre parcel. It'd be more of a north south orientation rather than an east west."

This rearrangement would bring both properties into full compliance with all setbacks and provide frontage on the Highstead cul-de-sac to both properties, "even though it's really creating kind of a quasi flag lot. It's a much better situation than what existed in the precondition."

Staff noted advantages to the lot line rearrangement, with the only requirement being that the applicant provide requisite drainage and utilities as required for any subdivision. The city had not received any written or oral comments prior to the meeting.

Chair Gardner questioned the 60-foot wide access that makes it a flag lot, asking if it was preferable to having an easement. Kaltsas confirmed, "Having a full access owning actually out to the right of way would, I think, is a better situation for the owners if it ever sells as 2 properties. It just gives you a much better control than having an easement would."

Gardner initially thought there was a gap between the two property lines but realized it was just the graphic representation. Kaltsas confirmed the properties are contiguous.

Chair Gardner opened the public hearing. No members of the public came forward to speak.

Motion by Timothy Usset, seconded by Commissioner Dumas, to close the public hearing. Motion carried unanimously.

Motion by Timothy Usset to recommend approval of the requested minor subdivision located at 1875 Highstead Drive, subject to staff recommendations 1 through 4. Motion seconded. Motion carried unanimously. 5-0

Kaltsas informed the applicant that this would go to City Council on August 5th.

5. **PUBLIC HEARING:** Scott Kirchner (Applicant) and Leroy Kowalke Et Al (Owner) requests that the City consider the following action for the Property located at 6551 County Road 6, Independence, MN (PID No. 34-118-24-12-0001):

a. A minor subdivision to allow a rural view lot subdivision. The proposed rural view lot would be 10 acres and located on the south side of County Road 6 along the east property line.

Kaltsas presented the request, noting that Scott Kirchner is now the owner as the sale has closed. The property is located on both the north and south sides of County Road 6, just west of the intersection with County Road 90. The property is currently vacant with wetlands, wooded areas, and upland pasture. It's zoned agriculture and guided for long-term agriculture, "just on the west side of our north south dividing line between rural residential and long term agriculture."

The property is approximately 71 acres in the before condition. The applicant is asking to split off a 10-acre parcel on the south side of County Road 6. In the after condition, there would be a 10-acre parcel on the south side and a remainder parcel of approximately 61 acres including property on both the north and south sides as well as some property south of the Luce Line Trail.

Kaltsas explained the city's rural view lot provisions: "for every 40 acres of contiguous land owned, you have the ability to realize 1 rural view lot density." Rural view lots must be between 2.5 and 10 acres, have minimum frontage on a public road (300 lineal feet for 5-10 acre lots), maintain a lot depth ratio of no more than 1:4, and have at least 2.5 acres of upland. The proposed lot meets all requirements with 10 acres, 839 feet of frontage, approximately 1:1.5 depth ratio, and nearly 100% upland.

Kaltsas noted requirements including an on-site septic report (to be provided before council consideration), obtaining driveway access from Hennepin County, park dedication, and providing drainage and utility easements for both properties. He mentioned that Hennepin County's engineer "said that they don't foresee any issue granting an access off of County Road 6."

Regarding future eligibility, Kaltsas stated, "the applicant would not have any rural view lot eligibilities in the future." He also noted the split property issue: "You're still going to have a property that has a north side and a south side bisected by County Road 6."

Commissioner Dumas asked about the triangle south of the Luce Line Trail and access issues. Scott Kirchner, the applicant, came forward to explain: "The triangle you're referencing is right there south of the Luce Line, so it does not encompass this proposed 10 acre parcel." He clarified they plan to build their home on the north side of County Road 6 on what they call "the north 40," while the triangle would remain as "god's country or hunting land."

Kirchner confirmed they're maintaining trail access and view it "as an amenity to the area and something that the community can enjoy." He had received email confirmation from the county approving driveway access for a single-family residence and would have septic sites identified after the hay is cut the following week. A wetland delineation confirmed no wetlands on the proposed 10-acre parcel.

Commissioner Dumas asked about access to the northern property. Kirchner explained it would be "on the southwest corner of the northern 40, right pretty much straight across from Ingerson" where there's an existing field drive, and the county has approved driveway access.

Kirchner then raised a point of disagreement about rural view lot eligibility, arguing that with County Road 6 dividing the property, the situation is comparable to 80 contiguous acres. He stated, "if you look at 80 contiguous acres, it doesn't have a county road running through the middle of it. That 80 contiguous acres could have a primary home and 2 rural view lots... But in this case, having County Road 6 running through the property... you would only end up with 2 roof lines potentially on the south side, and 1 on the north side being ours."

Chair Gardner asked if Kirchner would pursue two rural view lots if allowed, to which Kirchner replied, "Yeah. Absolutely." Discussion ensued about nominal 80s and 40s, with Gardner noting "none of these 80 acre parcels ever come up to be have 80 acres in them." He thought there would be wiggle room in the nominal status.

Kaltsas responded that someone could argue this is a nominal 80, noting it's unique with "multiple bites out of it from the roads." Including road right-of-ways, there's approximately 78 acres total. He mentioned they've done some nominal 40s previously but wasn't sure about 80s specifically.

The discussion continued about precedent and interpretation versus hardship. Timothy Usset stated, "I guess I would say that's not what we're considering. That's not on the written proposals."

Chair Gardner suggested, "you're always welcome to come back in and ask for another one in the future." After further debate about whether to include the restriction about future eligibility, Usset stated he would "make the motion to approve it as written, but I think we just need to keep the issue separate."

Chair Gardner opened the public hearing. No members of the public came forward to speak.

Motion by Leith Dumas, seconded, to close the public hearing. Motion carried unanimously.

Motion by Timothy Usset to recommend approval of the minor subdivision to allow a rural view lot located at 6551 County Road 6, subject to staff recommendations 1 and 2, inclusive of 2a through e. Motion seconded by Robert Gardner. Motion carried unanimously. 5-0

Kaltsas noted this would go to City Council on August 5th, clarifying that the meeting time is 5 o'clock due to the Night to Unite celebration.

6. Open/Misc.

There was brief discussion about the changed meeting time for the August 5th City	Council
meeting, but no other business was brought forward.	

7. Adjourn.

Motion by Tearse, seconded by Usset to adjourn the meeting at 8:28pm. Motion Approved. 5-0

Respectfully Submitted,

Amber Simon/Recording Secretary



# CITY COUNCIL MEETING MINUTES TUESDAY JULY 15, 2025

### **CITY COUNCIL MEETING TIME: 6:30 PM**

1. Call to Order

Mayor Brad Spencer called the meeting to order on Tuesday, September 02, 2025, at 6:30 PM

2. Pledge of Allegiance

Mayor Spencer led the Pledge of Allegiance.

3. ROLL CALL

PRESENT: Spencer, McCoy, Betts, Fisher, Grotting

ABSENT: None

STAFF: City Administrator Kaltsas, Administrative Services Director Simon,

Public Works Supervisor Ben Lehman, WHPS Chief DuRose

VISITORS: See Sign in Sheet

4. \*\*\*\*Consent Agenda\*\*\*\*

Mayor Spencer stated that the consent agenda items would be considered routine and acted on by one motion unless someone would like to remove an item for discussion. The consent agenda

- a. Approval of City Council Minutes from the July 30, 2025, City Council Workshop.
- b. Approval of City Council Minutes from the August 19, 2025, Regular City Council Meeting and Public hearing on Lake Independence.
- c. Approval of Accounts Payable; (Batch #1 Checks No. 23884-23904).
- d. Large Assembly Permit: 2026 Copeland Road Private Wedding September 13, 2025.
- 5. Reports of Boards and Committees by Council and Staff.
- 6. Lake Minnetonka Communications Commission 2026 Approved Budget. The 2026 Budget is presented for information only.

# Mayor Spencer (Administration)

entertain a motion for approval of the consent agenda? So Move to approve. Alright. Well, we'll move by McCoy, seconded by Betts. All in favor signify by saying aye. Aye.

.

# Mayor Spencer (Administration)

Now let's do boards and committee meetings, reports of meetings. Brad?

٠

# Mayor Spence r(Administration)

I just have the joint meeting with Maple Plain. I was unable to watch the golf ball tournament, unfortunately. Oh. Yeah. You missed that. I real nailed it. I yeah. I'm not tell you how it ended. I saw the big Well, if you left at the end of the fifth inning, the firefighters would have won at 20 to 10, but they didn't. What was the ump bias? The ump was an ex chief, and the West African public safety triumphed 22 to 20 in a big comeback. Wow. Yeah. So, it was very exciting. Was there a good was enjoyed by all. Did the police have a good picture?

You know, he was pretty good, but you know what he really did is he flipped the last out to first base. That was a big play right there for the for the big w. You know? The police pitcher was given some feedback by his teammates for next year. Oh, okay. Well, it's good to know. I would say that Encouragement. Right? Yeah. The police pitcher was probably at a little bit less wild loft than the fire pitcher. I would say that. He had a little altitude problem sometimes. Believe that was How about you, Lynn? Any meetings? I did the joint council meeting with Maple Plain. Alright.

# Council member McCoy (Administration)

Joint council with Maple Plain and attended the West Suburban Fire family fun night up in Hamel. That was a good time. Nice. Yeah. That is a fun event. Alright.

# Mayor Spencer (Administration)

Council member Grotting. Joint council meeting. Okay.

Uh, my meetings, I went to, uh, the memorial service for Larry Bartels, who passed away. He's a former council member and a longtime servant in Delmonel.

# Mayor Spencer (Administration)

The joint council meeting on the fire district merger on the 20 first. I did, of course, attend the first responder softball game on the 20 fifth. And then I had the I had the honor to be a witness of the reading to the children by the chief-by-chief DuRose and chief Dennison, which was absolutely stunning. So, we had a good turnout, lots of kids. It was fun. I I I am amazed the turnout on that. It was great. It was very good. You guys did a fabulous job. Thank you. Thank you. We're representing. Is that the main plain library? Oh, it was, uh, like, a Friday or something at lunchtime or Thursday or something. Wednesday story time. Yeah. There're quite a few kids there. So, we've got pictures, so we can document them. Amber?

# Mayor Spencer (Administration)

Any meetings? No. Mark?

## Council member McCoy (Administration)

I had 2 meetings other than the ones that were mentioned. 1 with a lobbyist group that we're talking to for that Highway 12 project, and we're gonna meet with some groups on Thursday

after the coalition meeting to kind a talk through and see if there's something that we can do. So that was actually a really good meeting. And today, met with the kind a Maple Plain fire team and the and the attorney who's gonna help us do the transition docs and the new contract for Maple Plain Fire. So getting that ready. So just a couple of things with that. I think we're in good shape. Scott, the attorney on that? It is. It's Scott. Yep.

# Mayor Spencer (Administration)

K

# Mayor Spencer (Administration)

Okay. Well, thank you, everybody. Anyone have anything they want to add to the agenda for tonight?

# Mayor Spencer (Administration)

Alright. So, uh, Lake Minnetonka Communications or Cable Commission, uh, budget. Brad, you're the representative. You want to give us the bullet points on this thing? Yeah. I won't read you through all the numbers, but if you look at the chart that Jim prepared,

# Council member Fisher (Administration)

we did 2 different columns for 26, and that was obviously if the sale went through on the existing building versus if it did not. At this point, we just had an update. I got an update from Jim today that the purchase agreement should now be finally accepted, and they have a nonrefundable earnest money attached to that as of the final acceptance date. So, it should go forward and close within 90 days. So it'll be close to the end of the year, obviously.

They are already preparing the Long Lake facility to move into it as far as some I know there were some demo and different things they had to do to get it set up. The primary difference here, and I don't know if you guys are aware, but Jim Lundberg will be retiring at the end of the year. And so that's biggest thing is Tyler will be taking over. So when you'll see the salary differences, when it says franchise salaries, if you look below it under peg, that's where the salary now falls. Okay. And peg, and that's where we Jim put them for this.

Otherwise, it's just basically showing you the 2 different costs and obviously getting out of the current facility, you're not gonna have things like utilities because they're all included with the rent, refuse and recycling, all that's covered within the existing rent. So that's why the 1 column on the far right is less in cost in some way, but now you have rent, which is 25000 dollars Right. A year based on the rent there, which is pretty reasonable. Yeah.

Yeah. So overall, it looks like the budget will be positive for next year without having to use additional funds. And then the revenue from the sale of the building, which they own, will be just put off to the side to cover different costs. And there will be about estimate of about a hundred and 20000 dollars to move between the 2 facilities. So that will come out of the proceeds from that sale. Okay. And Jim's still goanna retire even though the sale of the building occurred? Yeah. I had spoken to him 1 on 1 after the last meeting and he still wishes to think that's the best for the group that he should step away. Know? It's been a long time that he's been He's done yeah. The little bit of time that I've been exposed, you guys have been exposed much longer. I mean, what a professional. What a great gentleman and very organized and everything else. But if you notice franchise frese, excuse me, keep dropping. Oh, like you said. And so that's the challenge with it is that it's and that's what Jim's point is, is that as it goes forward, we're goanna see less and less revenue unless something changes with being able to charge peg fees on

Internet, which you can't do. Correct. So, you know, what a lot of people don't understand is that the fees that we receive from Mediacom are based only on the cable subscribers, not the Internet access subscribers. So that people could continue to use Mediacom for their Internet sources and just drop off the cable, which is what's happening, cable cord cutting, and revenues just keep going. So yep. There's really not much they can do about it. You know, Mediacom, even when I disconnected the other day, they argued that they're really not in the cable business anymore. Right. Um, it's a interesting challenge. It's sad to see Jim go. Okay.

# Mayor Spencer (Administration) Alright.

# Mayor Spencer (Administration)

Alright. So you wanted a motion to approve this budget? Sure. Why not? Go ahead. I'll make a motion to approve that. Alright. Motion by Fisher. Is there a second? Second. Seconded by Betts. All in favor signify by saying aye. Aye. Opposed same sign. Motion carried.

# Mayor Spencer (Administration)

Anything from the chief? I have nothing tonight, Mr. Mayor. Well, there is being no further items on the agenda. I take entertain a motion to adjourn. So moved. Moved by McCoy. Seconded. Seconded by Grotting. All in favor signify by saying aye. Aye. Opposed same sign. Motion is adjourned.

included the following items:

Motion by Councilmember Fisher, seconded by Councilmember Betts, to approve the consent agenda. All in favor. Motion carried. 5-0

## 5. Adjourn.

Anything from the chief? I have nothing tonight, Mr. Mayor. Well, there is being no further items on the agenda. I take entertain a motion to adjourn. So, moved. Moved by McCoy. Seconded. Seconded by Grotting. All in favor signify by saying aye. Aye. Opposed same sign. Motion is adjourned.

# City of Independence

# Request for an Amendement to the Conditional Use Permit to Allow the Upgrade and Replacement of Antennas and Ground Equipment on the Existing Telecommunications Tower

To: | Planning Commission

From: Mark Kaltsas, City Planner

Meeting Date: | September 16, 2025

Applicant: AT&T Wireless

Owner: Delano United Methodist Church

Location: 3310 County Line Road

# Request:

AT&T (Applicant) requests that the City consider the following action for the property located at 3310 County Line Road, Independence, MN (PID No. 07-118-24-33-0004):

a. A conditional use permit amendment to allow the upgrade and replacement of cellular antennas on the existing wireless tower and ground equipment located on the subject property.

# Property/Site Information:

The property is located on the east side of County Line Road, just north of TH 12. The property is comprised of the existing church building and parking lot, open space and wetlands. The property has the following characteristics:

Property Information for 3310 County Line Road

Zoning: Agriculture

Comprehensive Plan: Agriculture

Acreage: 6.89 Acres




### Discussion:


The City has received an application from AT&T to replace/upgrade several antennas, radio equipment and ground equipment on the existing wireless communications tower located on the subject property. There are currently two (2) different carriers on the existing tower. The City initially issued a conditional use permit to allow the construction of this wireless communications tower in 2001. The city approved an amendment to the ATT conditional use permit in 2019 to allow the replacement and upgrade of existing antennas on the tower. A condition of that amendment (and all new CUPs for wireless communications towers) requires any increase or expansion in the number and/or size of the antennas, radios or base equipment to obtain an amendment to the conditional use permit.


The city has reviewed the application and would note that the applicant is proposing the following changes:

- Relocate 3 existing antennas
- Install 3 new antennas
- Remove 12 existing RRH radios
- Install 6 new RRH radios
- Install 3 new RRU radios
- Install 6 new filters
- Install new DC trunk cable
- Install new baseband XMU on existing cabinet

The applicant is proposing to replace and or relocate the antennas/radios as noted above. currently on the tower. In addition, the applicant is proposing to install a new xmu on the base cabinet along with a new trunk cable. Considering an amendment to the conditional use permit will help the city to track and document the equipment on the tower and at the base that is associated with AT&T in order to maintain a clear record of approved equipment. The city should note the before and after images providing further detail below.

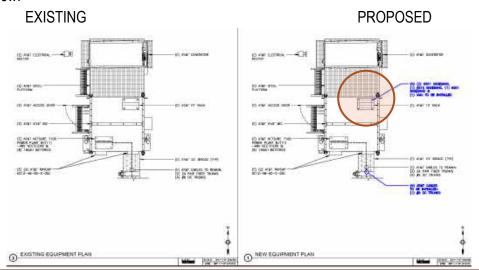

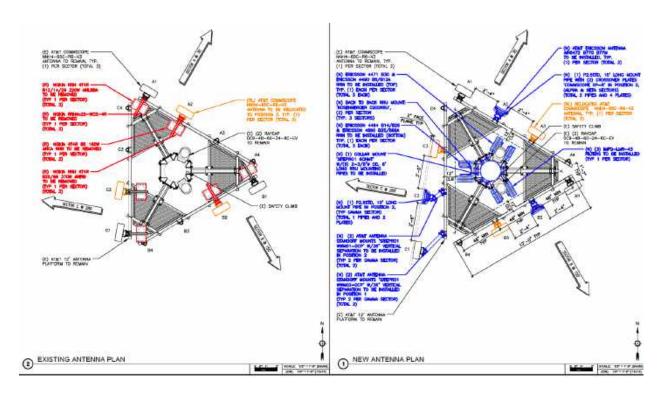

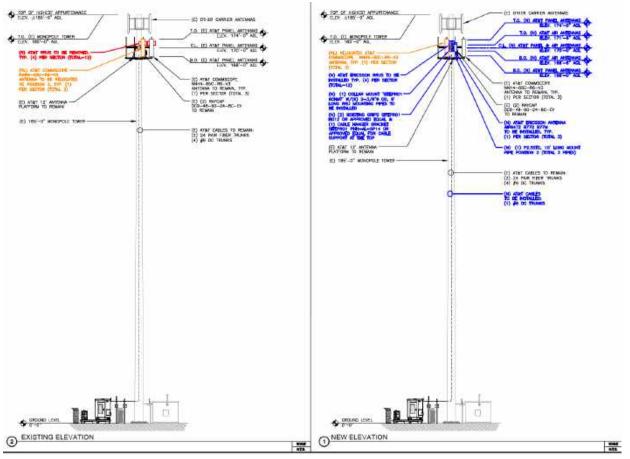

The applicant has provided the City with a structural analysis done by a third-party engineer which confirms that the tower can accommodate the proposed equipment changes.

Any amendment to an existing CUP must meet the same requirements established for granting a new CUP. The criteria for granting a conditional use permit are clearly delineated in the City's Zoning Ordinance (Section 520.11 subd. 1, a-i) as follows:

- 1. The conditional use will not adversely affect the health, safety, morals and general welfare of occupants of surrounding lands.
- 2. The proposed use will not have a detrimental effect on the use and enjoyment of other property in the immediate vicinity for the proposes already permitted or on the normal and orderly development and improvement of surrounding vacant property for uses predominant in the area.
- 3. Existing roads and proposed access roads will be adequate to accommodate anticipated traffic.
- 4. Sufficient off-street parking and loading space will be provided to serve the proposed use.
- 5. The proposed conditional use can be adequately serviced by public utilities or on-site sewage treatment, and sufficient area of suitable soils for on-site sewage treatment is available to protect the city form pollution hazards.
- 6. The proposal includes adequate provision for protection of natural drainage systems, natural topography, tree growth, water courses, wetlands, historic sites and similar ecological and environmental features.
- 7. The proposal includes adequate measures to prevent or control offensive odor, fumes, dust, noise, or vibration so that none of these will constitute a nuisance.
- 8. The proposed condition use is consistent with the comprehensive plan of the City of Independence.
- 9. The proposed use will not stimulate growth incompatible with prevailing density standards.

The proposed improvements are consistent with upgrades to other similar towers and will allow for transmission of new technology. The overall visual impact will be minor due to this being a replacement of existing antennas. The existing tower has a conditional use permit. The City will need to determine if the requested amendment to the conditional use permit meet all of the aforementioned conditions and restrictions.

# **Neighbor Comments:**

The City has not received any written comments regarding the proposed amendment to the conditional use permit, site plan approval or variance.

## Recommendation:

The Planning Commission is being asked to consider approval of the request for an amendment to the

conditional use permit. Should the Planning Commission recommend approval to the City Council, the following findings and conditions should be included:

- The proposed conditional use permit amendment meets all applicable conditions and restrictions stated Chapter V, Section 510, Zoning, in the City of Independence Zoning Ordinance.
- 2. The conditional use permit amendment shall include the following additional conditions:
  - a. The conditional use permit shall be reviewed annually by the City.
  - b. This amendment approves the changes shown on the approved plans. The antennas shall be installed in accordance with the approved plans and elevations attached hereto as EXHIBIT B.
  - c. The City can administratively approve any replacement of existing antennas. Any expansion or increase to the size of the existing ground equipment, buildings or number of antennae will be subject to the City's review and an amendment to the conditional use permit.
- 3. The applicant shall pay for all costs associated with the City's review and processing of the requested amendment to the conditional use permit and site plan review.
- 4. The City Council may revoke the conditional use permit if the applicant violates any of the conditions set forth in the conditional use permit.

## Attachments:

- 1. Application
- 2. Proposed Plan Set
- 3. Third Party Structural Verification Letter

## **CODE COMPLIANCE**

ALL WORK AND MATERIALS SHALL BE PREFORMED AND INSTALLED IN CCORDANCE WITH THE CURRENT EDITIONS OF THE FOLLOWING CODES AS ADOPTED BY THE LOCAL GOVERNING AUTHORITIES. NOTHING IN THESE PLANS S TO BE CONSTRUED TO PERMIT WORK NOT CONFORMING TO THESE CODES

UILDING CODE LUMBING CODE ECHANICAL CODE: LECTRICAL CODE: IRE & SAFETY CODE

2020 MINNESOTA BUILDING CODE 2020 MINNESOTA PLUMBING CODE 2020 MINNESOTA MECHANICAL CODE

2020 MINNESOTA ELECTRICAL CODE 2020 MINNESOTA FIRE CODE

### PROJECT TEAM

APPLICANT AT&T NORTHERN PLAINS (MNP) 7900 XERXES AVE S BLOOMINGTON, MN 55431

SITE ACQUISITION:

SMARTLINK

CONTACT: JACQUELYN SPOHR JACQUELYN.SPOHR@SMARTLINKGROUP.COM

ARCHITECT

ENGINEERING

JOHN M. BANKS 604 FOX GLEN BARRINGTON, IL 60010

CONTACT: JOHN M. BANKS PHONE: (847) 277-0070

EMAIL: JBANKS@WESTCHESTERSERVICES.COM

CONSTRUCTION MANAGER

MASTEC SOLUTIONS CONTACT: CHRISTOPHER WATSON

EMAIL: CHRISTOPHER.WATSON2@MASTEC.COM

LTE 1C RRH SWAP JOB TYPE:

SITE NAME: **DELANO COUNTY LINE FA LOCATION:** 11571089

SITE ID: MNL01123

SITE ADDRESS: 3310 COUNTY LINE RD SE

**DELANO, MN 55328** 

**STRUCTURE: 185'-0" MONOPOLE TOWER** 

IWM JOB #: WSUMW0046561. WSUMW0045944. WSUMW0046146. WSUMW0046150.

WSUMW0046191, WSUMW0046318, WSUMW0046380, WSUMW0046387,

WSUMW0046604

PACE JOB #: MRUMW086751, MRUMW085959, MRUMW086057, MRUMW088659,

MRUMW086785, MRUMW088461, MRUMW086393, MRUMW086508,

MRUMW086076

PTN #: 3511A1G8FG 3511A1G6YB, 3511A1G8D1 3511A1G7VV, 3511A1G8B5,

3511A1G6YC, 3511A1G8K9, 3511A1G8P6, 3511A1G684

USID #: 229192

# SHEET INDEX

TITLE SHEE

GN-1 GENERAL NOTES SITE PLAN

**EXISTING & NEW EQUIPMENT PLANS** A-2 EXISTING & NEW ANTENNA PLANS

**EXISTING & NEW ELEVATIONS** 

RF-1 ANTENNA SCHEDULE

RF-2 PLUMBING DIAGRAM D-1 DETAILS

D-2 DETAILS

D-3 DETAILS DETAILS

GROUNDING PLANS & NOTES

### SITE INFORMATION

ANDLORD SITE NAME:

STRUCTURE LANDLORD: THE DELANO UNITED METHODIST CHURCH DELANO COUNTY LINE

LANDLORD SITE NUMBER: MNL01123

CONTACT: EMAIL: CHADKOPPES@DELANOUMC.COM

EMAIL: DELANOUMC@GMAIL.COM

JURISDICTION CITY OF INDEPENDENCE

PARCEL #:

EXISTING USE:

ATITUDE (NAD 83):

0711824330004

45.037277

T.B.D.

CURRENT ZONING

COMMUNICATIONS FACILITY

PROPOSED USE: COMMUNICATIONS FACILITY

ONGITUDE (NAD 83): -93.765194°

SITE GROUND ELEVATION: 970' AMSL

OVERALL HEIGHT: +185'-0" AGI

POWER PROVIDER: TRD

FIBER PROVIDER: T.B.D.

ACCESSIBILITY REQUIREMENTS: FACILITY IS UNMANNED AND NOT FOR HUMAN HABITATION. ACCESSIBILITY IS NOT REQUIRED.

# REFERENCE NOTES

THESE PLANS WERE COMPLETED PER FINAL/APPROVED LTE 4C(FIRSTNET)/5G NR RADIO/5G NR 1SR CBAND RFDS ID# T.B.D. V:7.00 DATED

CONTRACTOR SHALL REQUEST CURRENT RFDS & WORKBOOK FROM CONSTRUCTION MANAGER PRIOR TO CONSTRUCTION

GC SHALL REVIEW AND COMPLY WITH MOUNT STRUCTURAL ANALYSIS DATED: XX/XX/XXXX

PROJECT # 3511A1G8FG

GC SHALL REVIEW AND COMPLY WITH TOWER STRUCTURAL ANALYSIS

# **VICINITY MAP**

SAT&T

SITE

# LOCAL MAP

# DRIVING DIRECTIONS

SCAN FOR DRIVING DIRECTIONS



## **GENERAL NOTES**

**GENERAL CONTRACTOR NOTES** 

THESE PLANS ARE FORMATTED TO BE FULL SIZE AT 24" x 36" CONTRACTORS SHALL VERIFY ALL PLANS AND EXISTING DIMENSIONS AND CONDITIONS ON THE JOB SITE AND SHALL IMMEDIATELY

NOTICY THE ARCHITECT/ENGINEER IN WRITING OF ANY DISCREPANCIES REFORE PROCEEDING THE WORK OR MATERIAL ORDERS OR BE RESPONSIBLE FOR THE SAME

DO NOT SCALE THESE DRAWINGS

THE FACILITY IS UNMANNED AND NOT FOR HUMAN HABITATION. A TECHNICIAN WILL VISIT THE SITE AS REQUIRED FOR ROUTINE MAINTENANCE. THE PROJECT WILL NOT RESULT IN ANY SIGNIFICANT DISTURBANCE OR EFFECT ON DRAINAGE, NO SANITARY SEWER SERVICE, POTABLE WATER, OR TRASH DISPOSAL IS REQUIRED AND NO COMMERCIAL SIGNAGE IS PROPOSED

## **STATEMENTS**

STRUCTURAL ANALYSIS IS NOT WITHIN THE SCOPE OF WORK CONTAINED IN THE DRAWINGS SET FOR ANALYSIS OF EXISTING AND/OR PROPOSED COMPONENTS, REFER TO STRUCTURAL ANALYSIS PROVIDED LINDER SEPARATE COVER

ANTENNA MOUNT ANALYSIS IS NOT WITHIN THE SCOPE OF WORK CONTAINED IN THIS DRAWING SET. FOR ANALYSIS OF MOUNT TO SUPPORT EXISTING AND/OR PROPOSED COMPONENTS, REFER TO ANTENNA MOUNT STRUCTURAL ANALYSIS PROVIDED UNDER SEPARATE COVER.



TO OBTAIN LOCATION OF PARTICIPANTS UNDERGROUND FACILITIES BEFORE YOU DIG IN MINNESOTA. CALL GOPHER STATE ONE CALL

TOLL FREE: 1-800-252-1166 OR FAX A LOCATE: 1-800-236-4967

www.gopherstateonecall.org

Know what's below. Call before you dig.

MINNESOTA STATUTE REQUIRES MIN OF 48 HOURS NOTICE BEFORE YOU **EXCAVATE** 

# PROJECT DESCRIPTION

MODIFICATION TO AN UNMANNED TELECOMMUNICATIONS FACILITY. ASED ON DE130 SCOPING DATED 09/19/2024 CONSISTING OF THE FOLLOWING SCOPE:

### ANTENNA LOCATION:

(3) NOKIA RRH 4T4R B12/14/29 AHLBBA

(3) NOKIA RRH4X25-WCS-4R (3) NOKIA RRH 4T4R B5 AHCA

(3) NOKIA RRH 4T4R B25/66 AHFIE

(3) ERICSSON AIR6472 B77G B77M ANTENNAS IN POSITION 2

(3) P2.5STD 10' LONG MOUNTING PIPES IN POSITION 2 (4) CROSSOVER PLATES 'COMMSCOPE XP-R' IN POSITION 2

(3) ERICSSON RRU 4471 B30 FOR POSITION 1

(3) ERICSSON RRU 4490 B5/B12A FOR POSITION

(3) ERICSSON RRU 4494 B14/B29 FOR POSITION 3

(3) ERICSSON RRU 4890 B25/B66A FOR POSITION 3 (3) IMFQ-LMR-43 FILTERS

(6) RRU DUAL MOUNT BRACKETS 'ROSENBERGER D200RRU' (1) RRU COLLAR MOUNT 'SITEPRO1 6CHMT'

(6) 2-3/8"Ø OD 6' LONG RRU MOUNTING PIPES

(2) ANTENNA STANDOFFS 'SITEPRO1 WWM02-DCP' IN POSITION 1 (GAMMA SECTOR)

(2) ANTENNA STANDOFFS 'SITEPRO1 WWM01-DCP' IN POSITION 2 ( GAMMA SECTOR)

(2) HOISTING GRIPS SITEPRO1 HG12 (1) CABLE HANGER BRACKET SITEPRO1 PHH-AL-SP14

(3) COMMSCOPE NNH4-65C-R6-V3 ANTENNAS FROM POSITION 2 TO POSITION 3

EXISTING TO RE-USE:

(3) COMMSCOPE NNH4-65C-R6-V3 ANTENNAS FROM IN POSITION 1

(2) RAYCAP DC9-48-60-24-8C-EV SURGE SUPPRESSOR

(1) 12' ANTENNA PLATFORM

# EQUIPMENT LOCATION:

# ALL NOKIA BBU:

# (2) 6651 BASEBAND

- (1) 6610 BASEBAND
- (1) 6601 BASEBAND
- (1) #6 DC TRUNK ADDITIONAL BREAKERS AS NEEDED PER ATT-CEM-18002 BBU INFORMATION TO BE FINALIZED PRIOR TO CONSTRUCTION

- EXISTING TO RE-USE:

  (1) NETSURE 7100 POWER PLANT
  (11) -48VDC RECTIFIERS
- (8) 190AH BATTERIES (2) RAYCAP DC12-48-60-0-25E
- (4) #6 DC TRUNKS

ANY DEVIATION THAT DIFFERS SUBSTANTIALLY FROM WHAT IS SHOWN ON THE CONSTRUCTION DRAWINGS MUST BE APPROVED BY THE ENGINEER OF RECORD. NO CHANGES THAT ALTER THE CHARACTER OF THE WORK CAN BE MADE DURING CONSTRUCTION WITHOUT ISSUING A CHANGE ORDER. CONTACT JOHN BANKS - JBANKS@WESTCHESTERSERVICES.COM







604 FOX GLEN BARRINGTON, IL 60010 PHONE: 847-277-0070 EMAIL: AE@Westchesterservices.com

# JOHN M. BANKS ARCHITECT

604 FOX GLEN
BARRINGTON, IL 60010
TELEPHONE: 847-277-0070 : JBANKS@WESTCHESTERSERVICES.COM

	REVISIONS								
REV.	REV. DATE DESCRIPTION								
Α	01/13/25	ISSUED FOR REVIEW	SH						
В	02/18/25	ISSUED FOR REVIEW	SH						

NOT FOR CONSTRUCTION UNLESS LABELED AS CONSTRUCTION SET

IS A VIOLATION OF LAW FOR ANY PERSONS UNLESS THEY ARE ACTING UNDER THE DIRECTION OF A LICENSED PROFESSIONAL ARCHITECT TO ALTER THIS DOCUMENT

"I HEREBY CERTIFY THAT THESE PLANS WERE PREPARED BY ME OR UNDER MY DIRECT SUPERVISION AND THAT I AM A DULY REGISTERED ARCHITECT UNDER THE LAWS OF THE STATE OF MINNESOTA"

SITE NUMBER: MNL01123 SITE NAME: DELANO COUNTY LINE FA#: 11571089 3310 COUNTY LINE RD SE DELANO, MN 55328

SHEET TITLE

TITLE SHEET

T-1

### GENERAL CONSTRUCTION NOTES:

- 1. PLANS ARE INTENDED TO BE DIAGRAMMATIC OUTLINE ONLY, UNLESS NOTED OTHERWISE. THE WORK SHALL INCLUDE FURNISHING MATERIALS, EQUIPMENT, APPURTENANCES AND LABOR NECESSARY TO COMPLETE ALL INSTALLATIONS AS INDICATED ON THE DRAWINGS.
- THE CONTRACTOR SHALL OBTAIN, IN WRITING, AUTHORIZATION TO PROCEED BEFORE STARTING WORK ON ANY ITEM NOT CLEARLY DEFINED OR IDENTIFIED BY THE CONTRACT DOCUMENTS.
- CONTRACTOR SHALL CONTACT USA (UNDERGROUND SERVICE ALERT) AT (800) 2477-2600, FOR UTILITY LOCATIONS, 48 HOURS BEFORE PROCEEDING WITH ANY EXCAVATION. SEE WORK OR CONSTRUCTION..
- 4. THE CONTRACTOR SHALL INSTALL ALL EQUIPMENT AND MATERIALS IN ACCORDANCE WITH MANUFACTURERS RECOMMENDATIONS UNLESS SPECIFICALLY INDICATED OTHERWISE, OR WHERE LOCAL CODES OR REGULATIONS TAKE PRECEDENCE.
- ALL CONSTRUCTION SHALL BE IN ACCORDANCE WITH THE UBC'S REQUIREMENTS REGARDING EARTHQUAKE RESISTANCE, FOR, BUT NOT LIMITED TO, PIPING, LIGHT FIXTURES, CEILING GRID, INTERIOR PARTITIONS, AND MECHANICAL EQUIPMENT. ALL WORK MUST COMPLY WITH LOCAL EARTHQUAKE CODES AND REGULATIONS.
- 6. REPRESENTATIONS OF TRUE NORTH, OTHER THAN THOSE FOUND ON THE PLOT OF SURVEY DRAWINGS, SHALL NOT BE USED TO IDENTIFY OR ESTABLISH BEARING OF TRUE NORTH AT THE SITE, THE CONTRACTOR SHALL RELY SOLELY ON THE PLOT OF SURVEY DRAWING AND ANY SURVEYOR'S MARKINGS AT THE SITE FOR THE ESTABLISHMENT OF TRUE NORTH, AND SHALL NOTIFY THE ARCHITECT/ENGINEER PRIOR TO PROCEEDING WITH THE WORK IF ANY DISCREPANCY IS FOUND BETWEEN THE VARIOUS ELEMENTS OF THE WORKING DRAWINGS AND THE TRUE NORTH ORIENTATION AS DEPICTED ON THE CIVIL SURVEY. THE CONTRACTOR SHALL ASSUME SOLE LIABILITY FOR ANY FAILURE TO NOTIFY THE ARCHITECT/ENGINEER.
- 7. THE BUILDING DEPARTMENT ISSUING THE PERMITS SHALL BE NOTIFIED AT LEAST TWO WORKING DAYS PRIOR TO THE COMMENCEMENT OF WORK, OR AS OTHERWISE STIPULATED BY THE CODE ENFORCEMENT OFFICIAL HAVING JURISDICTION.
- 8. DO NOT EXCAVATE OR DISTURB BEYOND THE PROPERTY LINES OR LEASE LINES, UNLESS OTHERWISE NOTED.
- ALL EXISTING UTILITIES, FACILITIES, CONDITIONS, AND THEIR DIMENSIONS SHOWN ON THE PLAN HAVE BEEN PLOTTED FROM AVAILABLE RECORDS. THE ARCHITECT/ENGINEER AND THE OWNER ASSUME NO RESPONSIBILITY WHATSOEVER AS TO THE SUFFICIENCY OR THE ACCURACY OF THE INFORMATION SHOWN ON THE PLANS, OR THE MANNER OF THEIR REMOVAL OR ADJUSTMENT. CONTRACTORS SHALL BE RESPONSIBLE FOR DETERMINING EXACT LOCATION OF ALL EXISTING UTILITIES AND FACILITIES PRIOR TO START OF CONSTRUCTION. CONTRACTORS SHALL ALSO OBTAIN FROM EACH UTILITY COMPANY DETAILED INFORMATION RELATIVE TO WORKING SCHEDULES AND METHODS OF REMOVING OR ADJUSTING EXISTING FACILITIES.
- 10. CONTRACTOR SHALL VERIFY ALL EXISTING UTILITIES, BOTH HORIZONTAL AND VERTICALLY. PRIOR TO THE START OF CONSTRUCTION, ANY DISCREPANCIES OR DOUBTS AS TO THE INTERPRETATION OF PLANS SHOULD BE IMMEDIATELY REPORTED TO THE ARCHITECT/ENGINEER FOR RESOLUTION AND INSTRUCTION, AND NO FURTHER WORK SHALL BE PERFORMED UNTIL THE DISCREPANCY IS CHECKED AND CORRECTED BY THE ARCHITECT/ENGINEER. FAILURE TO SECURE SUCH INSTRUCTION MEANS CONTRACTOR WILL HAVE WORKED AT HIS/HER OWN RISK AND EXPENSE.
- 11. ALL NEW AND EXISTING UTILITY STRUCTURES ON SITE AND IN AREAS TO BE DISTURBED BY CONSTRUCTION SHALL BE ADJUSTED TO FINISH ELEVATIONS PRIOR TO FINAL INSPECTION OF WORK.
- 12. ANY DRAIN AND/OR FIELD TILE ENCOUNTERED/DISTURBED DURING CONSTRUCTION SHALL BE RETURNED TO ITS ORIGINAL CONDITION PRIOR TO COMPLETION OF WORK. SIZE, LOCATION, AND TYPE OF ANY UNDERGROUND UTILITIES OR IMPROVEMENTS SHALL BE ACCURATELY NOTED AND PLACED ON "AS-BUILT" DRAWINGS BY GENERAL CONTRACTOR AND ISSUED TO THE ARCHITECT/ENGINEER AT COMPLETION OF PROJECT.
- 13. ALL TEMPORARY EXCAVATIONS FOR THE INSTALLATION OF FOUNDATIONS, UTILITIES, ETC...SHALL BE PROPERLY LAID BACK OR BRACED IN ACCORDANCE WITH CORRECT OCCUPATIONAL SAFETY AND HEALTH ADMINISTRATION (OSHA) REQUIREMENTS.
- 14. INCLUDE MISC. ITEMS PER AT&T SPECIFICATIONS


### APPLICABLE CODES, REGULATIONS AND STANDARDS:

- 1. SUBCONTRACTOR'S WORK SHALL COMPLY WITH ALL APPLICABLE NATIONS, STATE, AND LOCAL CODES AS ADOPTED BY THE LOCAL AUTHORITY HAVING JURISDICTION (AHJ) FOR THE LOCATION.
- 2. THE EDITION OF THE AHJ ADOPTED CODES AND STANDARDS IN EFFECT ON THE DATE OF CONTRACT AWARD SHALL GOVERN THE DESIGN.
- 3. SUBCONTRACTOR'S WORK SHALL COMPLY WITH THE LATEST EDITION F THE FOLLOWING STANDARDS:
- 3.1. AMERICAN CONCRETE INSTITUTE (ACI) 318, BUILDING CODE REQUIREMENTS FOR STRUCTURAL CONCRETE.
- 3.2. AMERICAN INSTITUTE OF STEEL CONSTRUCTION (AISC), MANUAL OF STEEL CONSTRUCTION, ASD, FIFTEENTH EDITION.
- 3.3. TELECOMMUNICATIONS INDUSTRY ASSOCIATION (TIA) 222-H, STRUCTURAL, STANDARD FOR STRUCTURAL ANTENNA TOWER AND ANTENNA SUPPORTING STRUCTURES.
- 3.4. INSTITUTE FOR ELECTRICAL AND ELECTRONICS ENGINEERS (IEEE) 81, GUIDE FOR MEASURING EARTH RESISTIVITY, GROUND IMPEDANCE, AND EARTH SUFFACE POTENTIALS OF A GROUND SYSTEM IEEE 1100 (1999) RECOMMENDED PRACTICE FOR POWERING AND GROUNDING OF ELECTRICAL EQUIPMENT.
- 3.5. IEEE C62.41, RECOMMENDED PRACTICES ON SURGE VOLTAGES IN LOW VOLTAGE AC POWER CIRCUITS (FOR LOCATION CATEGORY "C3" AND "HIGH SYSTEM EXPOSURE").
- 3.6. TIA 607 COMMERCIAL BUILDING GROUNDING AND BONDING REQUIREMENTS FOR TELECOMMUNICATIONS TELCORDIA GR-63 NETWORK.
- 3.7. EQUIPMENT BUILDING SYSTEM (NEB); PHYSICAL PROTECTION.
- 3.8. TELCORDIA GR-347 CENTRAL OFFICE POWER WIRING
- 3.9. TELCORDIA GR-1275 GENERAL INSTALLATION REQUIREMENTS
- 3.10. TELCORDIA GR-1503 COAXIAL CABLE CONNECTIONS.
- 3.11. ANY AND ALL OTHER LOCAL & STATE LAWS AND REGULATIONS.
- 3.12. FOR ANY CONFLICTS BETWEEN SECTIONS OF LISTED CODES AND STANDARDS REGARDING MATERIAL, METHODS OF CONSTRUCTION, OR OTHER REQUIREMENTS, THE MOST RESTRICTIVE SHALL GOVERN. WHERE THERE IS CONFLICT BETWEEN GENERAL REQUIREMENT AND A SPECIFIC REQUIREMENT, THE SPECIFIC REQUIREMENT SHALL GOVERN.

		ABBREVIATIONS:

A.B.	ANCHOR BOLT	EXP.	EXPANSION	P/C	PRECAST CONCRETE
A.BV.	ABOVE	EXST.	(E) EXISTING	PCS	PERSONAL COMMUNICATION
ACCA	ANTENNA CABLE COVER ASSEMBLY	FAB.	FABRICATION(OR)		SERVICES
ADD'L	ADDITIONAL	F.F.	FINISH FLOOR	PLY.	PLYWOOD
A.F.F.	ABOVE FINISHED FLOOR	F.G.	FINISH GRADE	PPC	POWER PROTECTION CABINET
A.F.G.	ABOVE FINISHED GRADE	FIN.	FINISH(ED)	PRC	PRIMARY RADIO CABINET
ALUM.	ALUMINUM	FLR.	FLOOR	P.S.F.	POUNDS PER SQUARE FOOT
ALT.	ALTERNATE	FLS.	FOUNDATION	P.S.I.	POUNDS PER SQUARE INCH
ANT.	ANTENNA	F.O.C.	FACE OF CONCRETE	P.T.	PRESSURE TREATED
APPRX.	APPROXIMATE(LY)	F.O.M.	FACE OF MASONRY	PLY.	POWER (CABINET)
ARCH.	ARCHITECT(URAL)	F.O.S.	FACE OF STUD	QTY.	QUANTITY
AWG.	AMERICAN WIRE GAUGE	F.O.W.	FACE OF WALL	RAD.	(R) RADIUS
BLDG.	BUILDING	F.S.	FINISH SURFACE	REF.	REFERENCE
BLK.	BLOCK	FT. (')	FOOT (FEET)	REINF.	REINFORCEMENT(ING)
BLKG.	BLOCKING	FTG.	FOOTING	REQ'D.	REQUIRED
BM.	BEAM	G.	GROWTH (CABINET)	RGS	RIGID GALVANIZED STEEL
B.N.	BOUNDARY NAILING	GA.	GAUGE	SCH.	SHEDULE
B.T.C.W.	BARE TINNED COPPER WIRE	GL.	GALVANIZE(D)	SHT.	SHEET
B.O.F.	BOTTOM OF FOOTING	G.F.I.	GROUND FAULT CIRCUIT	SIM.	SIMILAR
B/U	BACK-UP CABINET	G.F.I.	INTERRUPTER	SPEC.	SPECIFICATIONS
CAB.	CABINET	GLB (GLILLAM)	GLUE LAMINATED BEAM	SQ.	SQUARE
CAD.	CANTILEVER(ED)	G.P.S.	GLOBAL POSITIONING SYSTEM	S.S.	STAINLESS STEEL
C.I.P.	CAST IN PLACE	GRND.	GROUND	STD.	STANDARD
CLG.	CEILING	HDR.	HEADER	STL.	STEEL
CLG.	CLEAR	HGR.	HANGER	STRUC.	STRUCTURAL
COL.	COLUMN	HT.	HEIGHT	TEMP.	TEMPORARY
CONC.	CONCRETE	ICGB.	ISOLATED COPPER GROUND BUS	THK.	THICK(NESS)
CONN.	CONNECTION(OR)	IN. ( ")	INCH(ES)	T.N.	TOE NAIL
CONST.	CONSTRUCTION	INT.	INTERIOR	T.O.A.	TOP OF ANTENNA
CONT.	CONTINUOUS	LB. (#)	POUND(S)	T.O.C.	TOP OF CURB
d d	PENNY (NAILS)	L.B. (#)	LAG BOLTS	T.O.F.	TOP OF FOUNDATION
DBL.	DOUBLE	L.F.	LINEAR FEET (FOOT)	T.O.P.	TOP OF PLATE (PARAPET)
DEPT.	DEPARTMENT	L.	LONG(ITUDINAL)	T.O.S.	TOP OF STEEL
D.F.	DOUGLAS FIR	MAS.	MASONRY	T.O.W.	TOP OF WALL
DIA.	DIAMETER	MAX.	MAXIMUM	TYP.	TYPICAL
DIAG.	DIAGONAL	M.B.	MACHINE BOLT	U.G.	UNDERGROUND
DIM.	DIMENSION	MECH.	MECHANICAL	U.L.	UNDERWRITERS LABORATORY
DWG.	DRAWING(S)	MFR.	MANUFACTURER	U.N.O.	UNLESS NOTIFIED OTHERWISE
DWL.	DOWEL	MIN.	MINIMUM	V.I.F.	VERIFY IN FIELD
EA.	EACH	MISC.	MISCELLANEOUS	W	WIDE (WIDTH)
EL.	ELEVATION	MTL.	METAL	w/	WITH
ELEC.	ELECTRICAL		NEW		
ELEV.	ELEVATION	(N)		WD. W.P.	WOOD
E.M.T.	ELECTRICAL METALLIC TUBING	NO. (#) N.T.S.	NUMBER NOT TO SCALE		WEATHERPROOF
E.M. I . E.N.	EDGE NEAR	N.T.S. O.C.	ON CENTER	WT.	WEIGHT
E.N. ENG.	ENGINEER	O.C. OPNG.	ON CENTER  OPENING	Œ B	CENTERLINE
ENG. EQ.	EQUAL		PROPOSED	ዊ	PLATE, PROPERTY LINE
ĽŲ.	EQUAL	(P)	PRUPUSED		

### SYMBOLS LEGEND:

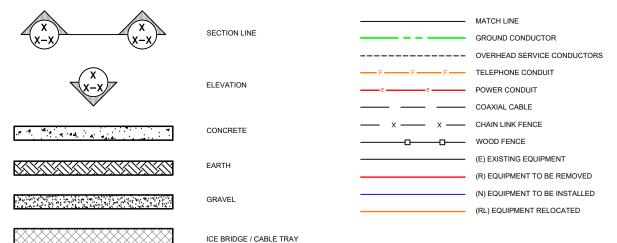







604 FOX GLEN
BARRINGTON, IL 60010
PHONE: 847-277-0070
EMAIL: AE@Westchesterservices.com

# JOHN M. BANKS ARCHITECT

604 FOX GLEN
BARRINGTON, IL 60010
TELEPHONE: 847-277-0070
EMAIL: JBANKS@WESTCHESTERSERVICES.COM

	R	REVISIONS	
REV.	DATE	DESCRIPTION	BY
A	01/13/25	ISSUED FOR REVIEW	SH
В	02/18/25	ISSUED FOR REVIEW	SH
		CONSTRUCTION UNLESS S CONSTRUCTION SET	

T IS A VIOLATION OF LAW FOR ANY PERSONS
UNLESS THEY ARE ACTING UNDER THE
DIRECTION OF A LICENSED PROFESSIONAL
ARCHITECT TO ALTER THIS DOCUMENT

"I HEREBY CERTIFY THAT THESE PLANS WERE PREPARED BY ME OR UNDER MY DIRECT SUPERVISION AND THAT I AM A DULY REGISTERED ARCHITECT UNDER THE LAWS OF THE STATE OF MINNESOTA"


SITE NUMBER: MNL01123 SITE NAME: DELANO COUNTY LINE FA#: 11571089 3310 COUNTY LINE RD SE DELANO, MN 55328

SHEET TITLE

**GENERAL NOTES** 

SHEET NUMBE

GN-

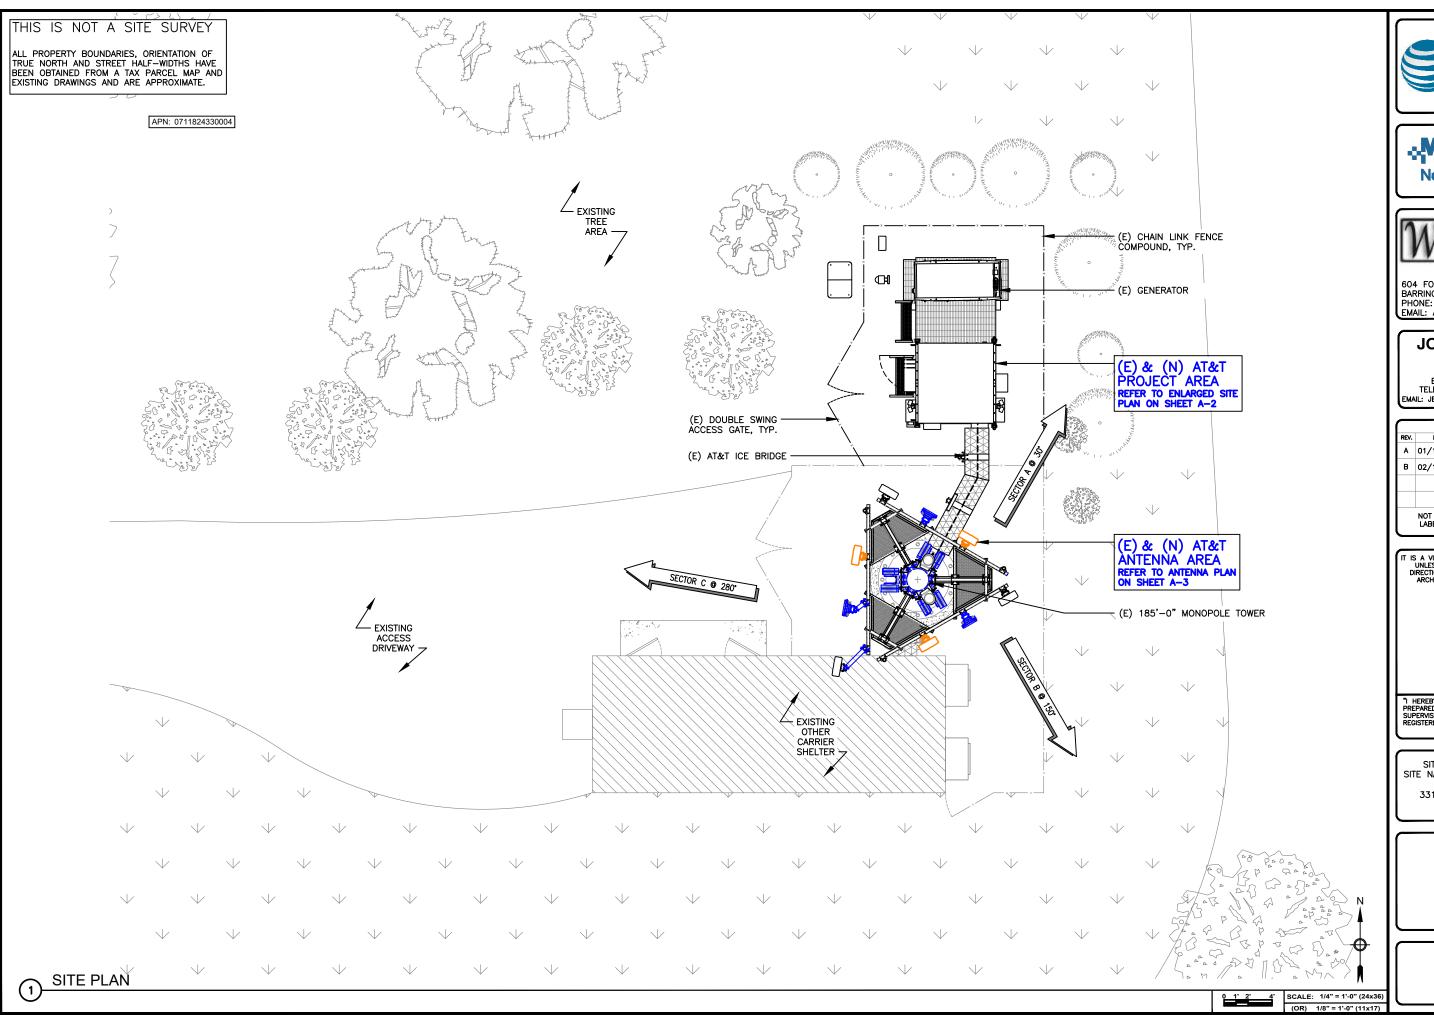







604 FOX GLEN
BARRINGTON, IL 60010
PHONE: 847-277-0070
EMAIL: AE@Westchesterservices.com

# JOHN M. BANKS ARCHITECT

604 FOX GLEN
BARRINGTON, IL 60010
TELEPHONE: 847-277-0070
EMAIL: JBANKS@WESTCHESTERSERVICES.COM

lí		REVISIONS								
	REV.	DATE	DESCRIPTION	BY						
	Α	01/13/25	ISSUED FOR REVIEW	SH						
	В	02/18/25	ISSUED FOR REVIEW	SH						

NOT FOR CONSTRUCTION UNLESS LABELED AS CONSTRUCTION SET

IT IS A VIOLATION OF LAW FOR ANY PERSONS UNLESS THEY ARE ACTING UNDER THE DIRECTION OF A LICENSED PROFESSIONAL ARCHITECT TO ALTER THIS DOCUMENT

"I HEREBY CERTIFY THAT THESE PLANS WERE PREPARED BY ME OR UNDER MY DIRECT SUPERVISION AND THAT I AM A DULY REGISTERED ARCHITECT UNDER THE LAWS OF THE STATE OF MINNESOTA"

SITE NUMBER: MNL01123 SITE NAME: DELANO COUNTY LINE FA#: 11571089 3310 COUNTY LINE RD SE DELANO, MN 55328

SHEET TITLE

SITE PLAN

SHEET NUMBER

**A-1** 

ADDITIONAL SCOPE: REMOVE ALL NOKIA BBU

**EXISTING EQUIPMENT PLAN** 

ADDITIONAL SCOPE:

INSTALL BREAKERS AS NEEDED PER ATT-CEM-18002 BBU INFORMATION TO BE FINALIZED PRIOR TO

**MasTec Network Solutions** 



604 FOX GLEN BARRINGTON, IL 60010 PHONE: 847-277-0070 EMAIL: AE@Westchesterservices.com

# JOHN M. BANKS **ARCHITECT**

604 FOX GLEN
BARRINGTON, IL 60010
TELEPHONE: 847-277-0070 EMAIL: JBANKS@WESTCHESTERSERVICES.COM

$\cap$	REVISIONS								
REV.	DATE DESCRIPTION								
Α	01/13/25	ISSUED FOR REVIEW	SH						
В	02/18/25	ISSUED FOR REVIEW	SH						
NOT FOR CONSTRUCTION UNLESS LABELED AS CONSTRUCTION SET									

I IS A VIOLATION OF LAW FOR ANY PERSONS
UNLESS THEY ARE ACTING UNDER THE
DIRECTION OF A LICENSED PROFESSIONAL
ARCHITECT TO ALTER THIS DOCUMENT

"I HEREBY CERTIFY THAT THESE PLANS WERE PREPARED BY ME OR UNDER MY DIRECT SUPERVISION AND THAT I AM A DULY REGISTERED ARCHITECT UNDER THE LAWS OF THE STATE OF MINNESOTA"

SITE NUMBER: MNL01123 SITE NAME: DELANO COUNTY LINE FA#: 11571089 3310 COUNTY LINE RD SE DELANO, MN 55328

SHEET TITLE


**EXISTING & NEW EQUIPMENT PLANS** 


SHEET NUMBER

<del>-O-</del>

(OR) 3/8" = 1'-0" (11x17)

**A-2** 

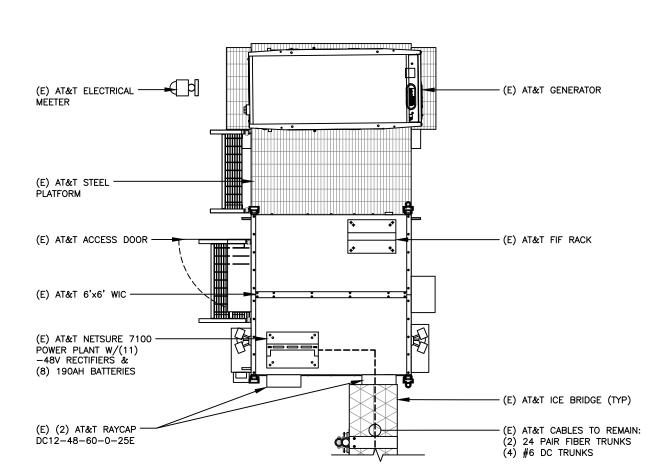

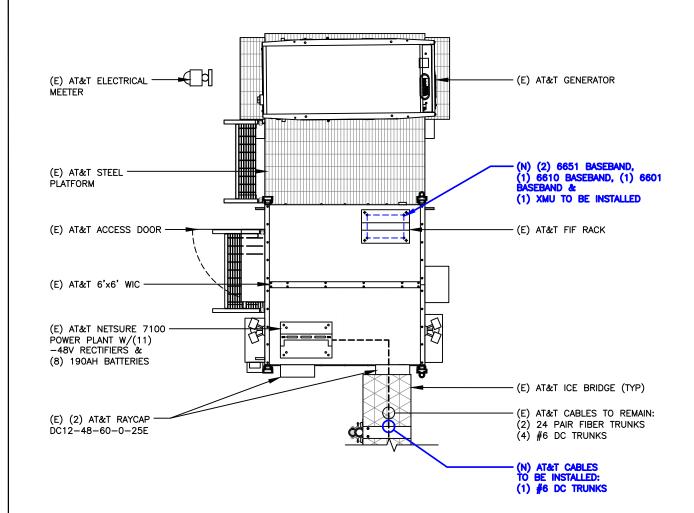


**NEW EQUIPMENT PLAN** 

SCALE: 3/4 = 1'-0" (24x36) (OR) 3/8" = 1'-0" (11x17)


<del>-O-</del>

SCALE: 3/4 = 1'-0" (24x36)

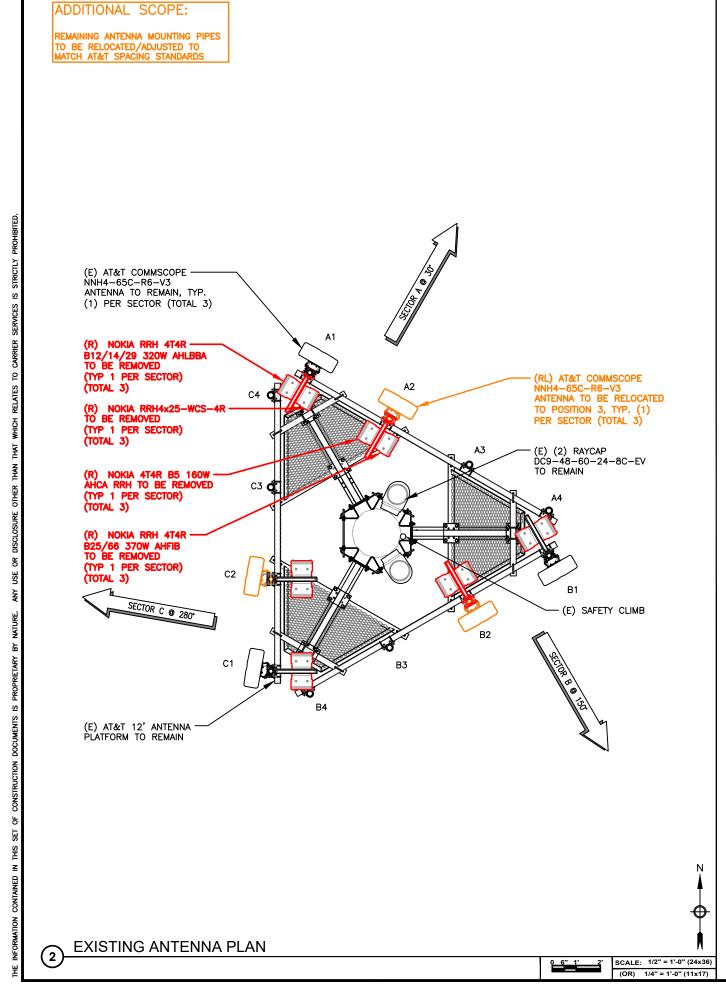

GENERAL CONTRACTOR SHALL ENSURE A MINIMUM OF 12" CLEARANCE FROM BACK OF MOUNT TO ANY NON-ANTENNA EQUIPMENT

**NEW ANTENNA PLAN** 

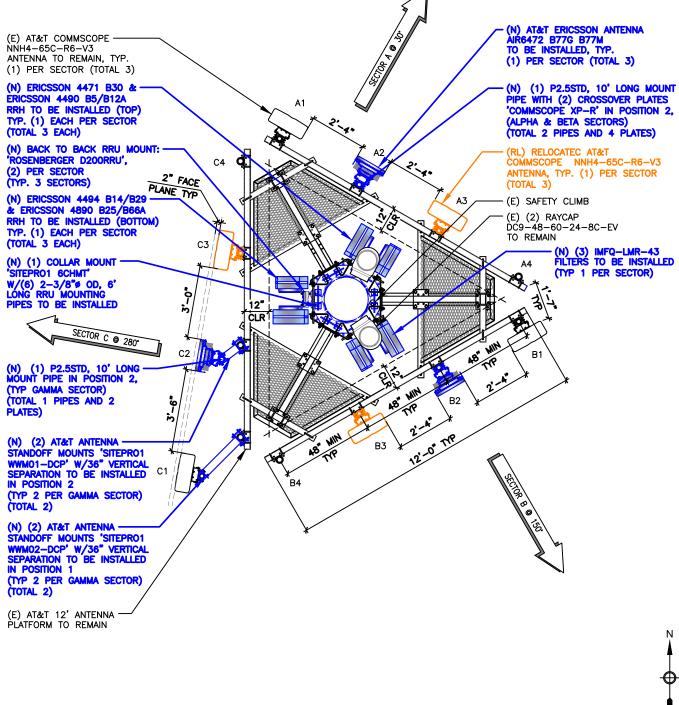







604 FOX GLEN BARRINGTON, IL 60010 PHONE: 847-277-0070 PM SEMAIL: AE@Westchesterservices.com

# JOHN M. BANKS **ARCHITECT**

604 FOX GLEN
BARRINGTON, IL 60010
TELEPHONE: 847-277-0070 EMAIL: JBANKS@WESTCHESTERSERVICES.COM

$\cap$	R	EVISIONS	
REV.	DATE	DESCRIPTION	BY
Α	01/13/25	ISSUED FOR REVIEW	SH
В	02/18/25	ISSUED FOR REVIEW	SH
		CONSTRUCTION UNLESS	

IS A VIOLATION OF LAW FOR ANY PERSONS, UNLESS THEY ARE ACTING UNDER THE DIRECTION OF A LICENSED PROFESSIONAL ARCHITECT TO ALTER THIS DOCUMENT

"I HEREBY CERTIFY THAT THESE PLANS WERE PREPARED BY ME OR UNDER MY DIRECT SUPERVISION AND THAT I AM A DULY REGISTERED ARCHITECT UNDER THE LAWS OF THE STATE OF MINNESOTA"

SITE NUMBER: MNL01123 SITE NAME: DELANO COUNTY LINE FA#: 11571089 3310 COUNTY LINE RD SE DELANO, MN 55328


SHEET TITLE

**EXISTING & NEW ANTENNA PLANS** 

SCALE: 1/2" = 1'-0" (24x36

(OR) 1/4" = 1'-0" (11x17)


**A-3** 

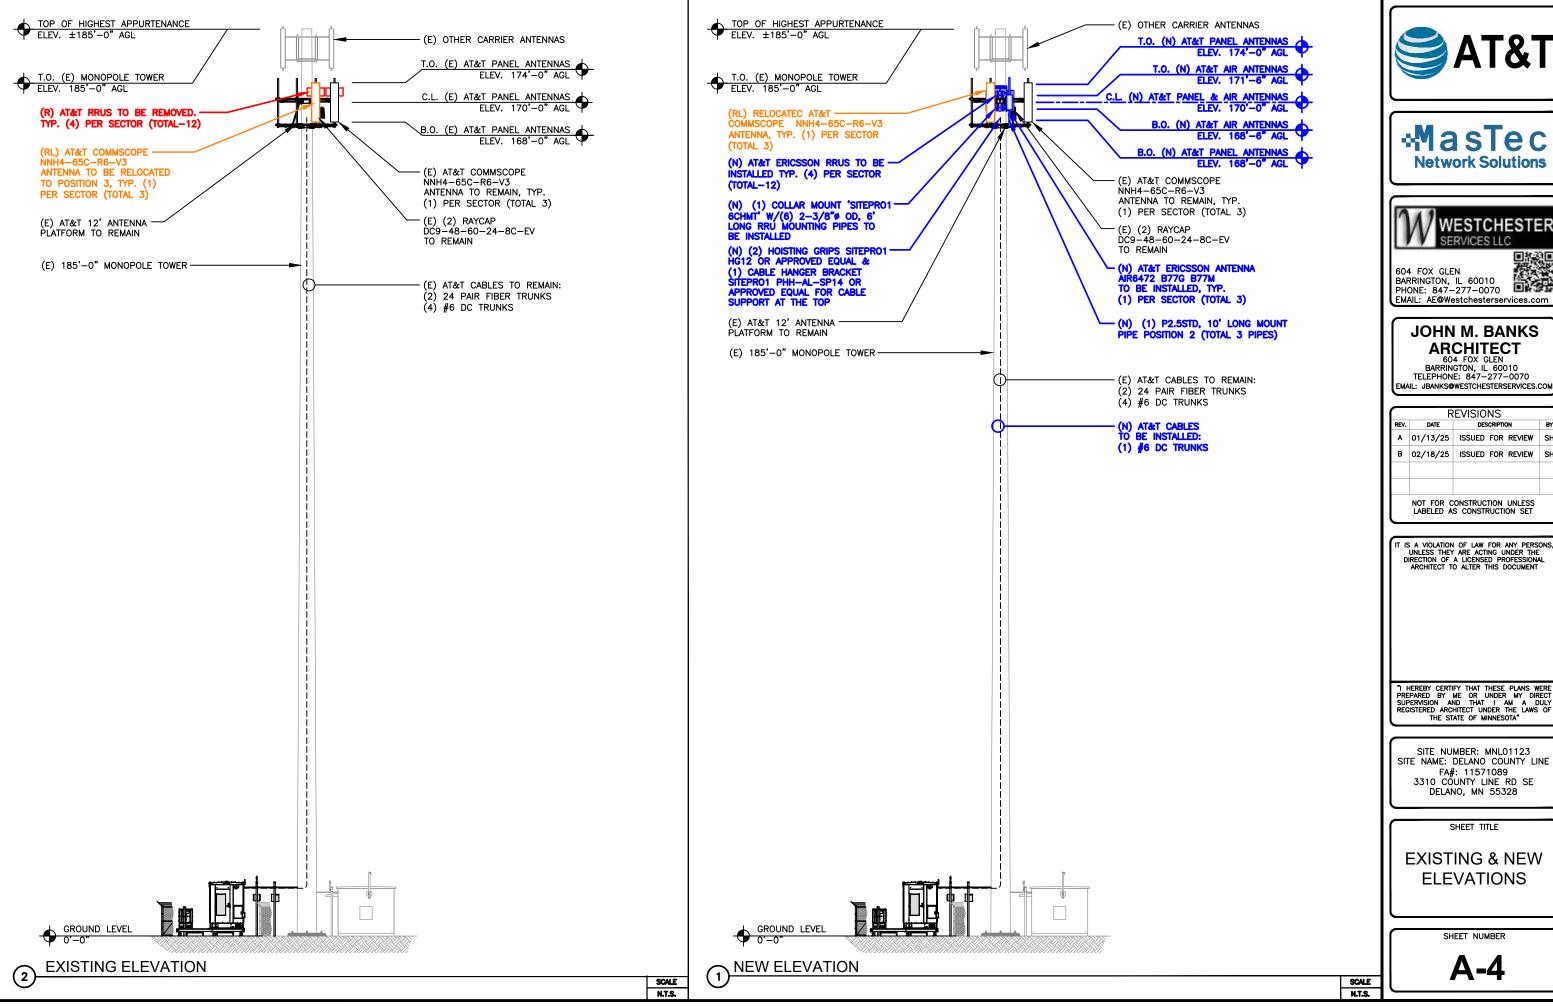







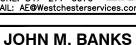

604 FOX GLEN
BARRINGTON, IL 60010
TELEPHONE: 847-277-0070 EMAIL: JBANKS@WESTCHESTERSERVICES.COM

	R	EVISIONS	
REV.	DATE	DESCRIPTION	E
A	01/13/25	ISSUED FOR REVIEW	s
В	02/18/25	ISSUED FOR REVIEW	s
	NOT FOR C	ONSTRUCTION UNLESS	

IS A VIOLATION OF LAW FOR ANY PERSONS UNLESS THEY ARE ACTING UNDER THE DIRECTION OF A LICENSED PROFESSIONAL ARCHITECT TO ALTER THIS DOCUMENT

"I HEREBY CERTIFY THAT THESE PLANS WERE PREPARED BY ME OR UNDER MY DIRECT SUPERVISION AND THAT I AM A DULY REGISTERED ARCHITECT UNDER THE LAWS OF THE STATE OF MINNESOTA"

SITE NUMBER: MNL01123 SITE NAME: DELANO COUNTY LINE FA#: 11571089 3310 COUNTY LINE RD SE DELANO, MN 55328

**EXISTING & NEW ELEVATIONS** 

				EXISTING ANT	ENNA	CONFIG	uration and cabl	E SCHE	IDULE										
SECTOR	POS.	BAND TECH.	ANTENNA MODEL	ANTENNA DIMENSIONS (HxWxD)	ANTENNA AZIMUTH	RAD CENTER	QTY./RRU MODEL	QTY./TMA MODEL	QTY./RAYCAP MODEL	CABLING	CABLE LENGTI								
	1	AWS/700 1900	(X) COMMSCOPE NNH4-65C-R6-V3	96"x19.6"x7.8"			(1) B12/14/29 370W AHLBA (R) (1) RRH4x25-WCS-4R (R)												
Α	2	850/WCS	(XR) COMMSCOPE NNH4-65C-R6-V3	96"x19.6"x7.8"	30°	170'-0"	(1) B5 160W AHCA (R) (1) 4T4R B25/66 320W AHFIB (R)	_											
,,	3	-	_	_		AGL	_												
	4	_	-	-				_	]										
	1	AWS/700 1900	(X) COMMSCOPE NNH4-65C-R6-V3	96"x19.6"x7.8"	150°	150°	150°								(1) B12/14/29 370W AHLBA (R) (1) RRH4x25-WCS-4R (R)				
В	2	850/WCS	(XR) COMMSCOPE NNH4-65C-R6-V3	96"x19.6"x7.8"				170'-0"	(1) B5 160W AHCA (R) (1) 4T4R B25/66 320W AHFIB (R)	_	(2) RAYCAP (X) DC9-48-60-24-8C-EV	(2) 24PR FIBER TRUNKS (X)	190'-0'						
	3	_	_	-									AGL	-		DC9-48-60-24-8C-EV	(4) #6 DC POWER TRUNK (X)	, 55 5	
	4	-	_	_			_												
	1	AWS/700 1900	(X) COMMSCOPE NNH4-65C-R6-V3	96"x19.6"x7.8"			(1) B12/14/29 370W AHLBA (R) (1) RRH4x25-WCS-4R (R)												
С	2	850/WCS	(XR) COMMSCOPE NNH4-65C-R6-V3	96"x19.6"x7.8"	280*	170'-0"	(1) B5 160W AHCA (R) (1) 4T4R B25/66 320W AHFIB (R)	_											
-	3	-	_	_		AGL	-												
	4	1	_	_	]		_												







604 FOX GLEN
BARRINGTON, IL 60010
PHONE: 847-277-0070
EMAIL: AE@Westchesterservices.com

# **JOHN M. BANKS**

ARCHITECT
604 FOX GLEN
BARRINGTON, IL 60010
TELEPHONE: 847-277-0070
EMAIL: JBANKSØWESTCHESTERSERVICES.COM

	REVISIONS									
REV.	DATE	DESCRIPTION	BY							
Α	01/13/25	ISSUED FOR REVIEW	SH							
В	02/18/25	ISSUED FOR REVIEW	SH							

NOT FOR CONSTRUCTION UNLESS LABELED AS CONSTRUCTION SET

IT IS A VIOLATION OF LAW FOR ANY PERSONS, UNLESS THEY ARE ACTING UNDER THE DIRECTION OF A LICENSED PROFESSIONAL ARCHITECT TO ALTER THIS DOCUMENT

"I HEREBY CERTIFY THAT THESE PLANS WERE PREPARED BY ME OR UNDER MY DIRECT SUPERVISION AND THAT I AM A DULY REGISTERED ARCHITECT UNDER THE LAWS OF THE STATE OF MINNESOTA"

SITE NUMBER: MNL01123
SITE NAME: DELANO COUNTY LINE
FA#: 11571089
3310 COUNTY LINE RD SE
DELANO, MN 55328

SHEET TITLE

ANTENNA SCHEDULE

SHEET NUMBER


RF-1

CABLE LENGTH IS APPROXIMATE AND MUST BE VERIFIED PRIOR TO CONSTRUCTION

(N) = NEW (X) = EXISTING (R) = REMOVE

(XR) = EXISTING/RELOCATED

				PROPOSED A	NTENN	IA CO	NFIGURATION AND C	CABLE SCH	HEDULE																	
SECTOR	POS.	BAND TECH.	ANTENNA MODEL	ANTENNA DIMENSIONS (HxWxD)	ANTENNA AZIMUTH		QTY./RRU MODEL	QTY./TMA/FIL TER MODEL	QTY./RAYCAP MODEL	CABLING	CABLE LENGTH															
	1	700/850	(X) COMMSCOPE NNH4-65C-R6-V3	96"x19.6"x7.8"			(1) ERICSSON 4471 B30 (N) (1) ERICSSON 4490 B5/B12A (N)	-																		
	2	5G CBAND	(N) ERICSSON AIR6472 B77G B77M	36.4"x16.1"x7.5"	30.	170'-0"	INTEGRATED RADIO																			
A	3	AWS/700/1900	(XR) COMMSCOPE NNH4-65C-R6-V3	96"x19.6"x7.8"	30	AGL	(1) ERICSSON 4494 B14/B29 (N) (1) ERICSSON 4890 B25/B66A (N)	(1) IMFQ-LMR-43																		
	4	_	-	_					1																	
	1	700/850	(X) COMMSCOPE NNH4-65C-R6-V3	96"x19.6"x7.8"	150°	150°	150°	150°	150°	150°	- 150°	· 150°	- 150°		(1) ERICSSON 4471 B30 (N) (1) ERICSSON 4490 B5/B12A (N)	-										
В	2	5G CBAND	(N) ERICSSON AIR6472 B77G B77M	36.4"x16.1"x7.5"										150°	150°	150°		150°	150°	150°	170'-0"	INTEGRATED RADIO		(2) RAYCAP (X) DC9-48-60-24-8C-EV	(2) 24PR FIBER TRUNKS (X) (4) #6 DC POWER TRUNK (X)	190'-0"
J	3	AWS/700/1900	(XR) COMMSCOPE NNH4-65C-R6-V3	96"x19.6"x7.8"																	130	AGL		AGL	AGL	AGL
	4	-	-	_			-																			
	1	700/850	(X) COMMSCOPE NNH4-65C-R6-V3	96"x19.6"x7.8"			(1) ERICSSON 4471 B30 (N) (1) ERICSSON 4490 B5/B12A (N)	_																		
•	2	5G CBAND	(N) ERICSSON AIR6472 B77G B77M	36.4"x16.1"x7.5"		170'-0"	INTEGRATED RADIO																			
С	3	AWS/700/1900	(XR) COMMSCOPE NNH4-65C-R6-V3	96"x19.6"x7.8"	280*	AGL	(1) ERICSSON 4494 B14/B29 (N) (1) ERICSSON 4890 B25/B66A (N)	(1) IMFQ-LMR-43																		
	4	_	-	-			-																			

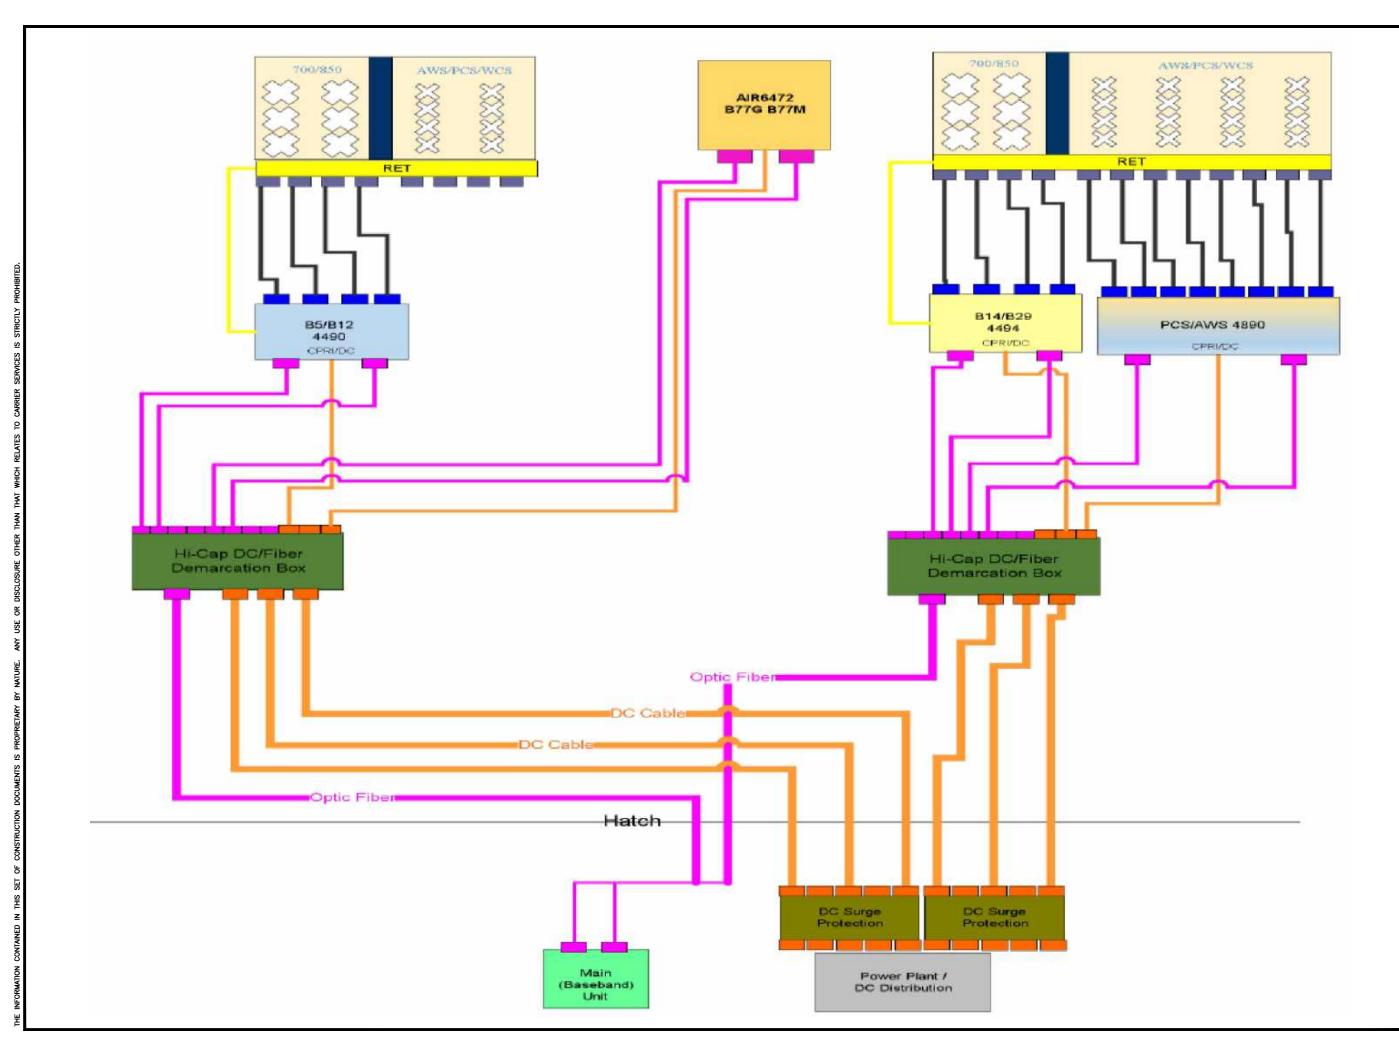







604 FOX GLEN
BARRINGTON, IL 60010
PHONE: 847-277-0070
EMAIL: AE@Westchesterservices.com

# **JOHN M. BANKS**

ARCHITECT
604 FOX GLEN
BARRINGTON, IL 60010
TELEPHONE: 847-277-0070
EMAIL: JBANKSØWESTCHESTERSERVICES.COM

	R	EVISIONS	
REV.	DATE	DESCRIPTION	BY
Α	01/13/25	ISSUED FOR REVIEW	SH
В	02/18/25	ISSUED FOR REVIEW	SH
		ONSTRUCTION UNLESS S CONSTRUCTION SET	

IT IS A VIOLATION OF LAW FOR ANY PERSONS, UNLESS THEY ARE ACTING UNDER THE DIRECTION OF A LICENSED PROFESSIONAL ARCHITECT TO ALTER THIS DOCUMENT


"I HEREBY CERTIFY THAT THESE PLANS WERE PREPARED BY ME OR UNDER MY DIRECT SUPERVISION AND THAT I AM A DULLY REGISTERED ARCHITECT UNDER THE LAWS OF THE STATE OF MINNESOTA"


SITE NUMBER: MNL01123 SITE NAME: DELANO COUNTY LINE FA#: 11571089 3310 COUNTY LINE RD SE DELANO, MN 55328


SHEET TITLE

**PLUMBING** DIAGRAM

RF-2

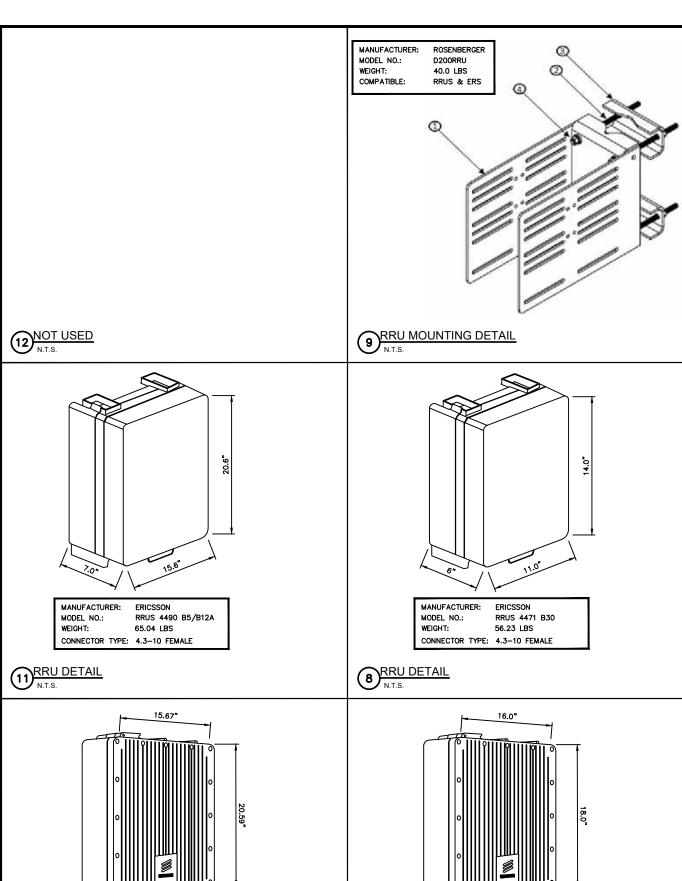

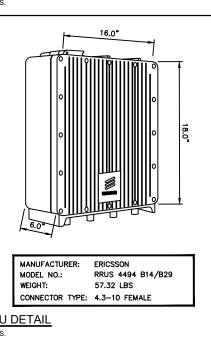

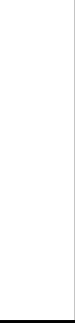

FREQUENCIES: 16.2" 

 $\frac{\text{NOTE:}}{\text{CONSTRUCTION TO REFER TO AT&T UPGRADE KIT GUIDELINES}}$  WHEN INSTALLING THE RBS 6601 IN THE RACK.

ERICSSON BASEBAND 6651:

OPERATING TEMPERATURE:

MOVABLE BRACKETS

ERICSSON BASEBAND 6601:

NOMINAL OPERATING VOLTAGE:

FAN MODULE -

OPERATING VOLTAGE RANGE:

OPERATING TEMPERATURE:

MOVABLE BRACKETS

ISOMETRIC VIEW

ANTENNA DETAIL

N.T.S.

DIMENSIONS, WxDxH:

TOTAL WEIGHT: BREAKER SIZE:

TOTAL WEIGHT: BREAKER SIZE:

DIMENSIONS, WxDxH:
NOMINAL OPERATING VOLTAGE:
OPERATING VOLTAGE RANGE:

FAN MODULE -

19"x13.8"x1.75"

0 TO +55°C

CONSTRUCTION TO REFER TO AT&T UPGRADE KIT GUIDELINES

WHEN INSTALLING THE RBS 6651 IN THE RACK.

-48 VDC -38 TO -58.5 VDC

6.5 kg | 14.3 LBS 30A

483mmX350mmX66mm

-48 VDC -40 TO -57.6 V DC

+5 TO +50°C

<10 kg 30A

BOTTOM VIEW

### ERICSSON BASEBAND 6610:

BASEBAND DETAIL

N.T.S.

DIMENSIONS, WxDxH:

HEAT DISSIPATION:

RADIO SHELF.

MANUFACTURER:

MODEL NO.:

WEIGHT:

WEIGHT:

DIMENSIONS, WxDxH:
NOMINAL OPERATING VOLTAGE:
OPERATING VOLTAGE RANGE: OPERATING TEMPERATURE: TOTAL WEIGHT:

5.51"x1.26"x1.57" -48 VDC -40 TO -58.5 VDC 0 TO +55°C <10 LBS

350x280x31 mm

50W (TYPICAL)

80W (MAX)





# JOHN M. BANKS ARCHITECT

604 FOX GLEN
BARRINGTON, IL 60010
TELEPHONE: 847-277-0070 EMAIL: JBANKS@WESTCHESTERSERVICES.COM

	R	EVISIONS	
REV.	DATE	DESCRIPTION	BY
Α	01/13/25	ISSUED FOR REVIEW	SH
В	02/18/25	ISSUED FOR REVIEW	SH


LABELED AS CONSTRUCTION SET

SITE NUMBER: MNL01123 SITE NAME: DELANO COUNTY LINE FA#: 11571089 3310 COUNTY LINE RD SE

SHEET TITLE

SHEET NUMBER

MANUFACTURER: ERICSSON MODEL NO.: AIR6472 B77G B77M WEIGHT: 92.6 LBS MULTI-BAND POLARIZATION: DUAL 3700-3980MHz

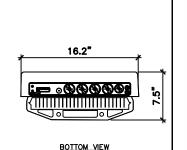

10.6 LBS

ERICSSON

SXK1092064/1



RRU DETAIL
N.T.S.

MANUFACTURER: MODEL NO .:

RRU DETAIL
N.T.S.

RRUS 4890 B25/B66A

67.24 LBS

CONNECTOR TYPE: 4.3-10 FEMALE

 $\frac{\text{NOTE:}}{\text{CONSTRUCTION TO REFER TO AT&T UPGRADE KIT GUIDELINES}}$  WHEN INSTALLING THE RBS 6610 IN THE RACK.

(WITH SOLAR SHIELD AND HANDLE) (13.8"x11"x1.22")

OPERATING TEMPERATURE RANGE: 5 TO 50°C (41 TO 122°F) • MOUNTING IN STANDARD DU SLOTS, DU ADAPTERS AND

MOUNTING IN 19" RACK OR IN TRANSMISSION COMPARTMENT BELOW AIR RESTRICTOR PLATE BY USE OF SUP 6601 V2.

UCXMU03 / KDU 137949/1

604 FOX GLEN
BARRINGTON, IL 60010
PHONE: 847-277-0070
EMAIL: AE@Westchesterservices.com

(	R	REVISIONS	
REV.	DATE	DESCRIPTION	BY
Α	01/13/25	ISSUED FOR REVIEW	SH
В	02/18/25	ISSUED FOR REVIEW	SH
	NOT FOR C	CONSTRUCTION UNLESS	


IS A VIOLATION OF LAW FOR ANY PERSONS UNLESS THEY ARE ACTING UNDER THE DIRECTION OF A LICENSED PROFESSIONAL ARCHITECT TO ALTER THIS DOCUMENT


"I HEREBY CERTIFY THAT THESE PLANS WERE PREPARED BY ME OR UNDER MY DIRECT SUPERVISION AND THAT I AM A DULY REGISTERED ARCHITECT UNDER THE LAWS OF THE STATE OF MINNESOTA"


DELANO, MN 55328

**DETAILS** 

ANTENNA MOUNTING DETAIL
N.T.S.

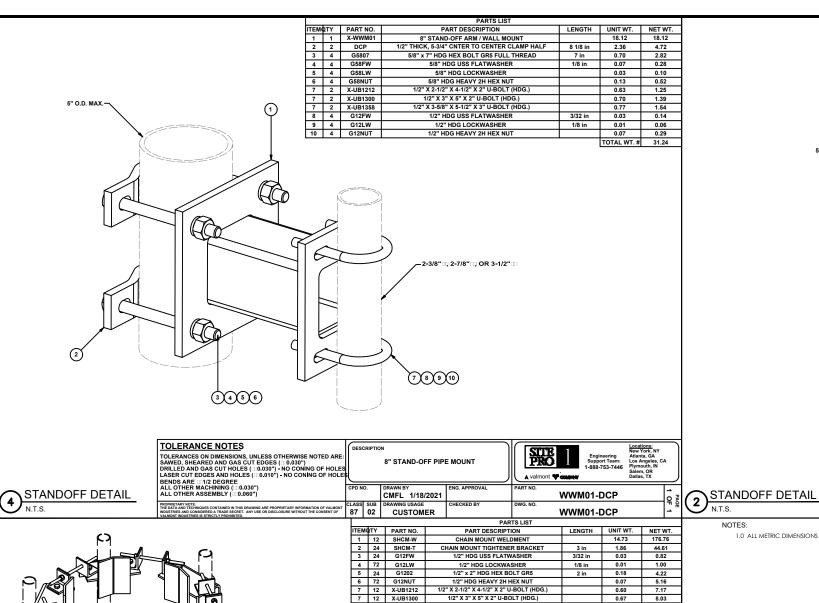

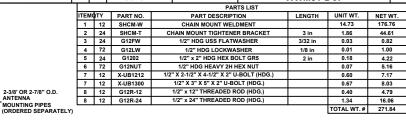

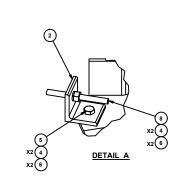

TOLERANCE NOTES  TOLERANCES ON DIMENSIONS, UNLESS OTHERWISE NOTED ARE: SAWED, SHEARED AND GAS CUT EDGES (£ 0.030") - NO CONING OF HOLES LASER CUT EDGES AND HOLES (£ 0.010") - NO CONING OF HOLES BENDS ARE 1/12 DEGREE	DESCRIPTION	N 6 SIDED MONOPOLE DR ROUND OR POLYO 17-1/2" TO 56" I	GON POLES	Engineering Support Team: 1-888-783-7446	Locations: New York, NY Atlanta, GA Los Angeles, CA Plymouth, IN Salem, OR Dallas, TX
ALL OTHER MACHINING (± 0.030") ALL OTHER ASSEMBLY (± 0.060")	CPD NO.	DRAWN BY CEK 4/14/2014	ENG. APPROVAL	PART NO. 6CHMT	10
PROPRETARY NOTE:  THE DATA AND TECHNIQUES CONTAINED IN THIS DRAWING ARE PROPRIETARY INFORMATION OF VALIMONT INDUSTRIES AND CONSIDERED A TRADE SECRET, ANY USE OR DISCLOSURE WITHOUT THE CONSENT OF VALIMONT INJUSTRIES IS STREATLY PROPRIETED.	81 01	CUSTOMER	CHECKED BY BMC 4/16/2014	DWG. NO.  6CHMT	- L

COLLAR MOUNT DETAIL


N.T.S.

1 1 X-WWM02 2 2 DCP 3 4 G5807 2' STAND-OFF ARM / WALL MOUN 30.70 30.70 8 1/8 in 2.36 4.72 7 in 0.70 2.82 1/8 in 0.07 0.28 1/2" THICK, 5-3/4" CNTER TO CENTER CLAMP HALF 5/8" x 7" HDG HEX BOLT GR5 FULL THREAD 5 4 G58LW 6 4 G58NUT 7 2 X-UB1212 5/8" HDG LOCKWASHER 5/8" HDG HEAVY 2H HEX NUT 1/2" X 2-1/2" X 4-1/2" X 2" U-BOLT (HDG.) 0.03 0.10 0.13 0.52 0.63 1.25 0.70 1.39 0.77 1.54 7 2 X-UB1300 1/2" X 3" X 5" X 2" U-BOLT (HDG.) 1/2" X 3-5/8" X 5-1/2" X 3" U-BOLT (HDG 7 2 X-UB1358 3/32 in 0.03 0.14

1/8 in 0.01 0.06

0.07 0.29

TOTAL WT. # 43.82 8 4 G12FW 9 4 G12LW 1/2" HDG USS FLATWASHER 1/2" HDG LOCKWASHER 1/2" HDG HEAVY 2H HEX NUT

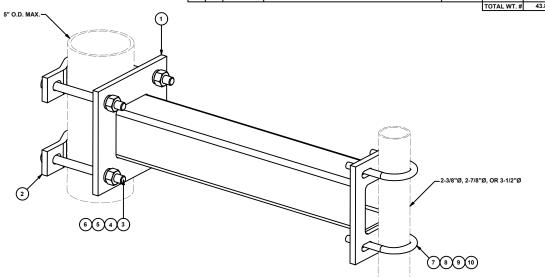


**TOLERANCE NOTES** TOLERANCES ON DIMENSIONS, UNLESS OTHERWISE NOTED ARE SAWED, SHEARED AND GAS CUT EDGES (± 0.030")
DRILLED AND GAS CUT HOLES (± 0.030") - NO CONING OF HOLES LASER CUT EDGES AND HOLES (± 0.010") - NO CONING OF HOLES BENDS ARE ± 1/2 DEGREE
ALL OTHER MACHINING (± 0.030")
ALL OTHER ASSEMBLY (± 0.060")

24" STAND-OFF PIPE MOUNT CMFI 10/27/2021

WWM02-DCP WWM02-DCP


87 02 CUSTOMER

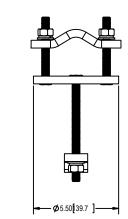

1.0 ALL METRIC DIMENSIONS ARE IN BRACKETS



CROSSOVER PLATE DETAIL

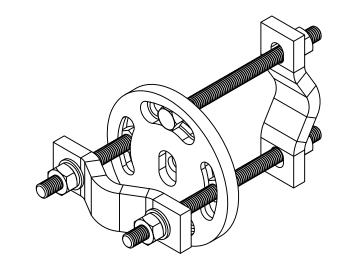

COMMSCOPE, INC. OF NORTH CAROLINA XP-R ASTM A123 A36

CROSSOVER PLATE, ROUND, UP TO 3.5" OF XP-R

«MasTec **Network Solutions** 



604 FOX GLEN BARRINGTON, IL 60010 PHONE: 847-277-0070 PHONE: 847-277-0070 PM STANDARD PHONE: 847-277-0070

# JOHN M. BANKS **ARCHITECT**

604 FOX GLEN
BARRINGTON, IL 60010
TELEPHONE: 847-277-0070 EMAIL: JBANKS@WESTCHESTERSERVICES.COM

$\cap$	R	EVISIONS			
REV.	DATE	DESCRIPTION	BY		
Α	01/13/25	ISSUED FOR REVIEW	SH		
В	02/18/25	ISSUED FOR REVIEW	SH		
	NOT FOR CONSTRUCTION UNITES				

LABELED AS CONSTRUCTION UNLESS

IS A VIOLATION OF LAW FOR ANY PERSONS UNLESS THEY ARE ACTING UNDER THE DIRECTION OF A LICENSED PROFESSIONAL ARCHITECT TO ALTER THIS DOCUMENT

"I HEREBY CERTIFY THAT THESE PLANS WERE PREPARED BY ME OR UNDER MY DIRECT SUPERVISION AND THAT I AM A DULY REGISTERED ARCHITECT UNDER THE LAWS OF THE STATE OF MINNESOTA"

SITE NUMBER: MNL01123 SITE NAME: DELANO COUNTY LINE FA#: 11571089 3310 COUNTY LINE RD SE DELANO, MN 55328

SHEET TITLE

**DETAILS** 

C2015 CommScope, Inc. Confidenti

Tri-Mode: TDD AAS + FDD NR/LTE: RANP6651 + 6601 SUP + R503 + CNTR6610 + SAU

 Additional basebands might be added in case of 4 or more sector site or number of cells exceeding the baseband limits. E.g. 2x6651 (Swap/Acceleration) or 6651 + 6630 (Acceleration)



Radio 4498/4449 — 85 (858) and B12 (786) OR Radio 4478 B12 (786) OR Radio 4478 B5 (856).

Radio 4494 – B14 (FNET) and B29 (7880E) Radio 4478 – B14 (FNET)

AIR 6472 - 877D (C-Band) and 877G (3.45) (2 x eCPRI -> 8W = 120MHz) OR AIR 6449/AIR 6449 B77D (C-Band - A1/B1/C1) + AIR 6449 B77G (3.45 - A2/B2/C2)


Radio 4898/8845 - B25 (PCS) and B66 (AWS)

Radio 4471 – B30 (WCS) OR Radio 4415 – B30 (WCS)

M NOT CONNECTED

BASEBAND CONFIGURATION
N.T.S.

**CABLE HANGER** BRACKET DETAIL

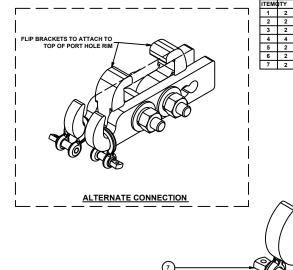

PART DESCRIPTION
1" MILL PLATE (A572 GR50 LENGTH UNIT WT. NET WT. LENGTH UNIT WT. NET WT.

12 in 1.14 2.29

12 in 1.34 2.68

3 in 0.22 0.43

3/32 in 0.03 0.14

1/8 in 0.01 0.03

0.07 0.14

0.10 0.21

TOTAL WT 5 592 1/2" MILL PLATE (A572 GR.50 1/2" HDG USS FLATWASHER 1/2" HDG LOCKWASHER 1/2" HDG HEAVY 2H HEX NUT

FINISH: HOT DIP GALVANIZED.

87 02 CUSTOMER

PORT HOLE HANGER KIT W/ 1/4" SHACKLES

PHH-AL-SP14

PHH-AL-SP14

SUPPORT GRIP INSTALLATION INSTRUCTIONS PRIOR TO INSTALLATION Clevis, Required to the base of the hoisting grip before applying tension to the Ine

Page the Holsting/Support pripts) at the proper location on the catile as shown in Figure 1. Allow a sufficient length of cable leader to reach the junction point input when cable holsting and attachment of the grip handle to the support structor is completed.

**Hoisting Considerations** 

5.3 M

Steel cable or rope host line

Te back ropes

HOISTING GRIP DETAIL
N.T.S.

REFER TO HOISTING AND

NOT USED N.T.S.

ITEMOTY PART NO.
1 2 X-HHR-HANGH 2 2 X-HHR-HANGL 3 2 G1203 4 4 G12FW 5 2 G12LW 6 2 G12NUT 7 2 SHK14

**TOLERANCE NOTES** 

TOLERANCE AND IMENSIONS, UNLESS OTHERWISE NOTED ARE: SAWED, SHEARED AND GAS CUT EDDES (± 0.030") DRILLED AND GAS CUT HOLES (± 0.030") - NO CONING OF HOLES (± 0.050") - NO CONING OF HOLES (± 0.010") - NO CONING OF HOLES (± 0.010") - NO CONING OF HOLES (± 0.010") - NO CONING OF HOLES BENDS AND ANGLES ARE: ±12 DEGREE ALL OTHER MACHINING (± 0.030") ALL OTHER ASSEMBLY (± 0.050")

CMFL 5/10/2023

**MasTec Network Solutions** 

WESTCHESTER

604 FOX GLEN BARRINGTON, IL 60010
PHONE: 847-277-0070
EMAIL: AE@Westchesterservices.com

JOHN M. BANKS

**ARCHITECT** 604 FOX GLEN
BARRINGTON, IL 60010
TELEPHONE: 847-277-0070 EMAIL: JBANKS@WESTCHESTERSERVICES.COM

$\subset$	R	EVISIONS	_
REV.	DATE	DESCRIPTION	BY
Α	01/13/25	ISSUED FOR REVIEW	SH
В	02/18/25	ISSUED FOR REVIEW	SH

NOT FOR CONSTRUCTION UNLESS LABELED AS CONSTRUCTION SET

IS A VIOLATION OF LAW FOR ANY PERSONS UNLESS THEY ARE ACTING UNDER THE DIRECTION OF A LICENSED PROFESSIONAL ARCHITECT TO ALTER THIS DOCUMENT

"I HEREBY CERTIFY THAT THESE PLANS WERE PREPARED BY ME OR UNDER MY DIRECT SUPERVISION AND THAT I AM A DULY REGISTERED ARCHITECT UNDER THE LAWS OF THE STATE OF MINNESOTA"

SITE NUMBER: MNL01123 SITE NAME: DELANO COUNTY LINE FA#: 11571089 3310 COUNTY LINE RD SE DELANO, MN 55328

SHEET TITLE

**DETAILS** 

(E) (2) AT&T RAYCAP -DC12-48-60-0-25E

- (N) (2) 6651 BASEBAND, (1) 6610 BASEBAND, (1) 6601 BASEBAND & (1) XMU TO BE INSTALLED

- (E) AT&T FIF RACK



(E) AT&T NETSURE 7100 — POWER PLANT W/(11) -48V RECTIFIERS & (8) 190AH BATTERIES





\*MasTec
Network Solutions

WESTCHESTER

604 FOX GLEN
BARRINGTON, IL 60010
PHONE: 847-277-0070
EMAIL: AE@Westchesterservices.com

# **JOHN M. BANKS**

ARCHITECT
604 FOX GLEN
BARRINGTON, IL 60010
TELEPHONE: 847-277-0070
EMAIL: JBANKSØWESTCHESTERSERVICES.COM

$\overline{}$	R	REVISIONS	_
REV.	DATE	DESCRIPTION	BY
Α	01/13/25	ISSUED FOR REVIEW	SH
В	02/18/25	ISSUED FOR REVIEW	SH
		CONSTRUCTION UNLESS S CONSTRUCTION SET	

I IS A VIOLATION OF LAW FOR ANY PERSONS, UNLESS THEY ARE ACTING UNDER THE DIRECTION OF A LICENSED PROFESSIONAL ARCHITECT TO ALTER THIS DOCUMENT

"I HEREBY CERTIFY THAT THESE PLANS WERE PREPARED BY ME OR UNDER MY DIRECT SUPERVISION AND THAT I AM A DULY REGISTERED ARCHITECT UNDER THE LAWS OF THE STATE OF MINNESOTA"

SITE NUMBER: MNL01123 SITE NAME: DELANO COUNTY LINE FA#: 11571089 3310 COUNTY LINE RD SE DELANO, MN 55328

SHEET TITLE

**DETAILS** 

SHEET NUMBER

EQUIPMENT DETAILS

N.T.S.

### GROUNDING NOTES:

- 1. ALL DETAILS ARE SHOWN IN GENERAL TERMS, ACTUAL GROUNDING INSTALLATION REQUIREMENTS AND CONSTRUCTION ACCORDING TO SITE
- 2. ALL GROUNDING CONDUCTORS: #2 AWG SOLID BARE TINNED COPPER WIRE
- GROUND BAR LOCATED IN BASE OF EQUIPMENT WILL BE PROVIDED, FURNISHED AND INSTALLED BY THE VENDOR.
- ALL BELOW GRADE CONNECTIONS: EXOTHERMIC WELD TYPE. ABOVE GRADE CONNECTIONS: EXOTHERMIC WELD TYPE
- 5. GROUND RING SHALL BE LOCATED A MINIMUM OF 24" BELOW GRADE OR 6"
- INSTALL GROUND CONDUCTORS AND GROUND OR MINIMUM OF 1'-0" FROM EQUIPMENT CONCRETE SLAB, SPREAD FOOTING, OR FENCE.
- EXOTHERMIC WELD GROUND CONNECTION TO FENCE POST: TREAT WITH A COLD GALVANIZED SPRAY.
- A) EQUIPMENT GROUND BUS BAR (EGB) LOCATED AT THE BOTTOM OF ANTENNA POLE/MAST FOR MAKING GROUNDING JUMPER CONNECTIONS TO COAX FEEDER CABLES SHALL BE FURNISHED AND INSTALLED BY ELECTRICA CONTRACTOR. JUMPERS (FURNISHED BY OWNERS) SHALL BE INSTALLED AND CONNECTED BY ELECTRICAL CONTRACTOR.
- ALL GROUNDING INSTALLATIONS AND CONNECTIONS SHALL BE MADE BY ELECTRICAL CONTRACTOR
- 10. OBSERVE N.E.C. AND LOCAL UTILITY REQUIREMENTS FOR ELECTRICAL SERVICE GROUNDING.
- 11 GROUNDING ATTACHMENT TO TOWER SHALL BE AS PER MANUFACTURER'S RECOMMENDATIONS OR AT GROUNDING POINTS PROVIDED (2 MINIMUM).
- IF EQUIPMENT IS IN A C.L. FENCE ENCLOSURE, GROUND ONLY CORNER POSTS AND SUPPORT POSTS OF GATE. IF CHAIN LINK FENCE LID IS USED, THEN GROUND LID ALSO.
- 13. GROUNDING AT PPC CABINET SHALL BE VERTICALLY INSTALLED.
- 14. ALL GROUNDING FOR ANTENNAS SHALL BE CONNECTED SO THAT E WILL
- 15. ALL EMT RUNS SHALL BE GROUNDED AND HAVE A BUSHING, NO PVC ABOVE
- 16. USE SEPARATE HOLES FOR GROUNDING AT BUSS BAR. NO "DOUBLE-UP" OF
- 17. POWER AND TELCO CABINETS SHALL BE GROUNDING (BONDED) TOGETHER.
- 18. NO LB'S ALLOWED ON GROUNDING.

GROUNDING NOTES

N.T.S.

- 19. PROVIDE STAINLESS STEEL CLAMP AND BRASS TAGS ON COAX AT ANTENNAS
- 20. ALL ELECTRICAL AND GROUNDING AT THE CELL SITE SHALL COMPLY WITH THE NATIONAL ELECTRICAL CODE (NEC). NATIONAL FIRE PROTECTION ASSOCIATION (NFPA), 780 (LATEST EDITION), AND MANUFACTURER SPECIFICATION.
- 21. IF THE AC PANEL IN THE POWER CABINET IS WIRED AS SERVICE ENTRANCE, THE AC SERVICE GROUND CONDUCTOR SHALL BE CONNECTED TO GROUND ELECTRODE SYSTEM. WHEN THE AC PANEL IN THE POWER CABINET IS CONSIDERED A SUB-PANEL, THE GROUND WIRE SHALL BE INSTALLED IN THE AC POWER CONDUIT, THE INSTALLATION SHALL BE PER LOCAL AND NATIONAL
- 22. EXOTHERMIC WELDING IS RECOMMENDED FOR GROUNDING CONNECTION WHERE PRACTICAL OTHERWISE, THE CONNECTIONS SHALL BE MADE USING COMPRESSION TYPE-2 HOLES. LONG BARREL LUGS OR DOUBLE CRIMP CLAMF "C" CLAMP. THE COPPER CABLES SHALL BE COATED WITH ANTIOXIDANT (COPPER SHIELD) BEFORE MAKING THE CONNECTIONS. THE MANUFACTURER'S TORQUING RECOMMENDATIONS ON THE BOLT ASSEMBLY TO SECURE CONNECTIONS SHALL BE FOLLOWED.
- 23. THE ANTENNA CABLES SHALL BE GROUNDED AT THE TOP AND BOTTOM OF THE VERTICAL RUN FOR LIGHTING PROTECTION. THE ANTENNA CABLE SHIELD SHALL BE BONDED TO A COPPER GROUND BUSS AT THE LOWER MOST POINT OF A VERTICAL RUN JUST BEFORE IT BEGINS TO BEND TOWARD THE HORIZONTAL PLANE, WIRE RUNS TO GROUND SHALL BE KEPT AS STRAIGHT AND SHORT AS POSSIBLE. ANTENNA CABLE SHIELD SHALL BE GROUNDED JUST BEFORE ENTERING THE CELL CABINET, ANY ANTENNA CABLES OVER 200 FEET IN LENGTH SHALL ALSO BE EQUIPPED WITH ADDITIONAL GROUNDING AT
- 24. ALL GROUNDING CONDUCTORS INSIDE THE BUILDING SHALL BE RUN IN CONDUIT RACEWAY SYSTEM, AND SHALL BE INSTALLED AS STRAIGHT AS PRACTICAL WITH MINOR BENDS TO AVOID OBSTRUCTIONS.THE BENDING RADIUS OF ANY #2 GROUNDING CONDUCTOR IS 8" PVC RACEWAY MAY BE FLEXIBLE OR RIGID PER THE FIELD CONDITIONS. GROUNDING CONDUCTORS SHALL NOT MAKE CONTACT WITH ANY METALLIC CONDUITS, SURFACES OR
- 25. PROVIDE PVC SLEEVES WHERE GROUNDING CONDUCTORS PASS THROUGH THE BUILDING WALLS AND/OR CEILINGS.
- 26. INSTALL GROUND BUSHINGS ON ALL METALLIC CONDUITS AND BOND TO THE EQUIPMENT GROUND BUSS IN THE PANEL BOARD.
- 27 GROUND ANTENNA BASES FRAMES CABLE RACKS AND OTHER METALLIC. COMPONENTS WITH #2 GROUNDING CONDUCTORS AND CONNECT TO INSULATED SURFACE MOUNTED GROUND BARS, CONNECTION DETAILS SHALL FOLLOW MANUFACTURER'S SPECIFICATIONS FOR GROUNDING
- 28. ALL PROPOSED GROUNDING CONDUCTORS SHALL BE ROUTED AND CONNECTED TO THE MAIN GROUND BAR OR EXISTING GROUND RING

### **GROUNDING LEGEND**


MECHANICAL CONNECTION **EXOTHERMIC WELD CONNECTION** COMPRESSION FITTING CONNECTION

PROPOSED GROUND WIRING EXISTING GROUND WIRING TINNED COPPER GROUND BAR

1/4"X4"X12" OR 1/4"X4"X20"

CGB COLLECTOR GROUND BAR

MAIN GROUND BAR

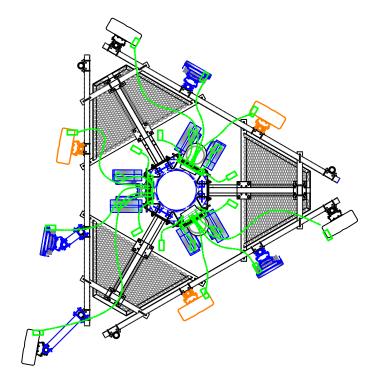

**\*MasTec Network Solutions** 



604 FOX GLEN BARRINGTON, IL 60010 PHONE: 847-277-0070 EMAIL: AE@Westchesterservices.com

# JOHN M. BANKS

ARCHITECT 604 FOX GLEN BARRINGTON, IL 60010 TELEPHONE: 847-277-0070 EMAIL: JBANKS@WESTCHESTERSERVICES.COM

$\subset$	REVISIONS				
REV.	DATE	DESCRIPTION	BY		
Α	01/13/25	ISSUED FOR REVIEW	SH		
В	02/18/25	ISSUED FOR REVIEW	SH		

NOT FOR CONSTRUCTION UNLESS LABELED AS CONSTRUCTION SET

IS A VIOLATION OF LAW FOR ANY PERSONS UNLESS THEY ARE ACTING UNDER THE DIRECTION OF A LICENSED PROFESSIONAL ARCHITECT TO ALTER THIS DOCUMENT

"I HEREBY CERTIFY THAT THESE PLANS WERE PREPARED BY ME OR UNDER MY DIRECT SUPERVISION AND THAT I AM A DULY REGISTERED ARCHITECT UNDER THE LAWS OF THE STATE OF MINNESOTA"

SITE NUMBER: MNL01123 SITE NAME: DELANO COUNTY LINE FA#: 11571089 3310 COUNTY LINE RD SE DELANO, MN 55328

SHEET TITLE

**GROUNDING PLANS & NOTES** 

SHEET NUMBER

# ANTENNA GROUNDING PLAN (TYP. PER SECTOR)

# **GROUNDING LEGEND**

MECHANICAL CONNECTION **EXOTHERMIC WELD CONNECTION** COMPRESSION FITTING CONNECTION PROPOSED GROUND WIRING EXISTING GROUND WIRING

TINNED COPPER GROUND BAR 1/4"X4"X12" OR 1/4"X4"X20"

COLLECTOR GROUND BAR MAIN GROUND BAR




SILICON

SEAL AT TOP CGB

MGB

EQUIPMENT GROUNDING PLAN
N.T.S.

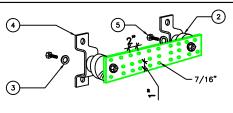

### LEGEND

- 1. COPPER GROUND BAR, "X1/4"X20". NEWTON INSTRUMENT CO. CAT. NO. B-6142 OR EQUAL. HOLE CENTERS TO MATCH NEMA DOUBLE LUG CONFIGURATION. (ACTUAL GROUND BAR SIZE WILL VARY BASED ON NUMBER OF GROUND CONNECTORS)
- 2. INSULATORS, NEWTON INSTRUMENT CAT. NO. 3061-4 OR EQUAL
- 3. 5/8" LOCKWASHERS, NEWTON INSTRUMENT CO. CAT. NO, 3015-8 OR 4. WALL MOUNTING BRACKET, NEWTON

INSTRUMENT CO. CAT. NO. A-6056 OR

- **EQUAL** 5. 5/8"-11X1" HHCS BOLTS, NEWTON INSTRUMENT CO. CAT. NO. 3012-1 OR
- 6. INSULATORS SHALL BE ELIMINATED WHEN BONDING DIRECTLY TO TOWER/XXX STRUCTURE. CONNECTION TO TOWER/XXX STRUCTURE SHALL BE PER MANUFACTURERS RECOMMENDATIONS.

NOTE: ALL HARDWARE SHALL BE STAINLESS STEEL

**GROUND BAR DETAIL** 

- DUAL CALDWELDS, ~ TO BE USED W/#2 AWG BCW TÓ GROUND RING

#2 AWG FROM EQUIPMENT TO

BE GROUNDED

GROUND

CONTRACTOR TO UTILIZE KOPR-SHIELD (THANS & BETTS)
 ON ALL LUG CONNECTIONS OR APPROVED EQUAL.
 ALL LUGS TO BE DUAL HOLE LONG BARREL AND

SEALTITE

CRIMPED TWICE WITH MFR'S RECOMMENDED TOOL

GROUND BAR CONNECTION
N.T.S.



Date: April 9, 2025

ARCHITECTURE & ENGINEERING DIVISION

604 FOX GLEN . BARRINGTON, IL 60010 847/277-0070 . FAX: 847/277-0080

AE@westchesterservices.com / www.westchesterservices.com

MasTec Communications Group 800 S. Douglas Rd., 10<sup>th</sup> Floor Coral Gables, FL 33134

Subject: Structural Analysis Report

AT&T Turf 6

Site Name:

Delano County Line

FA#:

11571089

IWM:

WSUMW0046561

**Engineering Firm Designation:** 

Westchester Services, LLC

Site Data:

3310 County Line Rd., SE, Delano, MN 55328

N45.037277, W93.765194

Wright County - 185ft Monopole

12ft Face Platform Mount - 167ft Mounting Height

Westchester Services, LLC is pleased to submit this "Structural Analysis Report" to determine the structural integrity of the above-mentioned tower. The purpose of the analysis is to determine acceptability of the tower stress level. Based on our analysis we have determined the tower stress levels for the tower under the following load case to be:

# **Existing and Proposed Equipment**

**Sufficient Capacity** 

Note: See Table 2-1 for the existing and proposed loading.

Member Type	Result	Pass/Fail
Overall	83.6%	Pass

The analysis has been performed in accordance with the following criteria:

Building Code:

2020 Minnesota Building Code

TIA Standard:

TIA-222-H

I certify that this report was prepared by me or under my

direct supervision and that I am a ligensed Professional this plan, specification, Engineer under the laws of the State of

Licensed Professional Engineer under the laws

Thomas Holt, PE

Professional Engineer

lame: Thomas Alexander Holf Jr

Date: 4/9/15 Ucense Number: 58133

# City of Independence

# Request for a Minor Subdivision for the Property located at 6785 Hwy 12

To: | Planning Commission

From: | Mark Kaltsas, City Planner

Meeting Date: | September 16, 2025

Owner/Applicants: | Greg A Jurvakainen/ Carter Berkelman

Location: 6785 Highway 12

# Request:

Greg A Jurvakainen (Applicants) and Carter Berkelman (Owner) request that the City consider the following action for the properties located at 6785 Highway 12, Independence, MN (PID No. 22-118-24-42-0001) and the property to the south that does not have an address but is identified by the following PID Number (PID No. 22-118-24-31-0002):

a. A minor subdivision to allow a lot line rearrangement between the two subject properties. The minor subdivision would add approximately 50' to the south side of the 6785 Highway 12 property.

## **Property/Site Information:**

The subject property is located along the south side of Highway 12, west of County Road 90 N. The existing property has an existing home. The unaddressed property has an existing accessory building which is accessed off of Pioneer Creek Drive. The subject properties have the following site characteristics:

Property Information: 6785 Highway 12 (Berkelman)


**Zoning**: *AG-Agriculture* 

Comprehensive Plan: Agriculture Acreage (Before): 5.61 acres Acreage (After): 7.40 acres

**Property Information: Unaddressed Property (Blatz)** 

**Zoning:** AG-Agriculture

Comprehensive Plan: Agriculture Acreage (Before): 125.10 acres Acreage (After): 123.31 acres

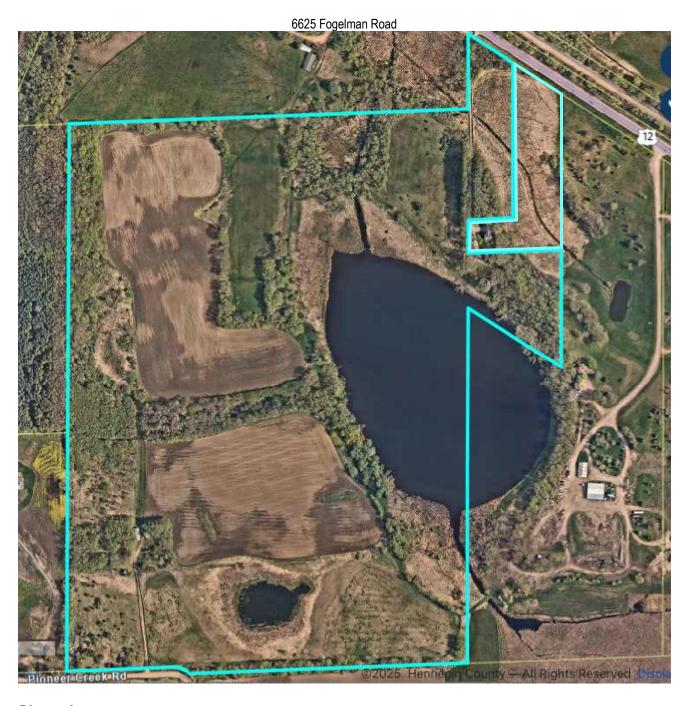

## Discussion:

The applicant approached the city about the possibility of doing a lot line rearrangement so that the existing house could be expanded without the need for a setback variance. The proposed minor subdivision would also allow the existing septic system to be brought onto the property with the existing house. It is currently located within an easement on the adjacent property. The proposed lot line rearrangement would add 1.79 acres to the existing property.

The owner of the 6785 Hwy 12 property is related to the owner of the adjacent property. There are several things that should be noted as it relates to the proposed lot line rearrangement:

- The existing lot is considered a legal non-confirming lot because it does not have the requisite frontage on a public right of way. The property currently has 270 LF of frontage on Hwy 12. The requisite frontage is 300 LF.
- The driveway that services the existing house and lot is located within a driveway easement on the adjacent property.
- The septic field that serves the existing house is located within a drain field easement on the adjacent property. In the proposed after condition, the septic field will be located wholly on the subject property.
- There do not appear to be any issues with the larger unaddressed property in the after condition.
- The applicant provided the city with copies of the proposed home addition.

The applicant is seeking a minor subdivision to allow lot line rearrangement to adjust/move the property line separating the two parcels for the purpose of constructing an addition onto the existing home that meets all applicable setbacks. With the proposed change, both lots will maintain their original character and the general character of the surrounding properties. Planning Commissioners will need to consider whether or not the requested lot line rearrangement will meet all applicable criteria of the city's zoning ordinance.

## **Neighbor Comments:**

The city had not received any written or verbal comments prior to the time this report was written.

### Recommendation:

Staff is seeking a recommendation from the Planning Commission for the requested minor subdivision with the following findings:

- 1. The proposed minor subdivision meets all applicable criteria and conditions stated in Chapter V, Section 500, Planning and Land Use Regulations of the City of Independence Zoning Ordinance.
- 2. The Applicant shall pay for all costs associated with the City's review of the requested subdivision.
- 3. The Applicant shall record the subdivision and City Council Resolution with the county within six (6) months of approval.

### Attachments:

- 1. Application
- 2. Proposed Subdivision Exhibits



Date Submitted: 08-06-2025

**Applicant Information Owner Information** 

Name: Greg A Jurvakainen Name: Carter Berkleman

Address: 5500 Lincoln Drive, Address: 6785 US Hwy No 12

Suite #180

Edina, Minnesota 55436 55359

Independence, Minnesota

Primary Phone: 612-968-5886 Primary Phone: 612-220-9759

Email: greg@lcramer.com Email: carter.berkelman@gmail.com

Property Address:


PID:


Planning Application Type: Other


Description:

Supporting Documents: Site Survey (Existing Conditions), Site Survey (Proposed Conditions), Building Plans

Signature:

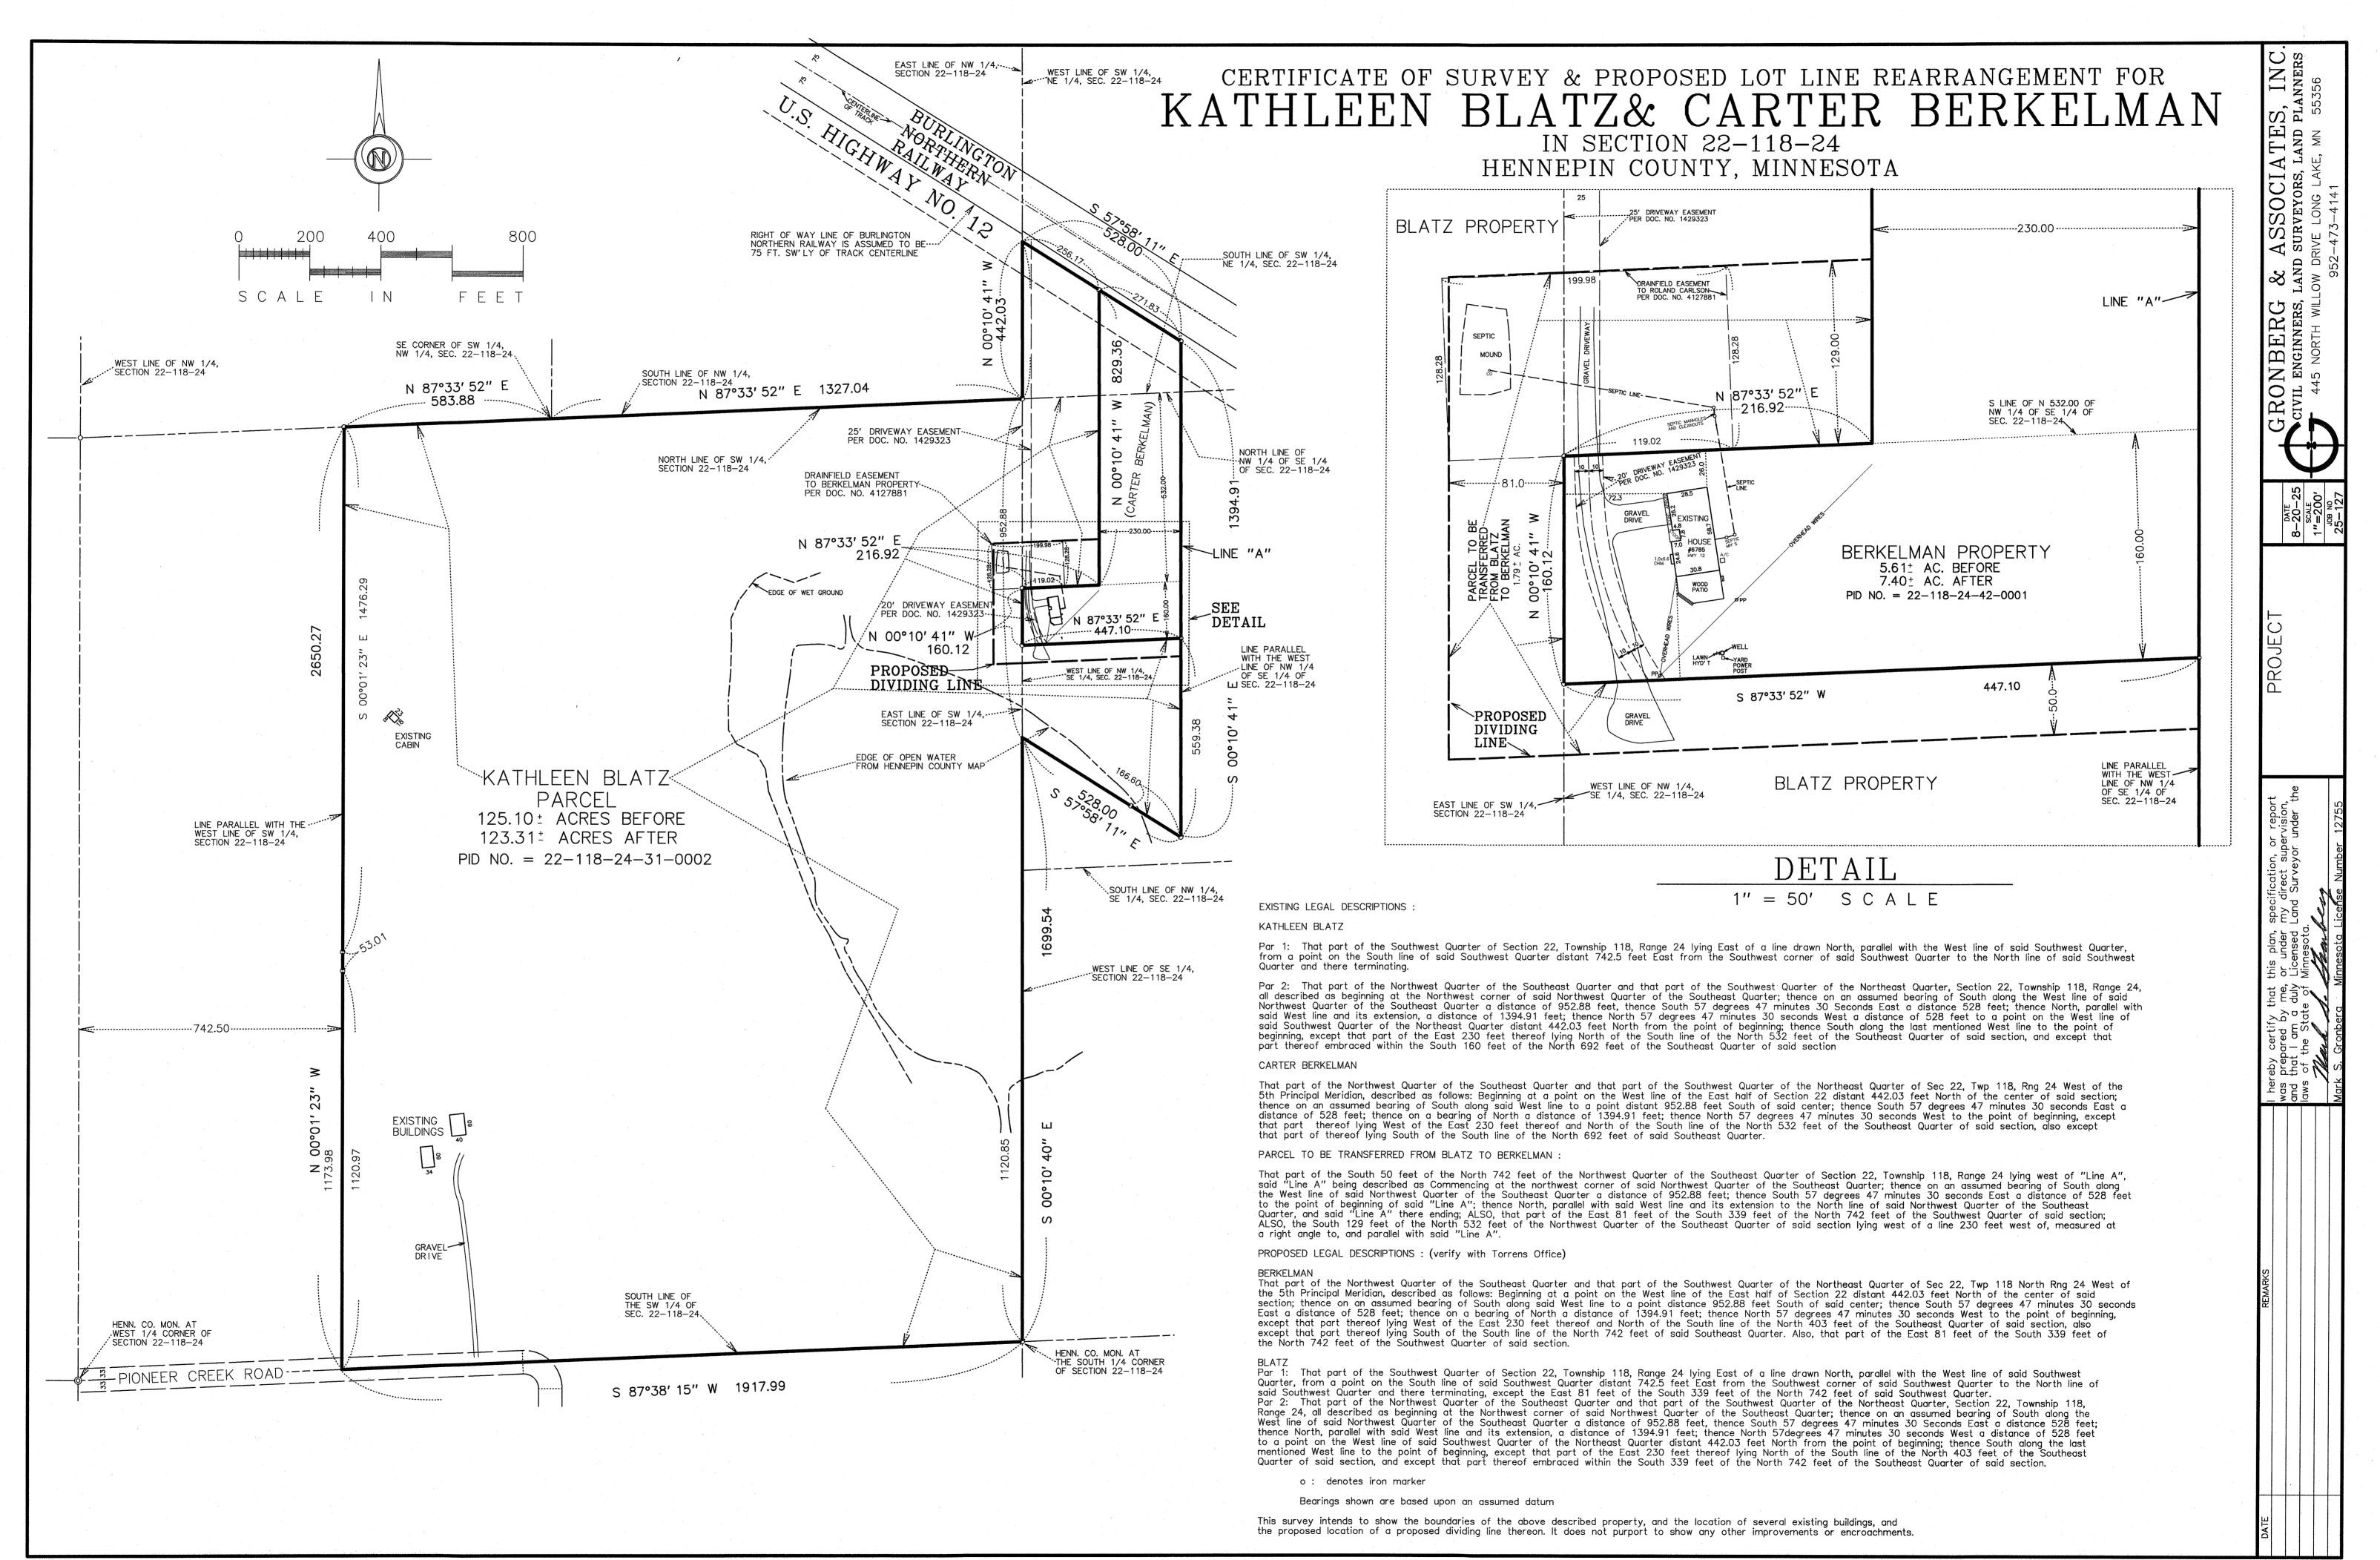


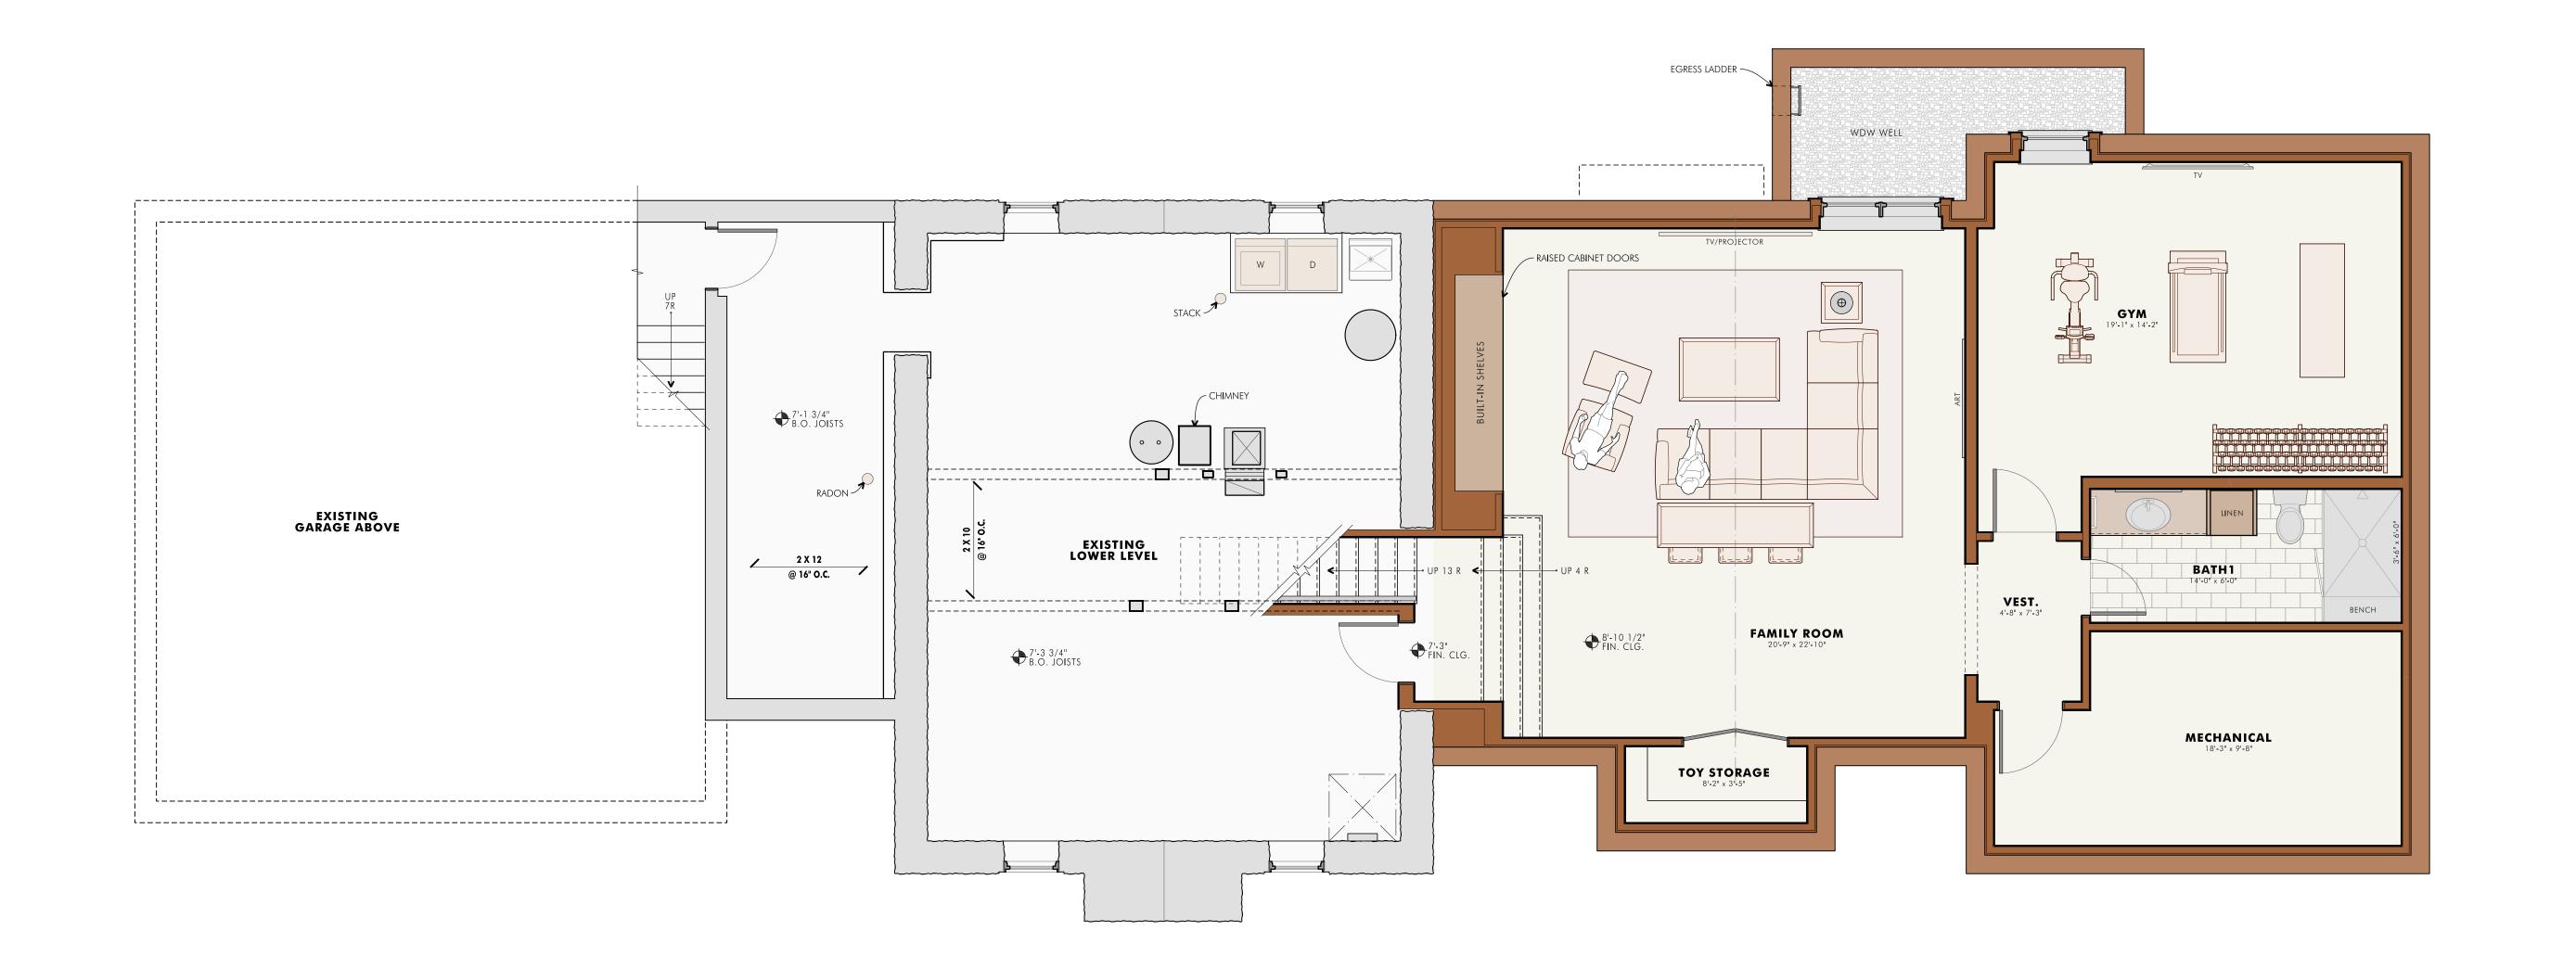

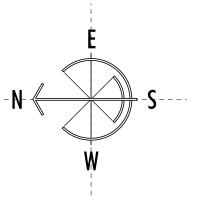

Berkelman Krueger Addition




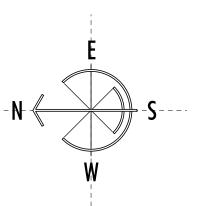


TEA2
ARCHITECTS
06.17.2025

Proposed First Floor

Berkelman Krueger Addition

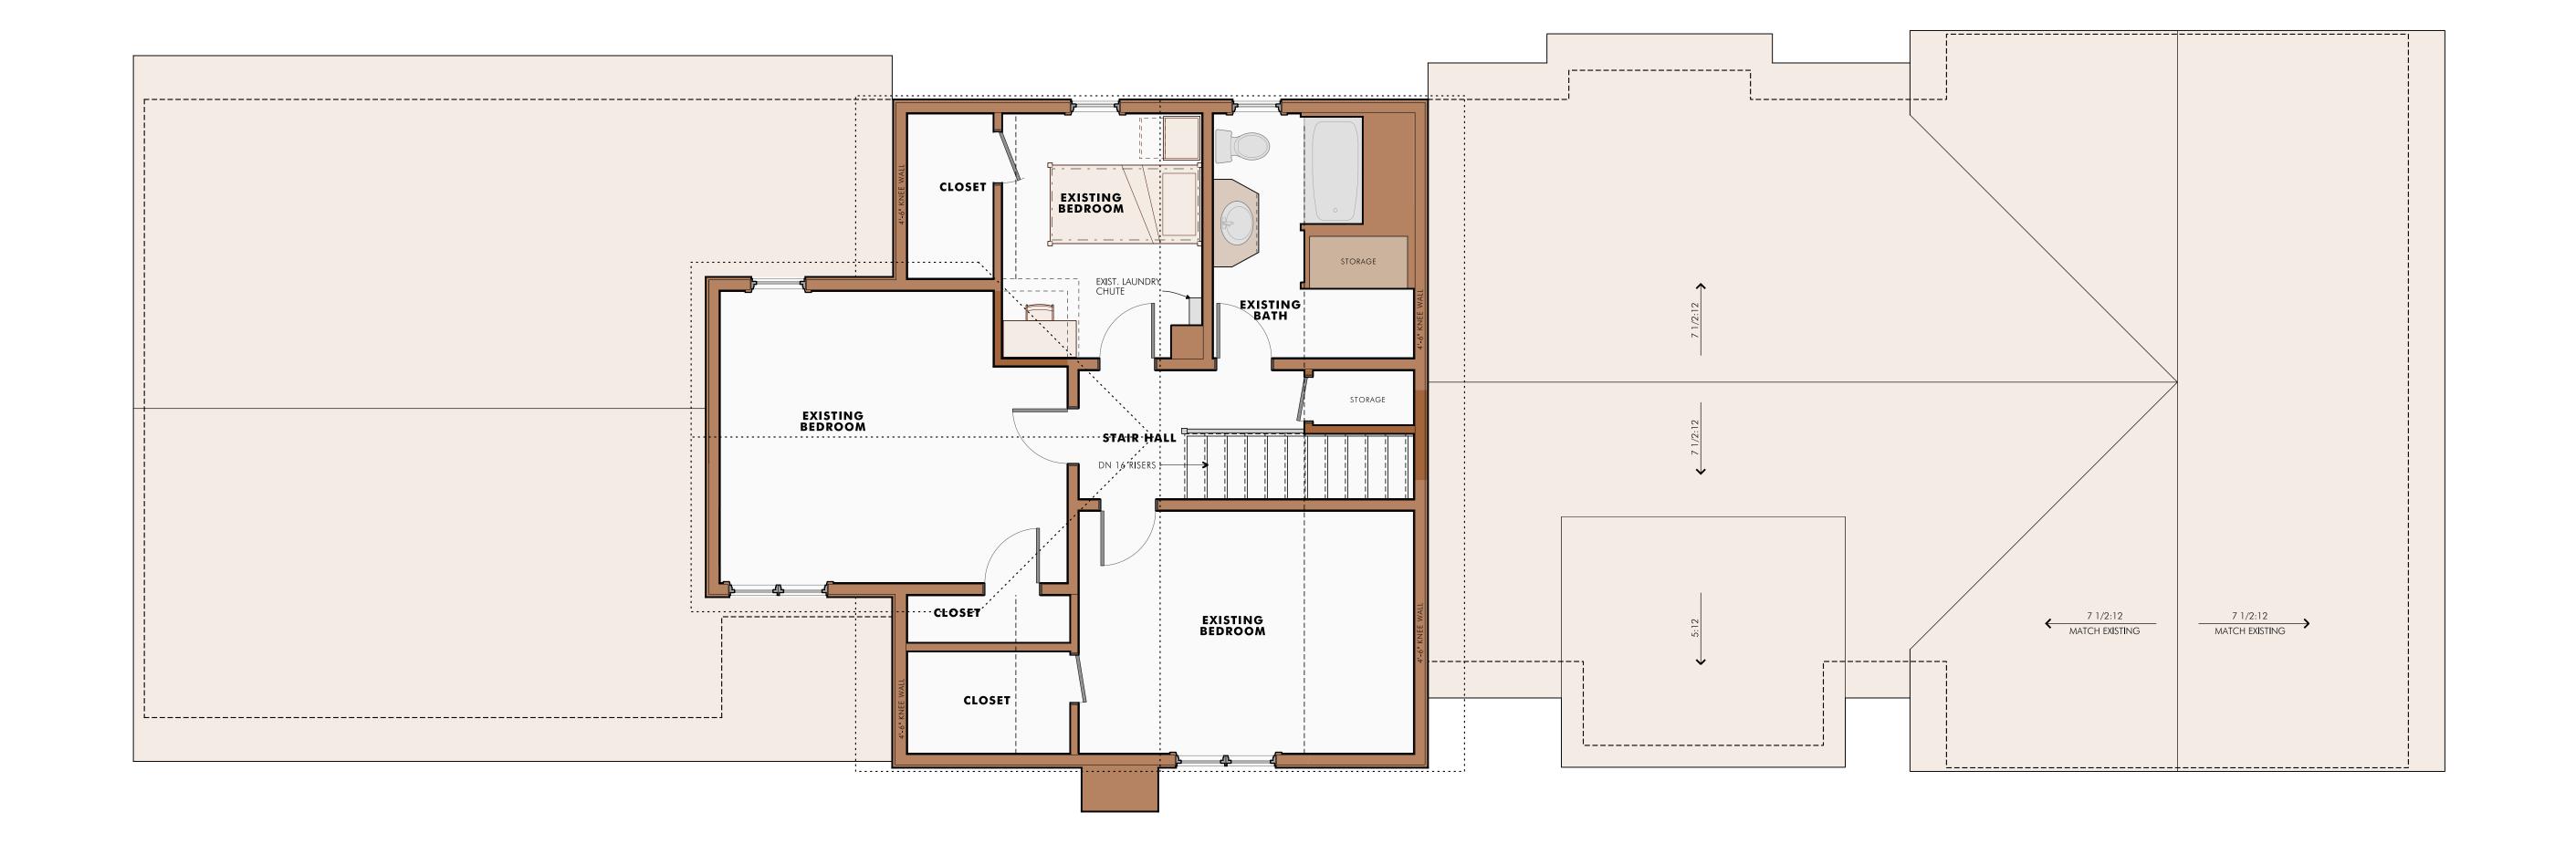

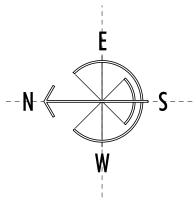

Berkelman Krueger Addition



TEA2
ARCHITECTS
06.17.2025

Existing West Elevation

Berkelman Krueger Addition



TEA2
ARCHITECTS
06.17.2025

Proposed West Elevation - Option A

Krueger Addition





06.17.2025 \_

Proposed West Elevation - Option B

Krueger Addition

# City of Independence

# Minor Subdivision and Variance to Permit a Rural View Lot for the Property Generally Located Just West of 6551 County Road 6 (PID No. 34-118-24-12-0001)

To: | Planning Commission

From: | Mark Kaltsas, City Planner

Meeting Date: September 16, 2025

Applicant: | Scott Kirchner

Owner: | Scott Kirchner

Location: Unassigned Address - County Road 6 (PID No. 34-118-24-12-0001):

### Request:

Scott Kirchner (Applicant) and Leroy Kowalke Et Al (Owner) requests that the City consider the following action for the Property located at 6551 County Road 6, Independence, MN (PID No. 34-118-24-12-0001):

- a. A minor subdivision to allow a rural view lot subdivision. The proposed rural view lot would be 16.9 acres and located on the south side of County Road 6 along the east property line.
- b. A variance to allow a rural view lot to exceed the maximum size of 10 acres.

# Property/Site Information:

The property is located on the north and south sides of County Road 6 just west of the intersection of County Road 6 and County Road 90. The property is currently vacant with no existing structures. The property is comprised of wetlands, wooded areas and upland pasture areas throughout. The property has the following characteristics:

Property Information: Unassigned Address – PID No. 34-118-24-12-0001


Zoning: *Agriculture* 

Comprehensive Plan: Agriculture

Acreage (BEFORE): 71.18 acres (this was prior to the recent 10-acre subdivision)

Acreage (AFTER): Remainder Parcel – 42.76 acres

*Proposed 16.9 Acre Parcel – 16.9 acres* 

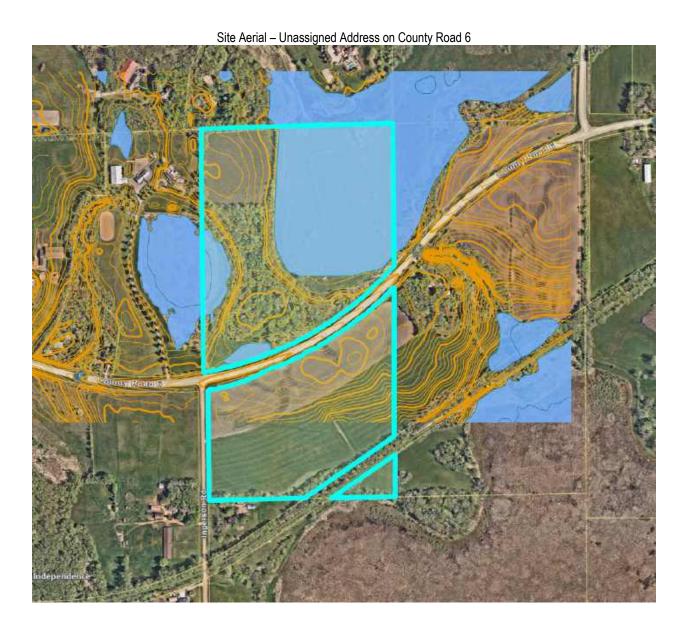

## Discussion:

The applicant recently received approval of a rural view subdivision to split off a 10-acre parcel on the south side of CSAH 6 in August of this year. Planning Commissioners briefly discussed whether this property was a nominal 80-acre parcel that could realize two (2) rural view lots rather than just one (1) rural view lot. The city's ordinance states the following relating to rural view lots:

<sup>b</sup> For the purpose of determining the number of rural view lots that can be created, the area of a lot of record shall be measured to the center of bounding road rights-of-way.

Furthermore, a lot of record that was originally subdivided into a quarter-quarter section and has not been further subdivided shall be deemed a 40-acre parcel for purposes of determining rural view lot eligibility. For properties within the jurisdiction of the shoreline ordinance (section 505), submerged lands within the boundaries of any waterfront parcel that are located waterward of the ordinary high-water mark shall not be used to compute the area of the lot.

The ordinance specifically describes 40-acre original quarter-quarter sections. The city could interpret this to also apply to nominal and unsubdivided 80-acre parcels. It could be considered that it was an original 80-acre parcel that has not been previously subdivided.

Another factor that has been historically considered by the city when considering rural view lot subdivision and or eligibility relates to the separation of properties that are bisected by an existing road. The city has generally considered properties that are bisected by public roads to have the ability to subdivide. In this case the applicant is now asking the city to consider a second rural view lot subdivision on the south side of CSAH 6. There are currently 16.9 acres of property remaining on the south side of the road after the 10-acre rural view lot was approved in July.

The proposed 16.9-acre parcel would exceed the maximum size allowed for rural view lots. The city would have to consider granting a variance to allow a rural view lot that exceeds the maximum lot size permitted. In this case, the variance would allow a rural view lot to exceed the maximum size of 10 acres by 6.9 acres.

Rural view lots must have the following characteristics:

**Lot size required**: between 2.5 and 10 acres

**Lot size proposed**: Proposed 10-acre Parcel – 16.9 acres

Minimum lot frontage required: 300 LF (for property between 5-10 acres)
Minimum lot frontage proposed: 572 LF (CSAH 6) / 771.56 LF (Ingerson)

Ratio of lot frontage to lot depth required - no more than 1:4 Ratio of lot frontage to lot depth proposed -  $\sim$ 1:1

In addition to the minimum size necessary to subdivide, the ordinance requires a minimum of 2.5 acres of buildable upland, 300 LF of frontage on a right of way and no greater than a 1:4 ratio of lot frontage to lot depth for each rural view lot. Based on the proposed subdivision, the rural view lot would have 16.9 acres of useable upland and more than adequate frontage on both County Road 6 and Ingerson Road.

The remainder of the property (Remainder Parcel) would comprise 42.76 acres and have one principal building entitlement. The Remainder Parcel would easily accommodate a new building pad on either the north or south side of County Road 6 given its overall size, topography and

proposed dimensions. Any development on the property would need to meet all applicable setbacks including those from wetlands. The city has received an on-site septic report verifying that the remainder property can accommodate a primary and secondary on-site septic system. The city is waiting on the report for the proposed 16.9-acre property. The report is required prior to City Council consideration of the subdivision. The applicant has included the requisite drainage and utility easements as required by ordinance (Section 500.15, Subd.'s 1 and 2) for both the proposed 16.9-acre parcel and the remainder parcel. The remaining property (north of County Road 6) will have <u>no</u> rural view lot subdivision eligibilities following this subdivision.

The City has standards for granting a variance which need to be considered prior to making a recommendation relating to the application. The standards established by the City require the applicant to demonstrate that the requested variance does not create a situation that is not in keeping with the character of the surrounding area. In addition, the applicant must demonstrate that the requested variance is unique to the subject property. The standards for granting a variance are as follows:

520.21. <u>Standards for granting variances</u>. Subdivision 1. The City Council may grant a variance from the terms of this zoning code, including restrictions placed on nonconformities, in cases where: 1) the variance is in harmony with the general purposes and intent of this zoning code; 2) the variance is consistent with the comprehensive plan; and 3) the applicant establishes that there are practical difficulties in complying with the zoning code (Amended, Ord. 2011-08)

Subd. 2. An applicant for a variance must demonstrate that there are practical difficulties in

complying with the zoning code. For such purposes, "practical difficulties" means:

- (a) The property owner proposes to use the property in a reasonable manner not permitted by the zoning code;
- (b) the plight of the property owner is due to circumstances unique to the property not created by the landowner;
- (c) the variance, if granted, will not alter the essential character of the locality.

Economic considerations alone do not constitute practical difficulties. Practical difficulties include, but are not limited to, inadequate access to direct sunlight for solar energy systems. (Amended, Ord. 2011-08)

Subd. 3. The City Council shall not grant a variance to permit a use that is not allowed under the zoning code based on the zoning classification of the affected property. (Amended, Ord. 2011-08)

520.23. Conditions and restrictions. The board of adjustments may recommend and the City Council may impose conditions on a variance. Conditions must be directly related to

and must bear a rough proportionality to the impact created by the variance. (Amended, Ord. 2011-08)

### Consideration of the standards for granting a variance:

- a. The applicants are proposing to use the property in a manner consistent with the AG-Agriculture Zoning District.
- b. The properties created by the subdivision are similar in nature and character to the surrounding properties.
- c. The character of the surrounding area is mixed residential/agricultural and guided for long term agriculture. The proposed subdivision and the properties that would be created appear to be in keeping with the City's comprehensive plan.
- d. The requested variance to allow the subdivision of the property is unique to this property. There may be several other properties in the City that have a similar condition.

The Planning Commission will need to determine if the requested variance to allow the subdivision of the property meets the requirements for granting a variance. The proposed subdivision, if approved, would create two properties that meet all other applicable criteria of the City's zoning ordinance.

The newly created 16.9-acre parcel will be required to pay the City's requisite Park Dedication fee. For this property the requirement is \$12,425.00. This fee will need to be paid prior to recording the subdivision.

Park dedication fee of \$3,500 per lot up to 4.99 acres, plus \$750 per acre for each acre over 5 acres

The city should note the following:

- The applicant will be required to submit verification of a primary and secondary on-site septic location for the proposed lot prior to City Council consideration of the requested minor subdivision.
- The city will address the property once approved.
- There are no remaining eligibilities with the north property.

The city will need to make two findings related to the requested minor subdivision and variance:

- The city will need to find that the intent of the rural view lot ordinance to include 80-acre properties that have not been subdivided and are considered original quarter-quarter sections.
- The city will need to find that the applicant has met all applicable criteria for granting a variance.

### **Neighbor Comments:**

The City had not received any written or verbal comments prior to this report being prepared.

### Recommendation:

Staff is seeking a recommendation from the Planning Commission regarding the request for a rural view lot subdivision and variance to allow a lot that exceeds the maximum lot size. Should the Planning Commission make a positive recommendation to the City Council, the following findings and conditions:


- 1. The proposed rural view lot subdivision and variance meet all applicable conditions and restrictions stated Chapter V, Section 510, Zoning, in the City of Independence Zoning Ordinance.
- 2. Prior to City Council consideration of the application, the applicant shall submit the following information to the city for review:
  - a) The applicant will be required to submit verification of a primary and secondary on-site septic location for the proposed lot.
- 3. City Council approval of the rural view lot subdivision and variance is subject to the following:
  - a) The Applicant shall pay the park dedication fees in the amount of \$12,425.00 for the newly created 16.9-acre Parcel, prior to the applicant receiving final approval to record the subdivision by the City.
  - b) The Applicant shall pay for all costs associated with the City's review of the requested minor subdivision.
  - c) The Applicant shall record the subdivision and City Council Resolution with the county within six (6) months of approval.
  - d) The Applicant shall execute and record the requisite drainage and utility and right of way easements with the county within six (6) months of approval.


- e) The Remainder Parcel will have no remaining rural view lot eligibilities.
- 4. The proposed subdivision meets the criteria for granting a variance due to the following findings:
  - a) The resulting rural view lot is in keeping with the character of the surrounding area.
  - b) The applicant did not create the condition that causes the property to have unique circumstances that warrant the variance.
- 5. The variance will allow a 16.9 acre rural view lot as shown on the approved survey exhibit.

### Attachments:

- 1. Application
- 2. Proposed Subdivision Exhibit (Before and After)



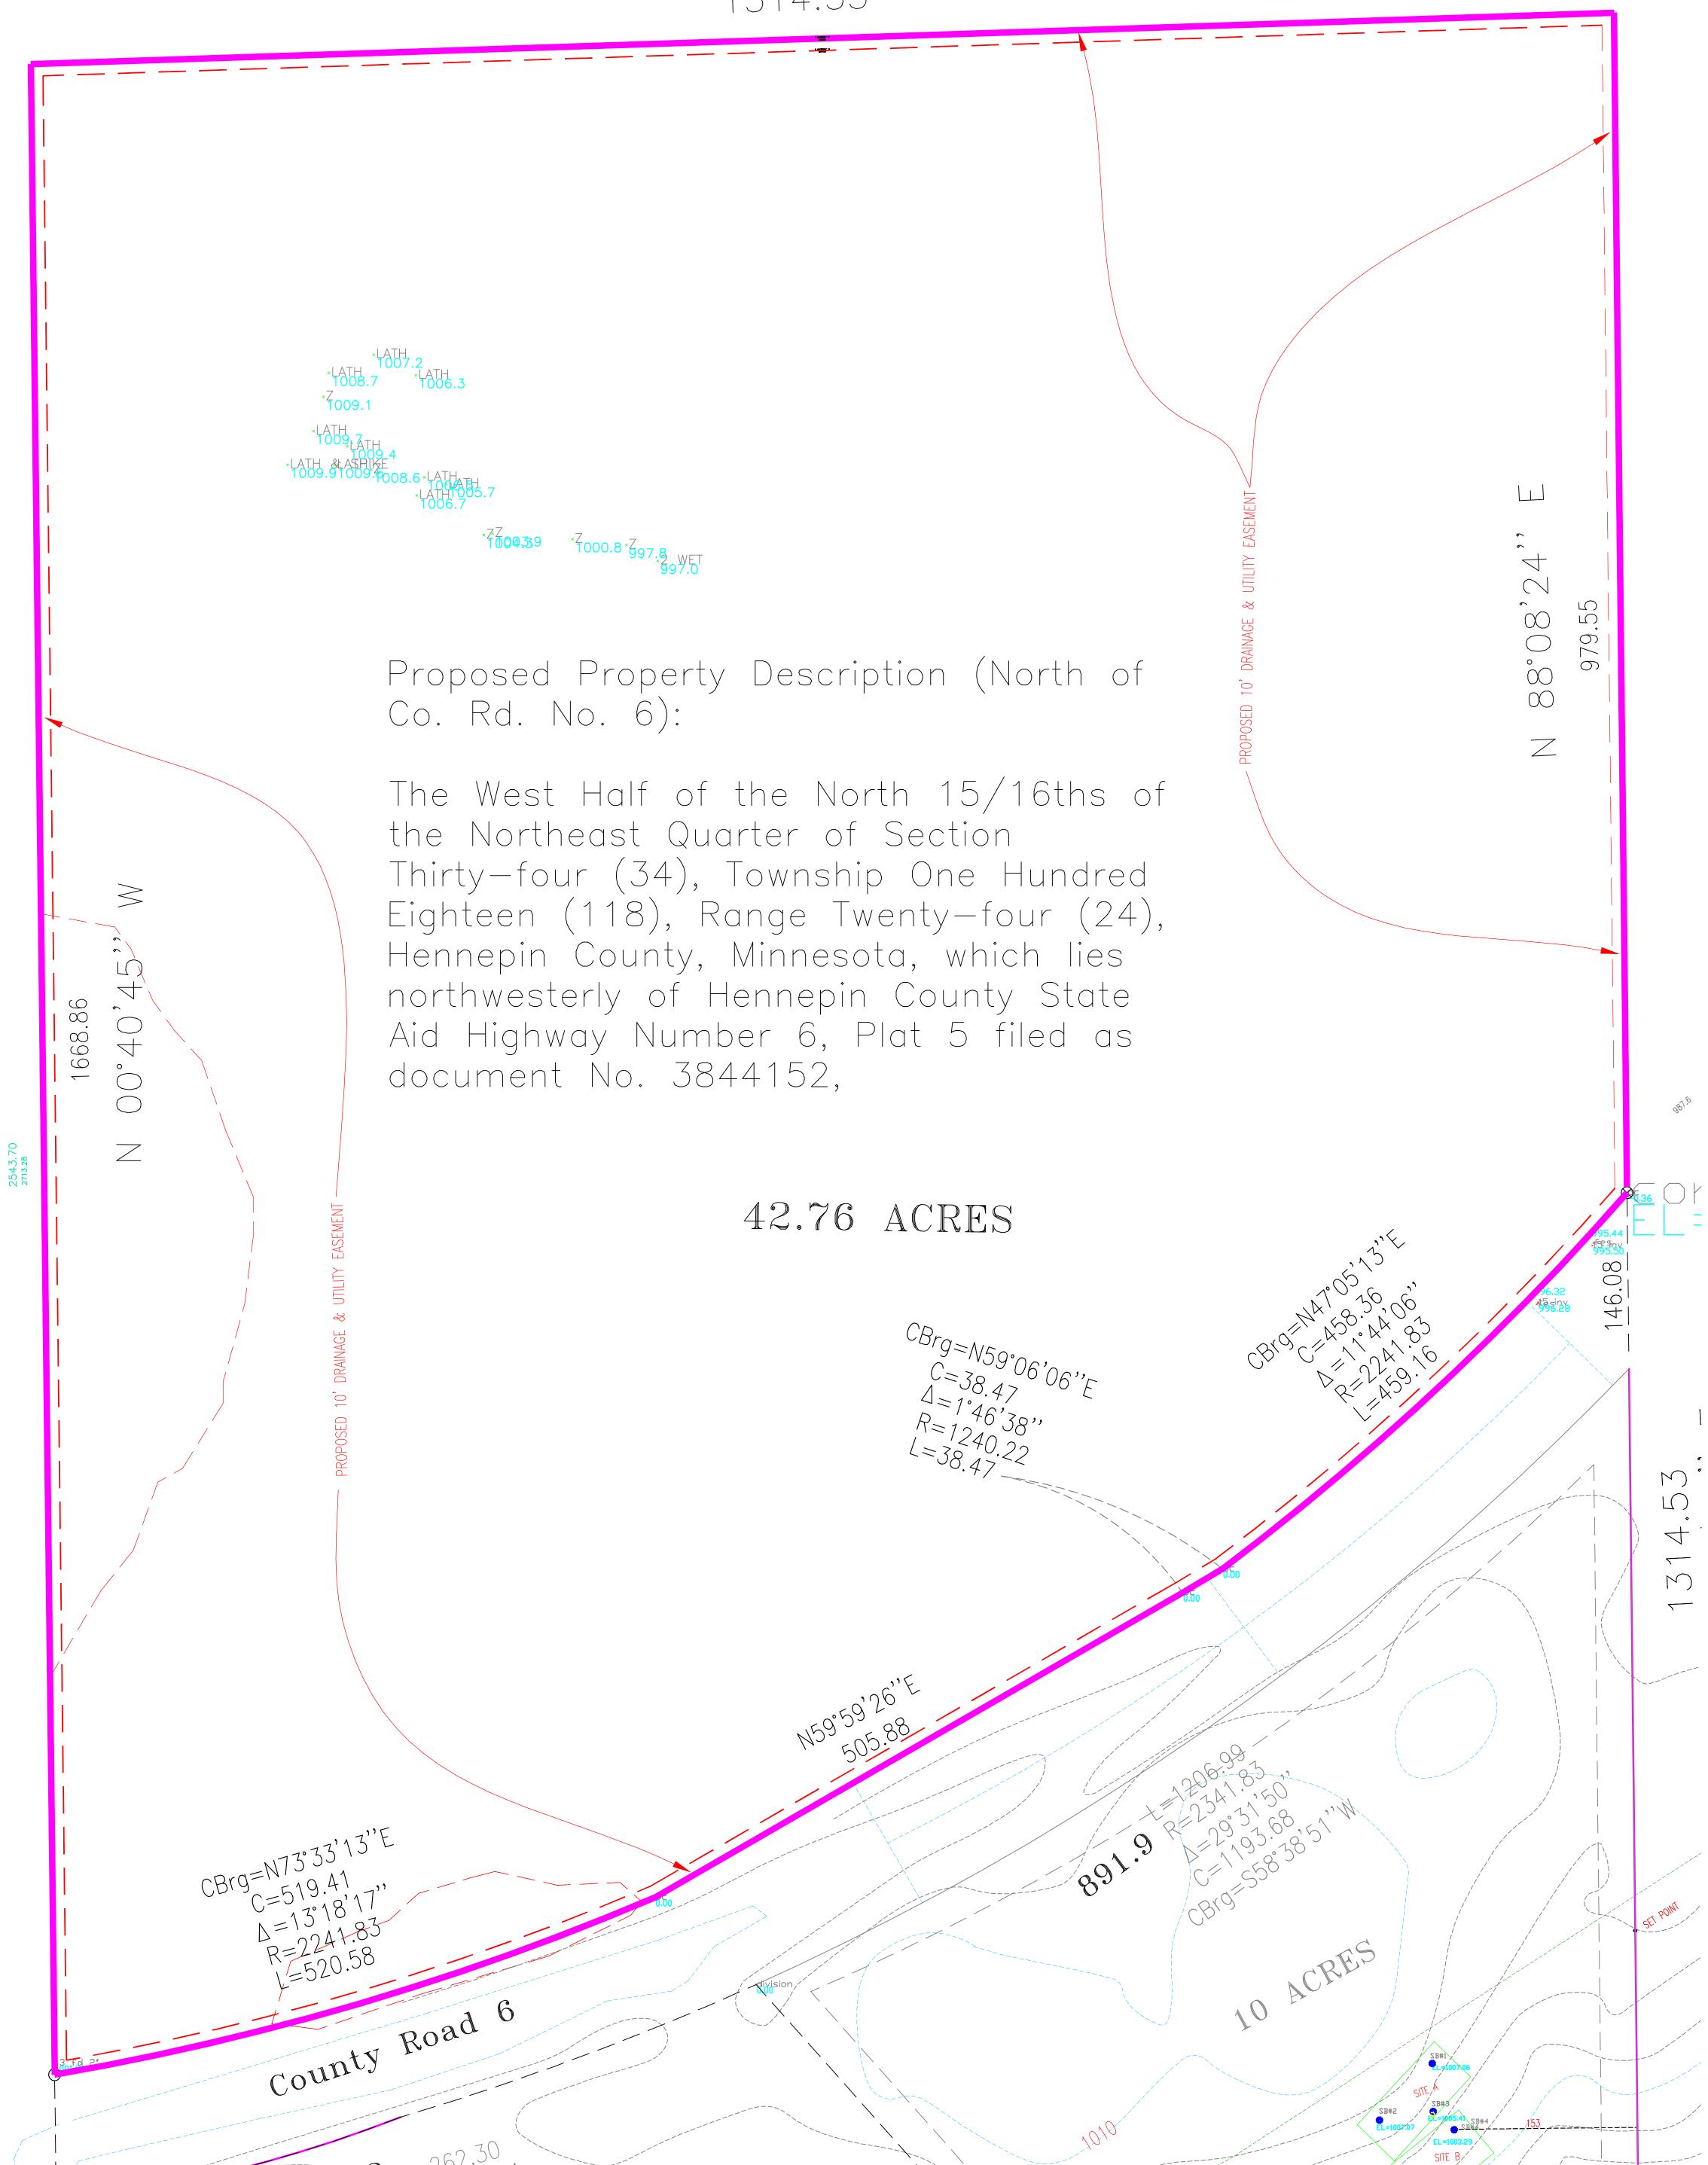

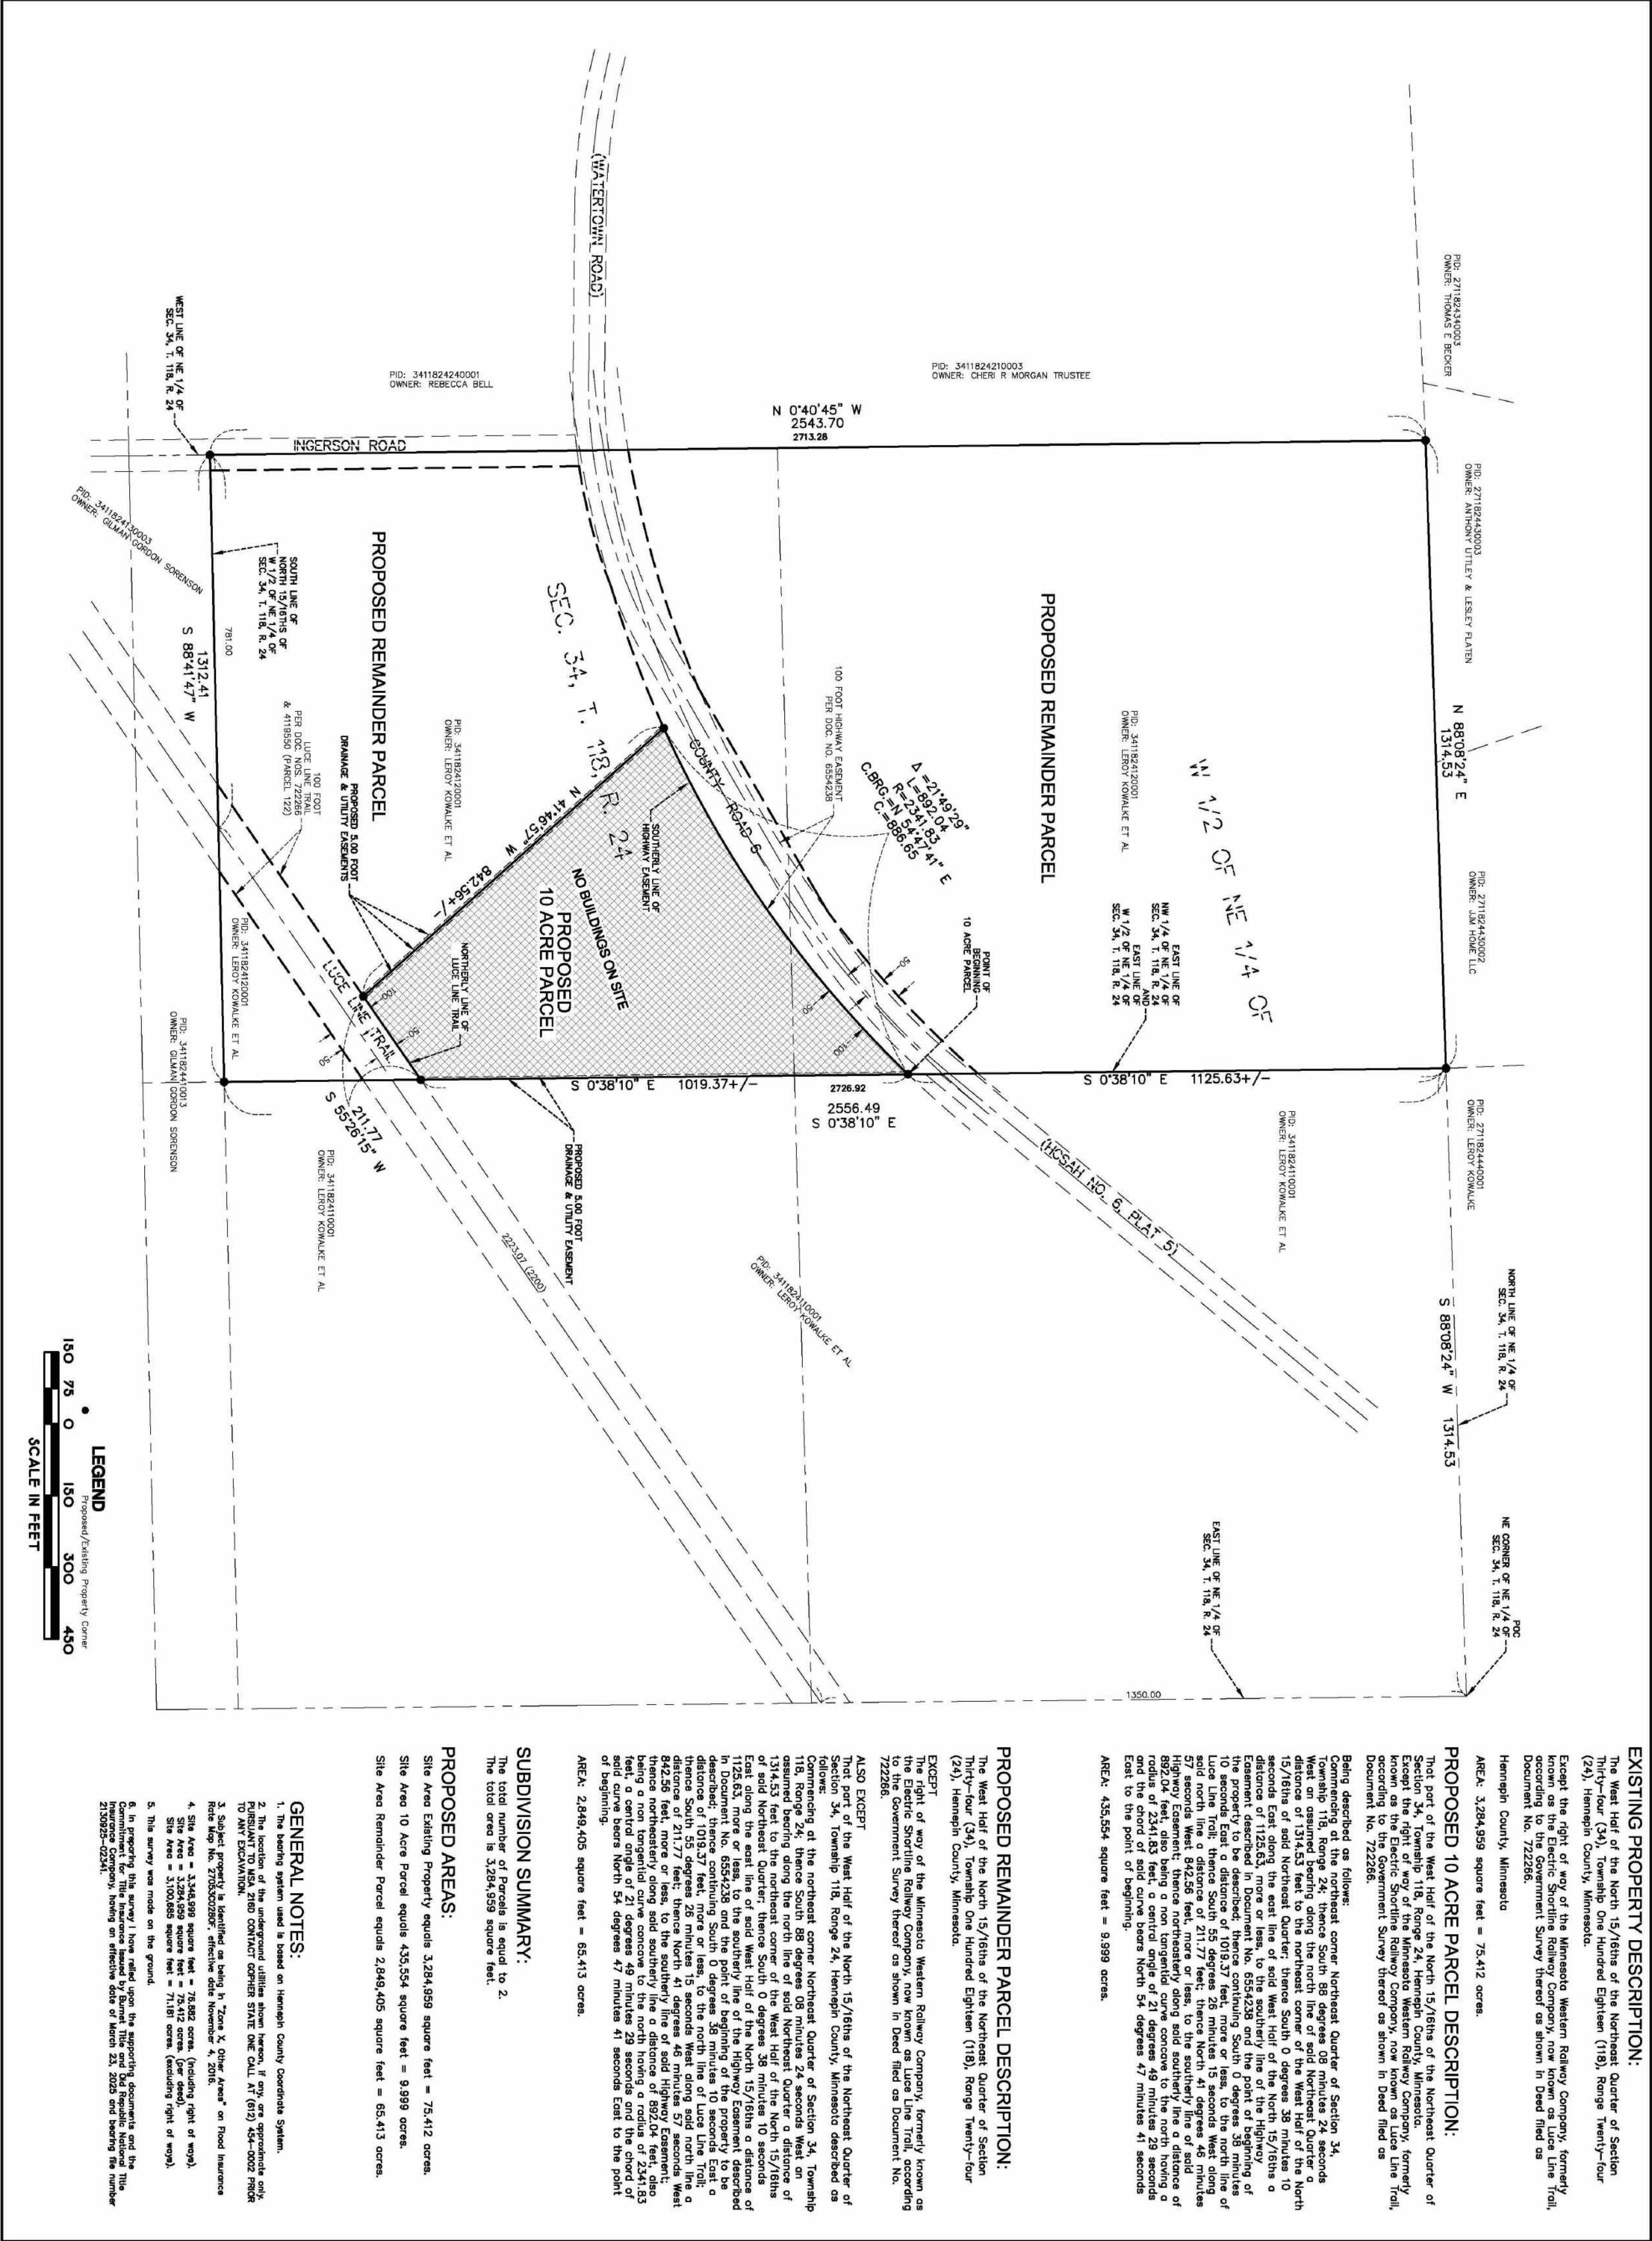

SCALE: 1 INCH = 150 FEET

REVISIONS

I hereby certify that this survey, plan or report was prepared by me or under my direct supervision and that I am a duly Registered Land Surveyor under the laws of the State of Minnesota

Thomas E. Hodorff, L.S.// Minnesota Reg. No. 23677

June 27, 2025

Area Existing Property equals 3,284,959 square feet = 75.412 acres.

Area Remainder Parcel equals 2,849,405 square feet = 65.413 ac

Subject property is identified as being in "Zone X, Other Areas" on Flood Insur Rate Map No. 27053C0280F, effective date November 4, 2016.

Site Area = 3,348,999 square feet = 76.882 acres. (including right of ways).
 Site Area = 3,284,959 square feet = 75.412 acres. (per deed).
 Site Area = 3,100,685 square feet = 71.181 acres. (excluding right of ways).

CAD File: 2025239.DWG Path: .t.\2025239\DWG\

1 OF 1

2025239

UNASSIGNED ADDRESS PID: 3411824120001 SITE INVEST WISE CAPITAL


PROPOSED PROPERTY SUBDIVISION

# **HENNEPIN COUNTY**

INDEPENDENCE, MINNESOTA

LAND SURVEYORS

9063 Lyndale Avenue South Bloomington, MN. 55437 Tele. 952-884-5341 Fax 952-884-5344

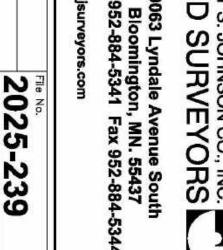

647