

CITY COUNCIL MEETING AGENDA TUESDAY FEBRUARY 20, 2024

CITY COUNCIL MEETING TIME: 6:30 PM

- 1. Call to Order
- 2. Pledge of Allegiance
- 3. Roll Call

4. <u>****Consent Agenda****</u>

All items listed under Consent Agenda are considered to be routine by Council and will be acted on by one motion. There will be no separate discussion of these items. If discussion is desired, that item will be removed from the Consent Agenda and will be considered separately.

- a. Approval of City Council Minutes from the February 6, 2023, Regular City Council Meeting.
- b. Approval of Accounts Payable; (Batch # 1; Checks Numbered 22624-22644, Batch # 2; Checks Numbered 22645-22660) <u>NOTE: Check Numbered 22621-22623 were voided due</u> to printing error.
- c. Approval of Additional Election Judges for 2024 PNP, Primary General Elections.
- d. Approval of annual liquor/tobacco license renewals for the following establishments:
 - i. Ox Yoke Inn Off Sale, On Sale and Sunday License
 - ii. Windsong Farm Golf Club LLC Off Sale, On Sale, Sunday and Tobacco License
 - iii. Pioneer Creek Golf LLC On Sale and Sunday License
- 5. Set Agenda Anyone Not on the Agenda can be Placed Under Open/Misc.
- 6. Reports of Boards and Committees by Council and Staff.
- 7. West Hennepin Public Safety Director Gary Kroells: Presentation of the January 2024 Activity Report.
- 8. William Stoddard (Applicant) Breck Farm, LLC (Owner) requests that the City consider the following actions for the property located at 9285 US Hwy 12, Independence, MN (PID No. 18-118-24-21-0001):
 - a. **ORDINANCE 2024-01** Considering approval of rezoning of a portion of the property (~28 acres) from AG-Agriculture to UC-Urban Commercial, consistent with the approved Comprehensive Plan.
 - b. **RESOLUTION 24-0220-01** Final Plat for the proposed subdivision consistent with the approved preliminary plat; and



Note: The city recently approved a preliminary plat and site plan review for a commercial development.

- 9. Open/Misc.
- 10. Adjourn.



CITY COUNCIL MEETING MINUTES TUESDAY FEBRUARY 6, 2024

CITY COUNCIL MEETING TIME: 6:30 PM

1. Call to Order

Pursuant to due call and notice thereof, a regular meeting of the Independence City Council was called to order by Councilor Spencer at 6:30 p.m.

2. <u>Pledge of Allegiance</u> Councilor Spencer led the group in the Pledge of Allegiance.

3. <u>Roll Call</u>

Present: Councilor Spencer (acting Mayor), Betts, Grotting Absent: McCoy, Mayor Johnson Staff: Kaltsas, Simon Visitors: George Betts

4. <u>****Consent Agenda****</u>

All items listed under Consent Agenda are considered to be routine by Council and will be acted on by one motion. There will be no separate discussion of these items. If discussion is desired, that item will be removed from the Consent Agenda and will be considered separately.

- a. Approval of City Council Minutes from the January 16, 2024, Regular City Council Meeting.
- *b.* Approval of Accounts Payable; (Batch # 1; Checks Numbered 22584-22595, Batch # 2; Checks Numbered 22597-22607 and Batch # 3; Checks Numbered 22608-22620) <u>NOTE:</u> <u>Check Numbered 22596 was voided due to printing error.</u>

Motion by Grotting, seconded by Betts to approve the Consent Agenda. Ayes: Betts, Grotting and Spencer. Nays: None. Absent: McCoy, Mayor Johnson. Abstain. None. MOTION DECLARED CARRIED. 3-0

- 5. <u>Set Agenda</u> Anyone Not on the Agenda can be Placed Under Open/Misc.
- 6. Reports of Boards and Committees by Council and Staff.

Spencer attended the following meetings:

• Pioneer Sarah Creek Watershed Meeting



- Meeting with Chris Getszel Environmental Services
- Loretto Fire District
- LMC Executive Committee

Kaltsas attended the following meetings:

- Meeting with Maple Plain/ Delano about Hwy 12 grant money to discuss how and what grants to apply for.
- Possible Bonding Bill
- Fire District meeting tomorrow morning. Maple Plain, Loretto, Corcoran, Medina, and Independence
- Meeting with LMC Director on Friday to talk about insurance premium costs for police officers and zoning control issues.
- 7. Public Safety Aid West Suburban Fire District Request for Funding.

Kaltsas – city received a one-time public safety aid payment. Allocated on population basis between cities. We have talked about this money as it relates to WHPS and Fire. At WHPS commission meeting, they voted to prorate share – formula looked at expenditures for each of the public entities as a percentage. We have approved through fire commission now. We have two fire depts now – MP and West Suburban. West Suburban did ask for the funds if cities were willing. Needs SCBA breathing equip. The two merging departments had different brands that did not work together. Based on the formula, 70/30 split. WS \$13,085.45. Asking for council to authorize those funds to West Suburban, but no decision on the remaining funding.

Motion by Spencer, seconded by Grotting to approve the payment of the share of funding at \$13085.45 be paid to purchase their SCBA apparatus. Ayes: Betts, Grotting and Spencer. Nays: None. Absent: McCoy, Mayor Johnson. Abstain. None. MOTION DECLARED CARRIED. 3-0

- 8. Open/Misc.
- 9. Adjourn.

Motion by Betts, seconded by Grotting to adjourn at 6:40pm. Ayes: Betts, Grotting and Spencer. Nays: None. Absent: McCoy, Mayor Johnson. Abstain. None. MOTION DECLARED CARRIED. 3-0

Meeting adjourned.

Respectfully Submitted, Carrie Solien/Recording Secretary

City of Independence

Approval of Election Judges for the 2024 Elections

To:City CouncilFrom:Amber SimonMeeting Date:February 20, 2024

Discussion:

The City Council is required to appoint election judges for the upcoming PNP, Primary and General elections to be held on March 5th, August 13th and November 5th. Staff has prepared a list of election judges for consideration by the City Council. The following election judges can be considered for appointment by the City Council:

- JonPaul Story
- Julie Larson
- Leith Dumas
- Marvin Johnson
- Barbara Janas
- Thomas Janas
- Brad Spencer
- Lisa Spencer
- Sarah Baker
- Susan Ritts
- Nick Lafond
- Lynette Boyd Timpe
- Charles Hayes
- Damon Kocina
- Lori McNamara
- Beth Horner
- Steve Horner

Recommendation:

It is recommended that the City Council approve appointing the two additional listed election judges.

To: City Council

From: Amber Simon, Administrative Services Director

Meeting Date: February 20, 2024

Discussion:

The City annually reviews and considers renewal of on and off sale liquor licenses and tobacco licenses. The City has three (3) businesses which annually renew their respective liquor licenses. The following applications have been made to the Council:

Ox Yoke Inn:	Off Sale, On Sale and Sunday License
Windsong Golf Club:	Off Sale, On Sale and Sunday License and Tobacco License
Pioneer Creek Golf Club:	On Sale, Sunday License

Attachments: Liquor Applications

Date: February 12th, 2024

To: Public Safety Commissioners City of Independence Council Members City of Maple Plain Council Members

From: Director Gary Kroells

SUBJECT: JANUARY 2024 ACTIVITY REPORT



The purpose of this report is to give the reader a quick overview of the activities of the Public Safety Department each month. It also compares monthly and year-to-date information to the reader.

The report is broken down into five categories, as defined by the Criminal Justice Reporting System.

CRIMINAL-- Criminal is broken down into Part I and Part II crimes.

Part I includes crimes against persons versus crimes against property; criminal homicide, forcible rape, robbery assault, aggravated assault, burglary -breaking or entering, larceny-theft, larceny analysis, motor vehicle theft and arson.

Part II includes other assaults, forgery and counterfeiting, fraud, embezzlement, stolen property, buying, receiving, possession; vandalism, weapons, carrying, possessing, etc.; prostitution and commercialized vice, sex offenses; drug abuse violations, gambling, offenses against the family and children, driving under the influence, liquor laws, drunkenness, disorderly conduct, vagrancy, all other offenses, suspicion, curfew and loitering laws - persons under 18; and runaways - persons under 18.

- TRAFFIC-- Includes violations of the road and driving laws.
- PART III-- Lost and Found: Includes lost and found persons, animals, and property, and stalled and abandoned vehicles.
- PART IV-- Casualties: Includes all motor vehicle crashes, boating, and snowmobile; public home occupational accidents, fires, suicides, sudden deaths, burning permits, and burning violations.
- PART V-- Miscellaneous Public: Includes open doors, gun permit applications, suspicious activities, animal complaints, motorist assists, alarm calls, parking complaints, house checks, driving complaints, civil matters, family disputes, department assists.

The balance of the report shows the total number of incidents handled, miles driven and how the Public Safety Department received calls. If anyone should desire more detailed statistical data, please contact my office.

		y Activity Re nuary 2024	•	
Offense	This Month	Same Month Last Year	This Year To Date	Last Year To Date
City Of Independence				
Criminal	2	1	2	1
Traffic	102	61	102	61
Part III	0	1	0	1
Part IV	43	26	43	26
Part V	94	94	94	94
Total City of Independence	241	183	241	183
City Of Maple Plain				
Criminal	1	1	1	1
Traffic	22	14	22	14
Part III	3	1	3	1
Part IV	25	22	25	22
Part V	44	32	44	32
Total City Of Maple Plain	95	70	95	70
Grand Total Both Cities	336	253	336	253
TZD	20	6	20	6
Agency Assists	21	13	21	13
Total ICR Reports	377	272	377	272
How Received				
Fax	4	10	4	10
In Person	10	11	10	11
Mail	2	0	2	0
Other	1	1	1	1
Phone Radio	19 150	14 118	19 150	14 118
Visual	150		146	92
Email	146		140	13
Lobby Walk In	29	13	29	13
	29	13	29	13
Total	377	272	377	272

January 2024 Part I & II


City of Maple Plain #'s 1 & 2

AGN	ICR	Title	Create Date	Grid #	MOC range	UCR Part
WHPS	24000008	3 rd Degree DWI – B-Card Arrest	2024-01-01	01	JF501	2

January 2024 Part I & II

City of Independence Grid #'s 3-5

AGN	ICR	Title	Create Date	Grid #	MOC range	UCR Part
WHPS	24000099	Damage Prop/Rpt	2024-01-08	04	P1114	2
WHPS	24000235	PD Crash DWI	2024-01-22	03	DH500	2

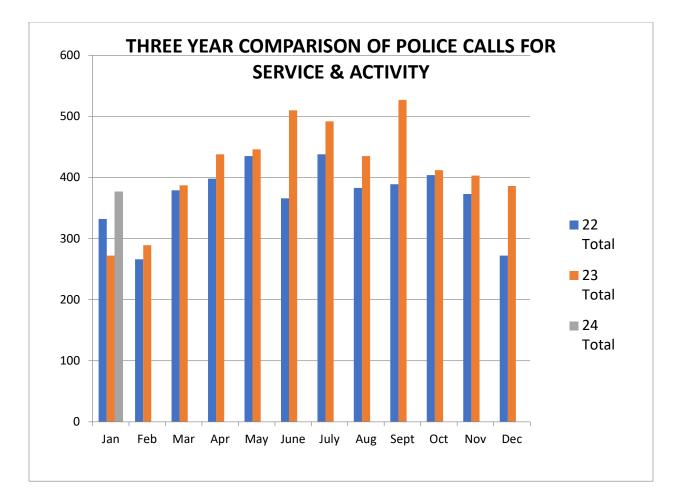

DIRECTOR'S NEWS & NOTES

WEST HENNEPIN PUBLIC SAFETY January 2024 Activity Report

Year to Date Activity Report

At the end of January 2024, West Hennepin Public Safety (WHPS) handled year-to-date a total of 377 incident complaints. For the month of January; 241 incidents occurred in the City of Independence and 95 in the City of Maple Plain.

The Criminal Part I and Part II cases for both cities have been highlighted for your review on the attached documents.

Arrest

January 1

Intersection of Highway 12 and Baker Park Road, Maple Plain. Officer was on routine patrol and observed a vehicle with a headlight out. Officer stopped the vehicle and spoke to the driver. Officer observed indications of impairment. When questioned, the driver advised he was sure he would be over a 0.08 BAC. Driver was found to have a no use of alcohol restriction (B-card) on his driver's license. Driver refused field sobriety tests and submitted a preliminary breath test that indicated 0.248. Driver was arrested for DWI and B-card restriction violation and transported to Hennepin County Jail.

Crash

January 2

Intersection of County Road 11 and Lake Haughey Road, Independence. Officer was dispatched to a hit deer. Officer arrived on scene and was advised the driver was not injured. Driver advised the deer ran out and struck the front end of the vehicle. Vehicle had minimal damage to its hood. The deer was unable to be located. Officer took photos and the driver was about to drive the vehicle away.

Crash

January 3

Intersection of Highway 12 and Budd Avenue, Maple Plain. Officer was dispatched to a property damage crash. Officer arrived on scene with MPFD and found the driver of one vehicle hit her head on the window. It was determined one vehicle pulled out in front of another vehicle causing the crash. Both vehicles sustained damage that required them to be towed. One driver was found to have a revoked driving status. One driver was cited for failure to yield at an intersection and the other was cited for driver after revocation.

Mental Health

January 5

1300 block of County Road 83, Independence. Officer was dispatched to a welfare check. The reporting party advised his wife took multiple pills because she was upset about a home visit with Child Protection Services. She took the pills with alcohol and made suicidal comments. North Memorial Paramedics arrived on scene and followed-up with poison control who advised she should be seen. Ultimately, she was transported to the hospital.

Crash

January 6

Intersection of County Road 6 and County Road 90, Independence. Officer was dispatched to a property damage crash. Officer arrived on scene and found that one vehicle had pulled to the right shoulder with their right turn signal on acting like they were pulling over to let vehicles go around them. The second vehicle continued straight when the first vehicle then makes a left turn to get onto County Road 90, causing the collision. The driver of the first vehicle was cited for the lane violation. Both drivers were able to drive their vehicles away from the scene.

Damage to Property

January 8

Intersection of Kochs Crossing and William Way, Independence. Officer was dispatched to a damage to property report. It was reported multiple signs were damaged or stolen in a new development. It was found 19 signposts were broken and 7 realty signs were missing or damaged. Extra patrol was requested.

Domestic

January 9

1600 block of Marsh Avenue, Maple Plain. Officer was dispatched to a domestic called in by a third-party. It was found to be a civil matter. There have been on-going disturbances between two individuals. Homeowner wasn't renter out of the home but was advised the eviction process will have to be utilized. Both individuals stay away from each other and ignore one another while residing at the home. Resources were given and no crime was committed.

Crash

January 10

Intersection of Highway 12 and County Road 92, Independence. Officer was dispatched to a two-vehicle property damage crash. It was found that one driver looked down to pick up her coffee cup when traffic slowed down going into the roundabout and she struck the vehicle in front of her. The driver who caused the crash was cited for failure to driver with due care.

Suspicious Activity

January 11

1700 block of County Road 90, Independence. Officer was on routine patrol and located a vehicle in a closed business running with its lights on. Officer approached the vehicle and observed a younger male and female in the backseat. The female was putting her shirt back on while the officer approached. Officer identified each individual and separated the two. Female party advised everything was consensual, she had snuck out of the house, and was picked up by the young man. Female was driven home, and mother was contacted.

Traffic Complaint

January 11

Intersection of Highway 12 and Halgren Road, Maple Plain. Officer was dispatched to a driving complaint where a vehicle was swerving and driving erratically. The reporting party gave the wrong direction of travel and Officer was not able to catch up. Call was passed along to a neighboring agency where it was later stopped.

Public Assist

January 12

4800 block of Three Oaks Avenue, Maple Plain. Officer was dispatched to assist a resident with a smoke alarm that continued to beep. Homeowner believed the battery was dead. Officer arrived on scene and assisted the homeowner with changing the batteries, but the alarm continued to beep. Officer advised the smoke alarm will need to be replaced. There were several other alarms active and in working order in the home.

Fire Alarm

January 14

1500 block of Howard Avenue, Maple Plain. Officer was dispatched to a report of smoke alarms sounding in an apartment. Officer responded along with MPFD. It was believed the apartment was vacant. Officer made entry to the unit and found multiple items that have not been cleared out yet. The apartment thermostat was set to cooling and the temperature was 50 degrees. Officer turned the thermostat up and reset the smoke alarm.

Crash

January 15

Intersection of County Road 11 and County Road 92, Independence. Officer was dispatched to a crash with unknown injuries. Officer responded and found there were no injuries. Officer spoke to both drivers, and it was found one driver failed to yield causing the crash. Driver was cited for failure to yield to right of way.

Medical

January 15

5200 block of Manchester Drive, Maple Plain. Officer was dispatched to a medical where a patient was confused and dehydrated. Officer arrived on scene and met with the patient who was sitting upright in a recliner. The patient was alert and oriented. North Memorial Paramedics arrived on scene and took over patient care. Patient's power of attorney was on scene and requested the patient be taken to the hospital. Patient was transported.

Found Property

January 16

1800 block of Newport Street, Maple Plain. A good Samaritan dropped off found property to the police department lobby. The good Samaritan advised a sewing machine had been sitting on the side of the road for some time. It didn't appear there were any footprints in the snow. It is unknown who the sewing machine belongs to. It was placed into evidence for safekeeping.

Hit Deer

January 17

Intersection of County Road 90 and Koch's Crossing, Independence. Officer was dispatched to a deer hit by a vehicle. Officer arrived on scene and met with the driver who advised the deer was injured, unable to stand, and was crawling into the tree line. Officer located the deer who clearly had a broken leg with the bone sticking out. Officer dispatched the deer and drug it back to the edge of the trees. A resident volunteered to take the deer.

Traffic Complaint

January 18

Intersection of County Road 92 and County Road 11, Independence. Officer was dispatched to a driving complaint where a vehicle was driving slowly and swerving. Officer checked in-house records and found previous contacts. It was found the driver was an elderly male that does driver slow. There was a 30-minute delay in the call. Information received.

Welfare Check

January 19

1600 block of Pioneer Avenue, Maple Plain. Officer was dispatched to a welfare check where it was reported an individual was sleeping in a vehicle. Officer looked up previous contacts with the plate and learned the registered owner frequently sleeps in her vehicle all over the west metro. Officer arrived on scene and met with her. She advised she was waiting for one of her friends to get home who lives nearby. She refused assistance and resources.

Welfare Check January 20

1400 block of Halgren Road, Maple Plain. Officer was dispatched to a welfare check that sounded physical. Reporting party stated her son was dealing with a mental health crisis and husband was currently holding him down. Officers arrived on seen and found the subject standing in the kitchen with the reporting party. The subject was breathing heavy and was clearly worked up. Officers observed a coffee table flipped over with items scattered on the floor. Ultimately, it was found no assault had occurred. Subject was having difficulties managing his mental health diagnosis and was suicidal. He was placed on an emergency hold and transported to the hospital. Embedded social worker was notified.

Arrest

January 22

Intersection of Highway 12 and County Road 90, Independence. Officer was dispatched to a crash where the driver was possibly impaired which was reported by an off-duty police officer. Officer arrived on scene and found the driver drove off the round and hit a highway guard rail head on with severe damage to the vehicle. Driver showed multiple indicators of impairment and performed poorly on field sobriety testing. Driver was arrest for DWI controlled substance. A search of the vehicle was performed incident to arrest and a white powdery substance was found on the passenger floor. A search warrant was signed for a blood draw. The substance was sent to the BCA for testing. Charges are pending lab results.

Crash

January 23

Intersection of Highway 12 and County Road 90, Independence. Officer was dispatched to multiple crashes at the County Road 90 roundabout due to freezing rain and icy roads. All drivers were able to leave the scene without injuries. MNDOT was advised to place salt in the area.

Motorist Assist

January 24

Intersection of County Road 6 and County Road 157, Independence. Officer was dispatched to a driver attempting to change a flat tire on the side of the road. Called requested police lights for safety. Officer arrived on scene and assisted the driver with changed the tire. The tire rim as stuck to the rotor making it difficult to take off. Eventually, the spare was installed, and the driver was able to leave the scene.

Crash

January 25

Intersection of County Road 92 and Maple Ponds Trail, Independence. Officer was dispatched to a vehicle in the ditch. Officer arrived on scene and spoke to the driver who advised she was driving and hit a patch of ice causing her to lose control of her vehicle. Vehicle went into the ditch and through a fence. Property owner was notified and shown the damage. Information was exchanged. Roads were wet and slippery at the time of the crash.

Welfare Check

January 25

2000 block of South Lake Shore Drive, Independence. Officer was dispatched to check the welfare of an individual called in by a third party. Reporting party advised she was on the phone with the subject when she was informer her face was numb. The subject recently had a stroke, and the patient wasn't answering the phone. Officer arrived on scene, and no one was answering the door to the residence. The front door was found to be unlocked. Officer entered the house and confirmed the subject was not present. The subject's sons had arrived and advised she was at the bar, and everything was okay.

Motorist Assist

January 26

2200 block of County Road 92, Independence. Officer was on routine patrol and observed a vehicle stuck in the ditch blocking traffic. Officer spoke to the driver who advised they are a delivery person. He stated he missed his stop and attempted to make a U-turn but high topped the vehicle in the ditch. Driver already had a tow truck enroute. Officer stood by with emergency lights due to the traffic hazard.

Suspicious Activity

January 28

1400 block of Rainbow Avenue, Maple Plain. Officer was dispatched to suspicious activity information. Reporting party advised she discovered a small white rock on the top of her doorbell camera and though it was suspicious. Officer inquired about video if the rock was placed there, and reporting party advised the camera had been turned off due to a party at the house. She also reported a red car stopped across the street the other day and it seemed out of place. Officer advised her to turn her camera back on and to call if further suspicious activity occurs.

Mental Problem

January 29

4200 block of Woodhill Drive, Independence. Officer was dispatched to a juvenile with a knife being violent towards parents. Officers arrived on scene and met with the reporting party who advised his son had calmed down and dropped the knife. Officer spoke to the juvenile, and he agreed to an emergency transport hold. North Memorial Paramedics arrived and transported the patient to the hospital.

Traffic Complaint

January 30

Intersection of Highway 12 and County Road 92, Independence. Officer was dispatched to a driving complaint where a vehicle had been swerving. Officer located the vehicle and initiated a traffic stop. Officer spoke to the driver who advised they were aware they were swerving and thought it was due to a low tire. Driver showed no signs of intoxication. Officer spoke to the driver about better driving options and to get the tired filled up with air.

Suspicious Activity

January 31

Intersection of County Road 110 and Moline Road, Independence. Officer was dispatched to a male walking in the roadway, making weird gestures, and exhibiting off behavior. Officers located the individual and recognized him from prior contacts. Officers spoke to the individual who advised he was walking to a nearby food shelf. Officer contacted the party's wife who serves as his guardian and convinced him to return home. Officer transported the individual back to his residence.

City of Independence

Consideration of the Rezoning, Final Plat and Developers Agreement Application for the Propety Located at 9285 Highway 12

То:	City Council Mark Kaltsas, City Planner
From:	Mark Kaltsas, City Planner
Meeting Date:	February 20, 2024
Applicant:	William Stoddard
Owner:	Breck Farm, LLC
Location:	9285 Highway 12

Request:

William Stoddard (Applicant) Breck Farm, LLC (Owner) requests that the City consider the following actions for the property located at 9285 US Hwy 12, Independence, MN (PID No. 18-118-24-21-0001):


- a. Rezoning of a portion of the property from AG-Agriculture to UC-Urban Commercial.
- b. Final Plat and Development Agreement to allow the subdivision of the property into seven (7) residential lots and associated lots to allow the proposed commercial development.

Property/Site Information:

The property is located on the south side of Highway 12 and west side of Nelson Rd. The property has frontage on both roads and is comprised primarily of agriculture land, woodlands and wetlands. There is an existing home and several detached accessory structures on the subject property.

Property Information: **9285 Highway 12** Zoning: *Agriculture* Comprehensive Plan: *Agriculture/Urban Commercial* Acreage: ~58 acres

9285 Highway 12

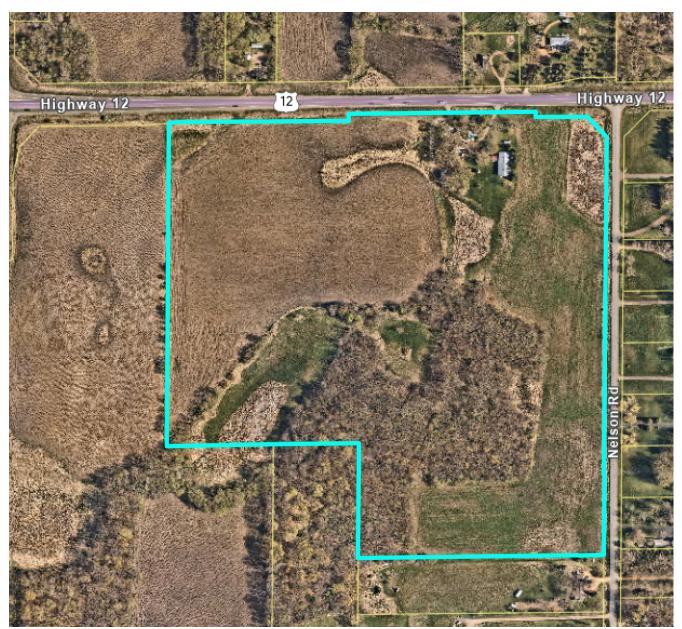


The City approved preliminary plat, site plan review, conditional use permit and comprehensive plan amendment earlier this year. The applicant has applied for final plat and rezoning. There were several outstanding items that needed to be resolved prior to further consideration by the City.

• One of the issues that was identified during the initial review of this project relates to the proposed access to the site. MNDOT has formally approved the right in/right out only access to the proposed development. The right in/right out is considered "temporary" until such time as the frontage road would be constructed and connected between Nelson


Road and County Line Road. It is anticipated that the City will continue to work with MNDOT to identify opportunities to make the aforementioned connection. This could occur at the same time as other improvements on Highway 12.

To address the current and future access issues associated with the development of this property, the City requested that the developer provide right of way for a frontage road across the property to provide for a future east/west connection to County Line Road. The applicant has provided the requisite ROW. The dedication of the frontage road right of way would preserve the ability of the City to connect Nelson Road to the planned roundabout at County Line Road and Highway 12 without having to access Highway 12. The initial development of this property would solely be accessed via a right in/right out off of Highway 12 as shown on the plans.

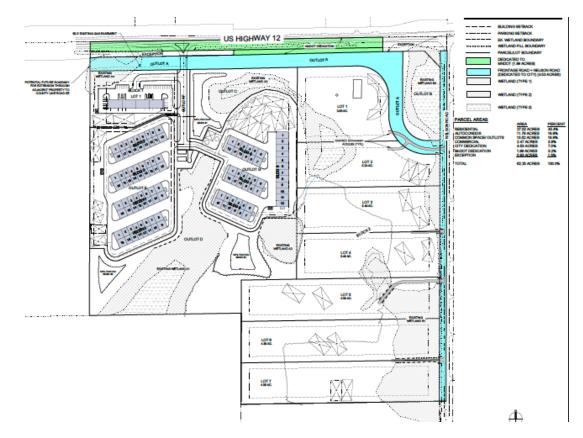

- Based on site revisions, the applicant reduced the number of residential properties to seven from eight. This reduction allows for the future frontage road right of way and eliminate the lot directly adjacent to Highway 12.
- The final plat has been prepared to address all remaining issues identified by the City during the preliminary plat review. The City has reviewed the remainder of the plat and found it to be consistent with the approved preliminary plat.


• The Comprehensive Plan has been approved by the Metropolitan Council. The property has now been guided in accordance with the preliminary approval and can be rezoned so that it is consistent with the Comprehensive Plan (see attached land use plan). The property will be rezoned in accordance with the attached map. The rezoning will change ~28 acres from AG-Agriculture to UC-Urban Commercial. Note that the previous Comprehensive Plan guided 12 acres for Urban Commercial and the new amended Comprehensive Plan guides an additional 16 acres for Urban Commercial.

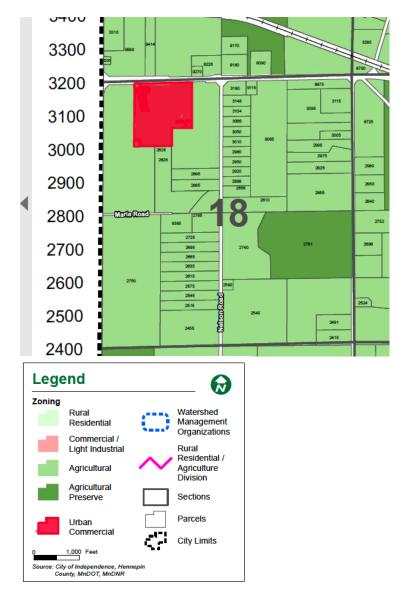

• The City noted in its initial review that the potential wetland impact associated with this development needed to be further reviewed and potentially revised to reduce total impact. There are 15.71 acres of wetlands on the property. Over the course of the past several months, the applicant has reduced the total wetland mitigation and impact from 1.24 acres to 0.90 acres of impact. The applicant has utilized shared driveways for the

residential lots as well as reduction to impacts in the commercial portion of the development to reduce impacts. The wetland impacts are still in the process of being finalized and all approvals will be subject to the applicant receiving all applicable regulatory approvals for the wetland mitigation plans.

- The applicant is proposing to provide on-site sewer (septic) and on-site water to serve the proposed development. The applicant has provided a report indicating how the development of on-site water would serve the fire suppression requirements for the proposed development. The City is continuing to evaluate and study the possibility of establishing a municipal well/water service in the location of the Urban Commercial to serve commercial development on both the north and south sides of Highway 12.
- Stormwater management has been proposed for the development. The City has completed a full review of the stormwater management plan and provided detailed comments to the applicant. One of the strategies that will be utilized by the applicant to meet stormwater requirements will be the utilization of increased wetland buffer width in lieu of additional stormwater ponding. This will eliminate some of the small stormwater ponds that were proposed to be used on the residential lots. The City will continue to work with the applicant to finalize the plans in accordance with the remaining comments.
- The applicant is proposing to preserve a large portion of the mature trees on the property (see below).

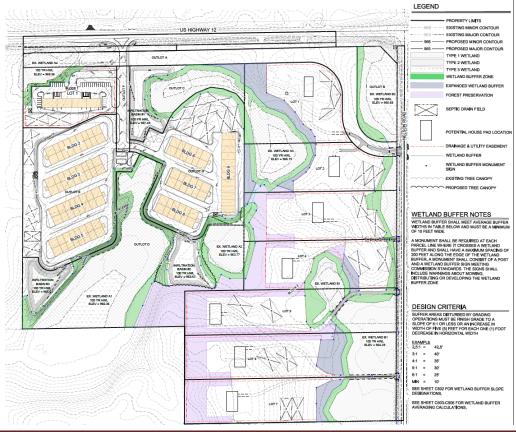

9285 Highway 12 - Rezoning and Final Plat

The City will review tree clearing for the residential lots on a case by case basis at the time of building permit review.

- It is anticipated that the development will be broken down into phases. Upon approval of the final plat, the applicant will initially sell the residential lots for development. The applicant has provided a phasing plan that shows their intended phasing of the condo development. The individual condo units will be platted in a subsequent CIC plat that will be filed with Hennepin County. The City will require all "public" improvements associated with the overall development to be constructed in the initial phase. This includes landscaping, stormwater and supporting utilities (i.e., septic and well). The City's development agreement provides the requisite security relating to the relevant improvements.
- The proposed development is subject to park dedication fees as follows: Park dedication:

\$3500 per lot to 4.99 acres + \$750 per acre over 5 acres.

Residential:	1 lot existing 6 lots	no fee \$21,000
Condos:	11.98 acres 5 acres 6.98 acres	\$3,500 \$5,235
Commercial:	2.33 acres	\$3,500
Total Park D	edication:	\$33,235

The City reviewed the final plat and requested rezoning and finds it consistent with the preliminary plat and now approved 2040 Comprehensive Plan. The applicant has provided the City with a robust package of details and information relating to the proposed development. The proposed lifestyle auto condominium illustrations appear to utilize high quality building materials and a sophisticated design that is unique for this product in the metro area.

Recommendation:

The Planning Commission recommended approval of the final plat and rezoning of a portion of the property to the City Council with the following findings and conditions:

- 1. The proposed Rezoning and Final Plat meet all applicable conditions and restrictions stated Chapter V, Section 510, Zoning, in the City of Independence Zoning Ordinance.
- 2. City Council approval of the Rezoning and Final Plat will be subject to the following:

- a. The Applicant shall make all revisions required and as noted within this report, by the Planning Commission and City Council. The revisions include but are not limited to the following:
 - i. Revise the final plat to address all applicable comments and to provide for all requisite easements.
 - ii. Revise the building plans to indicate mechanical equipment locations and if applicable, proposed screening of all equipment.
 - iii. Revise the plans to address all Fire Department comments and requirements.
- b. The Applicant shall address all comments and applicable requirements pertaining to the water resources and engineering as outlined in the respective review letters from Hakanson Anderson Associates.
- c. The Applicant shall comply with all comments and conditions required by MNDOT in accordance with their approval letter.
- d. The Applicant shall comply with all applicable regulations and conditions prescribed by Pioneer Sarah Creek Watershed Management Commission.
- e. The Applicant shall enter into a development agreement with the City for this development.
- f. The Applicant shall provide a letter of credit as established by the development agreement for all public improvements associated with this development.
- g. The Applicant shall dedicate the future frontage road right of way as depicted on the final plat.
- h. The Applicant shall provide the City with copies of the final lifestyle garage condominium covenants, including information related to the maintenance of the common private roads.
- i. The Applicant shall provide the City with a shared driveway and maintenance agreement and requisite easements for those proposed residential lots with a shared driveway condition.
- j. The Applicant shall obtain all necessary City, County, PCA and other regulatory agency approval and permits prior to construction.

- k. The Applicant shall pay the park dedication fees in accordance with the terms defined in the Development Agreement.
- 3. The Applicant shall pay for all costs associated with the City's review of the rezoning, final plat and conditional use permit.
- 4. The Applicant shall enter into a Planned Development Agreement with the City. The Planned Development Agreement will stipulate all standards associated with the planned development. A draft of the standards to be incorporated is attached.
- 5. The Applicant shall record the final plat with Hennepin County within one hundred and eighty (180) days of the City Council approval of the Final Plat.

Attachments:

- 1. ORDINANCE 2024-01
- 2. **RESOLUTION No. 2024-0220-01**
- 3. Application
- 4. Applicants Narrative
- 5. Final Plat
- 6. Site Plan Package
- 7. Building Illustrations
- 8. Development Agreement
- 9. Draft Development Standards



ORDINANCE OF THE CITY OF INDEPENDENCE HENNEPIN COUNTY, MINNESOTA

ORDINANCE NO. 2024-01

AN ORDINANCE AMENDING THE CITY OF INDEPENDENCE ZONING CODE, INCLUDING ZONING MAPS

THE CITY OF INDEPENDENCE, MINNESOTA DOES ORDAIN:

Section 1. The City of Independence Zoning Code be amended to rezone 16 acres of the property identified as (PID No. 18-118-24-21-0001) from A-Agriculture to UC-Urban Commercial and legally described as follows:

(LEGAL DESCRIPTION TO BE INSERTED)

Section 2. The City Administrator is hereby directed to amend the City of Independence Zoning Ordinance, including Zoning Maps, in accordance with the foregoing amendment.

Section 3. Effective date. This ordinance shall be and is hereby declared to be in full force and effect after its passage and publication according to law.

Adopted this 20th day of February 2024.

Marvin Johnson, Mayor

ATTEST:

Mark Kaltsas, City Administrator



RESOLUTION OF THE CITY OF INDEPENDENCE HENNEPIN COUNTY, MINNESOTA

RESOLUTION NO. 24-0220-01

RESOLUTION APPROVING A FINAL PLAT OF BRECKENRIDGE FARM AND THE DEVELOPMENT AGREEMENT AS RECOMMENDED BY THE CITY OF INDEPENDENCE PLANNING COMMISSION

WHEREAS, the City of Independence (the "City) is a municipal corporation under the laws of Minnesota; and

WHEREAS, the City adopted a comprehensive plan in 2019 to guide the development of the community; and

WHEREAS, the City has adopted a zoning ordinance and other official controls to assist in implementing the comprehensive plan; and

WHEREAS, William Stoddard (Applicant) Breck Farm, LLC (Owner) request approval of a final plat to support the development of the property located at 9285 US Hwy 12, Independence, MN (PID No. 18-118-24-21-0001) (the "Property"); and

WHEREAS, the Property is legally described on Exhibit A attached hereto; and

WHEREAS, the final plat is further depicted on Exhibit B attached hereto; and

WHEREAS, the approved building plans are depicted on Exhibit C attached hereto; and

WHEREAS, the Property is zoned AG-Agriculture and UC-Urban Commercial; and

WHEREAS, a public hearing was held on July 18th, 2023 to consider and review the applications for rezoning and final plat following mailed and published notice as required by law; and

NOW, THEREFORE, BE IT RESOLVED, by the City of Independence City Council that it should and hereby does approve the application by William Stoddard for final plat to allow the proposed development of the subject property per the City's zoning and subdivision regulations with the following findings and conditions:

1. The proposed Rezoning and Final Plat meet all applicable conditions and restrictions stated Chapter V, Section 510, Zoning, in the City of Independence Zoning Ordinance.

- 2. City Council approval of the Rezoning and Final Plat will be subject to the following:
 - a. The Applicant shall make all revisions required and as noted within this report, by the Planning Commission and City Council. The revisions include but are not limited to the following:
 - i. Revise the final plat to address all applicable comments and to provide for all requisite easements.
 - ii. Revise the building plans to indicate mechanical equipment locations and if applicable, proposed screening of all equipment.
 - iii. Revise the plans to address all Fire Department comments and requirements.
 - b. The Applicant shall address all comments and applicable requirements pertaining to the water resources and engineering as outlined in the respective review letters from Hakanson Anderson Associates.
 - c. The Applicant shall comply with all comments and conditions required by MNDOT in accordance with their approval letter.
 - d. The Applicant shall comply with all applicable regulations and conditions prescribed by Pioneer Sarah Creek Watershed Management Commission.
 - e. The Applicant shall enter into a development agreement with the City for this development.
 - f. The Applicant shall provide a letter of credit as established by the development agreement for all public improvements associated with this development.
 - g. The Applicant shall dedicate the future frontage road right of way as depicted on the final plat.
 - h. The Applicant shall provide the City with copies of the final lifestyle garage condominium covenants, including information related to the maintenance of the common private roads.
 - i. The Applicant shall provide the City with a shared driveway and maintenance agreement and requisite easements for those proposed residential lots with a shared driveway condition.
 - j. The Applicant shall obtain all necessary City, County, PCA and other regulatory agency approval and permits prior to construction.
 - k. The Applicant shall pay the park dedication fees in accordance with the terms defined in the Development Agreement.

- 3. The Applicant shall pay for all costs associated with the City's review of the rezoning, final plat and conditional use permit.
- 4. The City has approved the proposed architectural plans for the lifestyle garage condominiums and commercial development. The approved plans are attached as **Exhibit C**. Any changes or modifications to the approved plans shall require an amendment to the site plan approval.
- 5. The Applicant shall enter into a Planned Development Agreement with the City. The Planned Development Agreement will stipulate all standards associated with the planned development. A draft of the standards to be incorporated is attached.
- 6. The Applicant shall record the final plat with Hennepin County within one hundred and eighty (180) days of the City Council approval of the Final Plat.

This resolution was adopted by the City Council of the City of Independence on this 20th of February 2024, by a vote of _____ayes and _____nays.

ATTEST:

Marvin Johnson, Mayor

Mark Kaltsas, City Administrator

EXHIBIT A

(Legal Description)

EXHIBIT B (Site Plan Final Plat)

EXHIBIT C (Building and Architectural Plans)

PLANNED DEVELOPMENT STANDARDS

- (A)*Permitted uses.* Permitted uses of land or buildings, as hereinafter listed, shall be permitted in the Planned Development under the conditions specified. No building or lot shall be devoted to any use other than a use permitted hereunder:
 - (1) Any use not expressly permitted but consistent with the intent of the district which, by approval of the city council, shall be permitted except for eating and drinking establishments, coffee shops and similar food service businesses which shall not be permitted until such time as a frontage road is constructed which provides a public access from the proposed retail development to County Line Road.
 - (2) Office and retail sales.
 - (3) Contractor and construction supply shops conducted wholly within an enclosed building, including but not limited to plumbing, HVAC, roofing and electrical with a principle building or office with no outdoor storage.
 - (4) Light manufacturing, production, processing, assembly, fabricating, servicing and repairing of materials, goods or products with no outdoor storage.
 - (5) Auto Condos in accordance with the following provisions:
 - i. Auto Condos shall be for the private storage and private leisure by the owner(s) of such space. No commercial activities or businesses shall be permitted in the auto condos, nor shall any auto condo be ever occupied for residential purposes and the following additional conditions shall apply:
 - a) Individual signs shall not be permitted for any units within the development.
 - b) No outdoor storage will be permitted.
 - c) Parking shall be permitted only in the designated parking spaces.
- (B) Accessory uses. None.
- (C) *Conditional uses.* The following conditional uses may be permitted by action of the city council pursuant to subsections <u>520.09</u>, <u>520.11</u> and <u>520.13</u>:
 - (1) Telecommunications towers approved pursuant to section 540 of this Code;
 - (2) Any other use determined by the city council to be similar in character to a permitted use, but potentially requiring special conditions to ensure compatibility.

(D) Physical standards.

(1) Minimum Lot Size:	per approved general plan
(2) Minimum Lot Width:	per approved general plan
(3) Front Yard:	50 feet
(4) Side Yard:	20 feet
(5) Corner Side Yard:	20 feet
(6) Rear Yard:	30 feet
(7) Residential Properties:	40 feet
(8) Agriculture Properties:	40 feet
(9) Parking and Drive Aisle:	
a. Front Yard:	15 feet

b.	Side Yard:	5 feet

c. Rear Yard: 5 feet

KNOW ALL PERSONS BY THESE PRESENTS: That Breck Farm, LLC, a Minnesota limited liability company, owner of the following described property:

The Northeast Quarter of the Northwest Quarter: and also the East 25 rods of the Northwest Quarter of the Northwest Quarter; and also the North 1/3 of the East 60 rods of the Southeast Quarter of the Northwest Quarter, all in Section 18, Township 118, of Range 24, Hennepin County, Minnesota; EXCEPT

Parcel 369, Minnesota Department of Transportation Right of Way Plat No. 27-77, Hennepin County, Minnesota;

ALSO EXCEPT That part of Tract A described below; Tract A

That part of the Northeast Quarter of the Northwest Quarter of Section 18, Township 118 North, Range 24 West, lying southerly of the southerly right of way line of Trunk Highway No. 12 as now located and established. Which lies northerly of a line run parallel with and distant 70 feet southerly of Line 1 described below; Line 1 From the northwest corner of said Section 18, run easterly on the north line of said Section 18 for 2062.1 feet to the point of beginning of Line 1 to be described; thence continue easterly on the last described course for 400 feet and there terminating. Together with that part of Tract A hereinbefore described adjoining and southerly of the above described strip and westerly of the westerly boundary of the public road running along the east line of Tract A hereinbefore described which lies northeasterly of the following described line: Beginning at a point on said westerly boundary, distant 100 feet southerly of its intersection with a line run parallel with and distant 50 feet southerly of the north line of said Section 18; thence run northwesterly to a point distant 70 feet southerly (measured at right angles) of a point on Line 1 described above distant 200 feet easterly of its point of beginning and there terminating.

Abstract Property.

Have caused the same to be surveyed and platted as BRECKENRIDGE FARM and do hereby dedicate to the public for public use the easements for drainage and utility purposes as created by this plat.

In witness whereof said Breck Farm, LLC, a Minnesota limited liability company, has caused the presents to be signed by its proper offer this _____ day of

Signed: Breck Farm, LLC

_____, its President

STATE OF _____

COUNTY OF _____ This instrument was acknowledged before me this _____ day of _____ , 20__ , by ______. President of Breck Farm, LLC, a Minnesota limited liability company.

Signature			
Signature			

Printed

Notary Public, _____ County, Minnesota My Commission Expires: _____

SURVEYORS CERTIFICATE

I, Nicholas Hillmer, do hereby certify that this plat was prepared by me or under my direct supervision; that I am a duly Licensed Land Surveyor in the State of Minnesota; that this plat is a correct representation of the boundary survey; that all mathematical data and labels are correctly designated on this plat; that all monuments depicted on this plat have been, or will be correctly set within one year; that all water boundaries and wet lands, as defined in Minnesota Statutes, Section 505.01, Subd. 3, as of the date of this certificate are shown and labeled on this plat; and all public ways are shown and labeled on this plat.

Dated this_____ day of_____, 20____.

Nicholas Hillmer, Licensed Land Surveyor Minnesota License No. 45774

STATE OF MINNESOTA COUNTY OF _____

This instrument was acknowledged before me this _____ day of ______ , 20___ , by Nicholas Hillmer.

	(Notary Signature)
	(Notary Printed Name)
Notary Public,	County, Minnesota.
My Commission Expires	

DRAINAGE AND UTILITY EASEMENTS ARE SHOWN THUS:

NO SCALE BEING 10 FEET IN WIDTH AND ADJOINING RIGHT-OF-WAY LINES AND 10 FEET IN WIDTH AND ADJOINING LOT LINES UNLESS OTHERWISE SHOWN ON THIS PLAT.

BRECKENRIDGE FARM

CITY COUNCIL, CITY OF INDEPENDENCE, MINNESOTA This plat of BRECKENRIDGE FARM was approved and accepted by the City _____ day of ______, 20___, and said plat is in complic CITY COUNCIL, CIT by: _____, Mayor RESIDENT AND REAL ESTATE SERVICES, Hennepin County, Minnesota I hereby certify that taxes payable in _____ and prior years have been Mark V. Chapin, Hennepin County Auditor by: _____ SURVEY DIVISION Hennepin County, Minnesota Pursuant to MN. STAT. Sec. 383B.565 (1969), this plat has been approved Chris F. Mavis, Hennepin County Surveyor by: _____ COUNTY RECORDER, Hennepin County, Minnesota. I hereby certify that the within plat of BRECKENRIDGE FARM was recorded


Amber Bougie, County Recorder

by: _____


O O DENOTES 1/2 INCH BY 14 INCH IRON PIPE MONUMENT SET AND MARKED BY LICENSE NO. 45774


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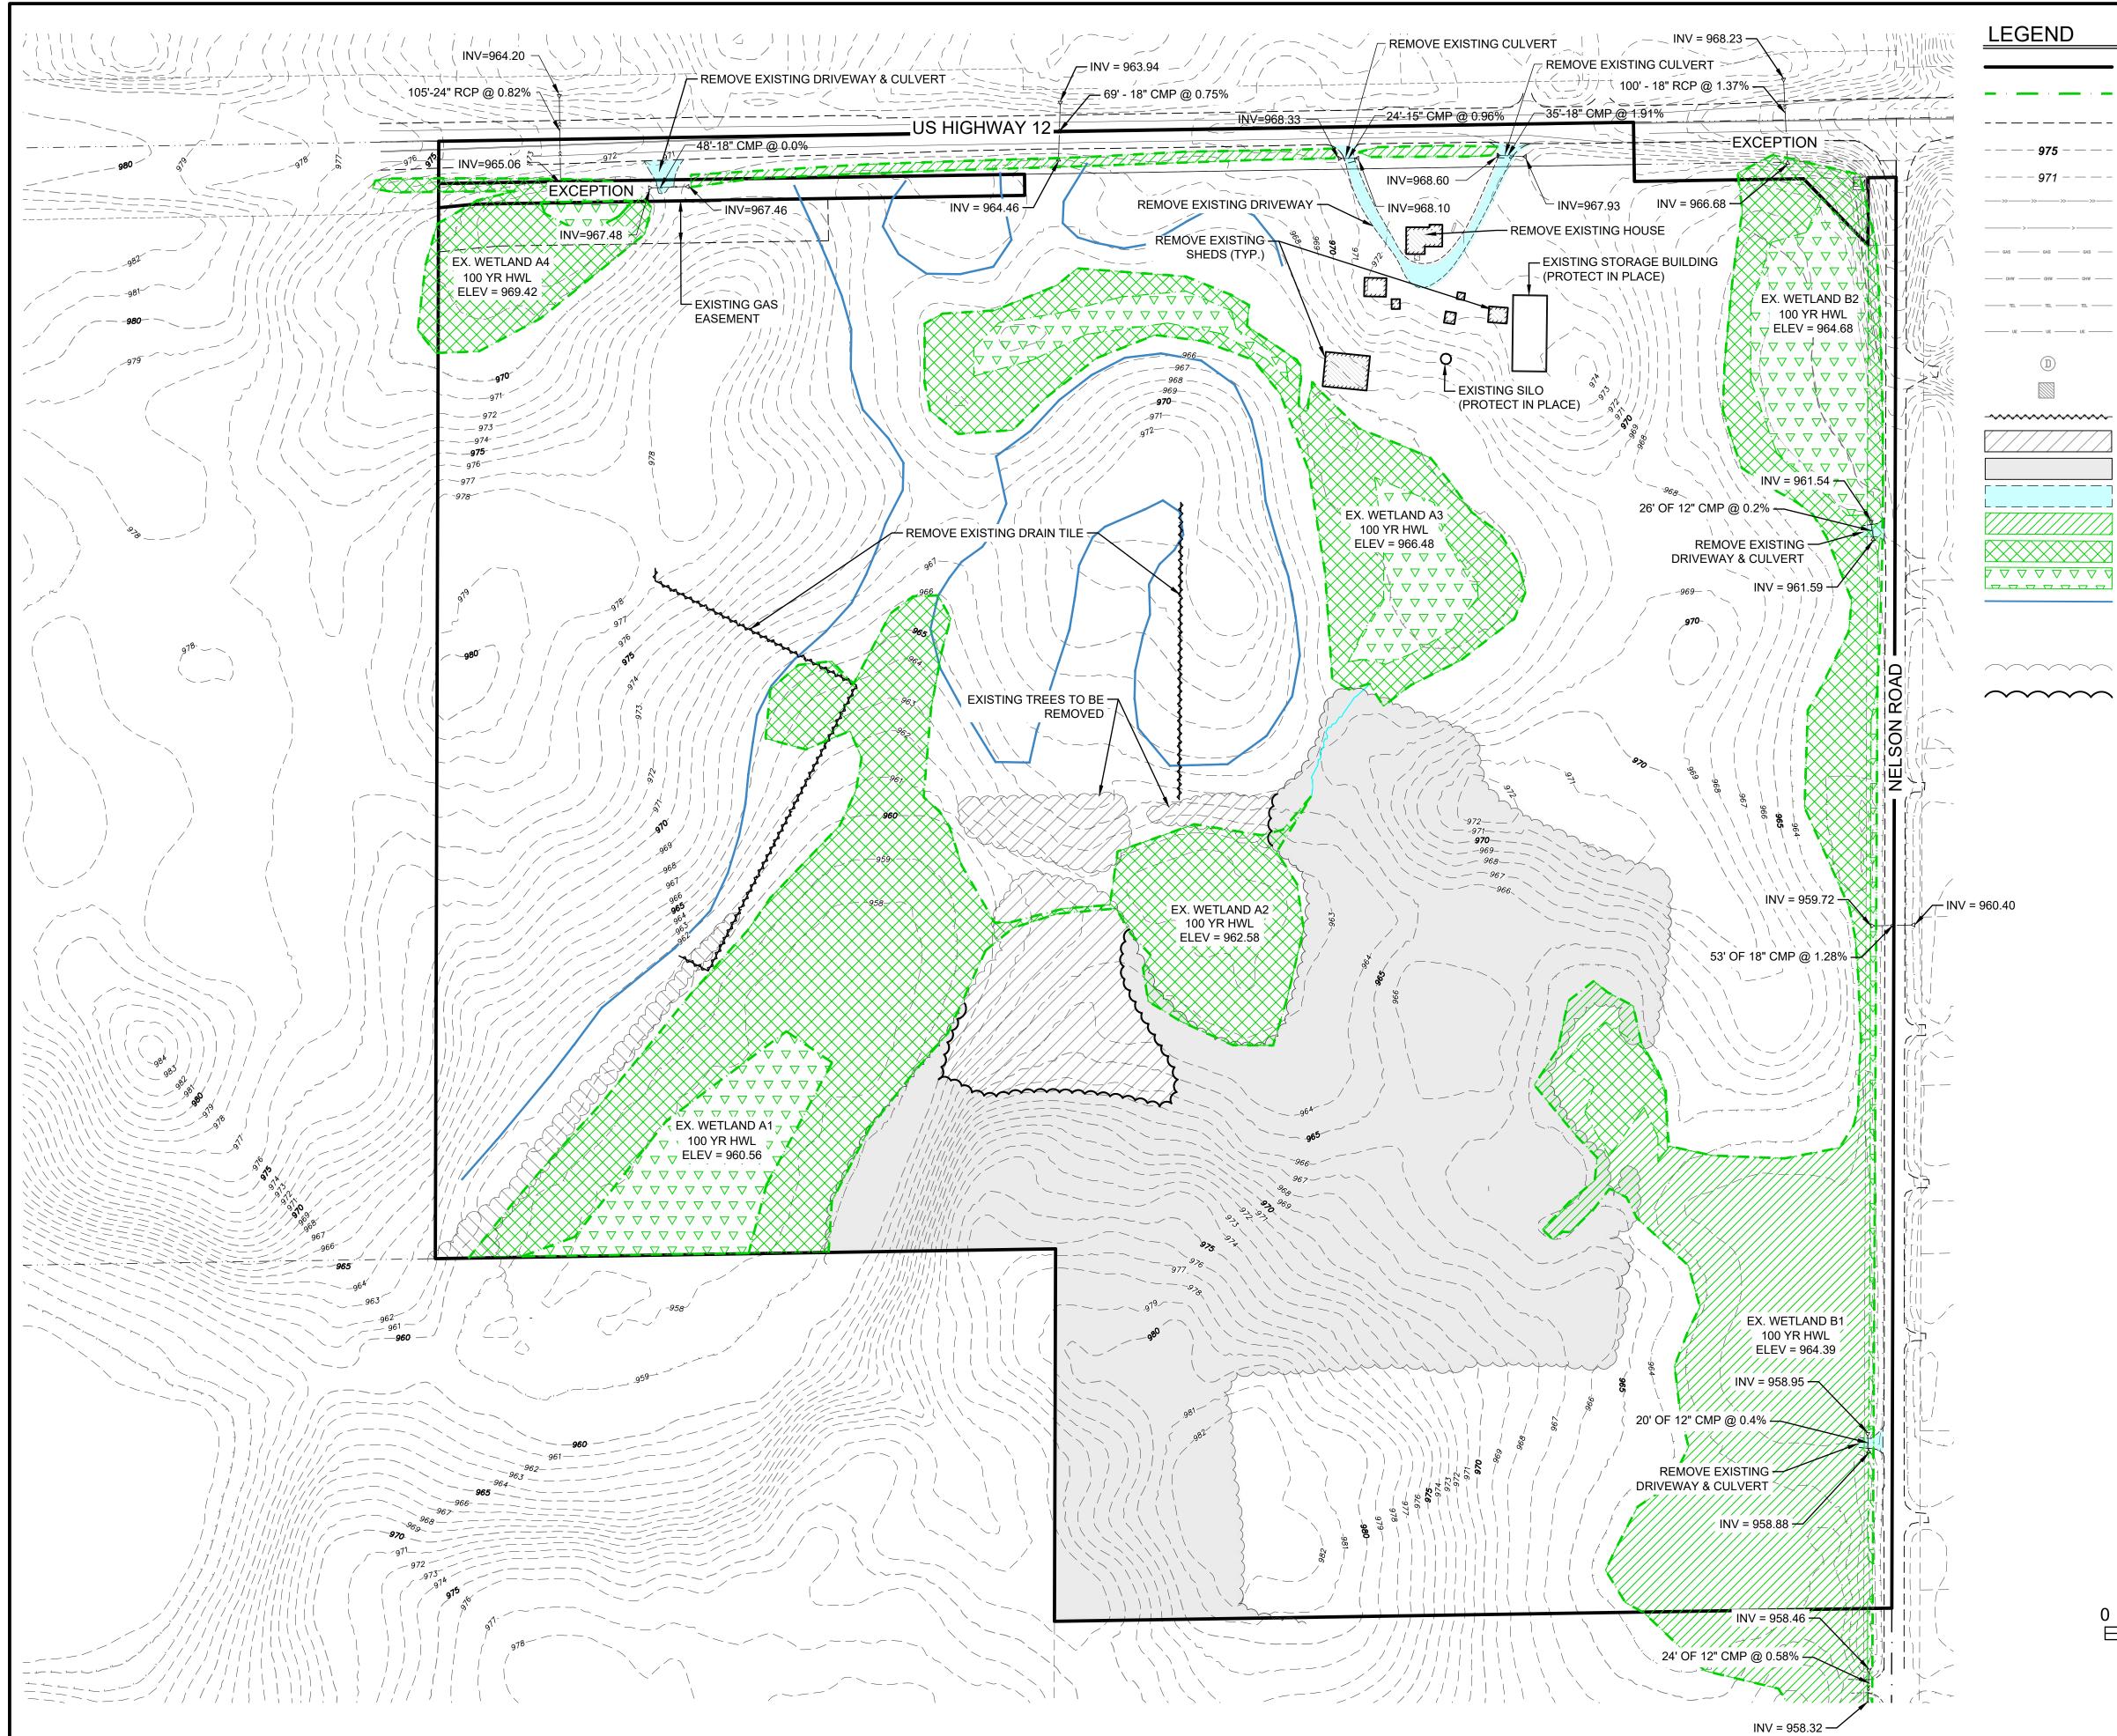
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this office this day of	, 20 at o'clocl	k m.
, Deputy		



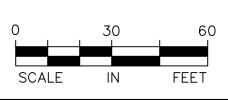



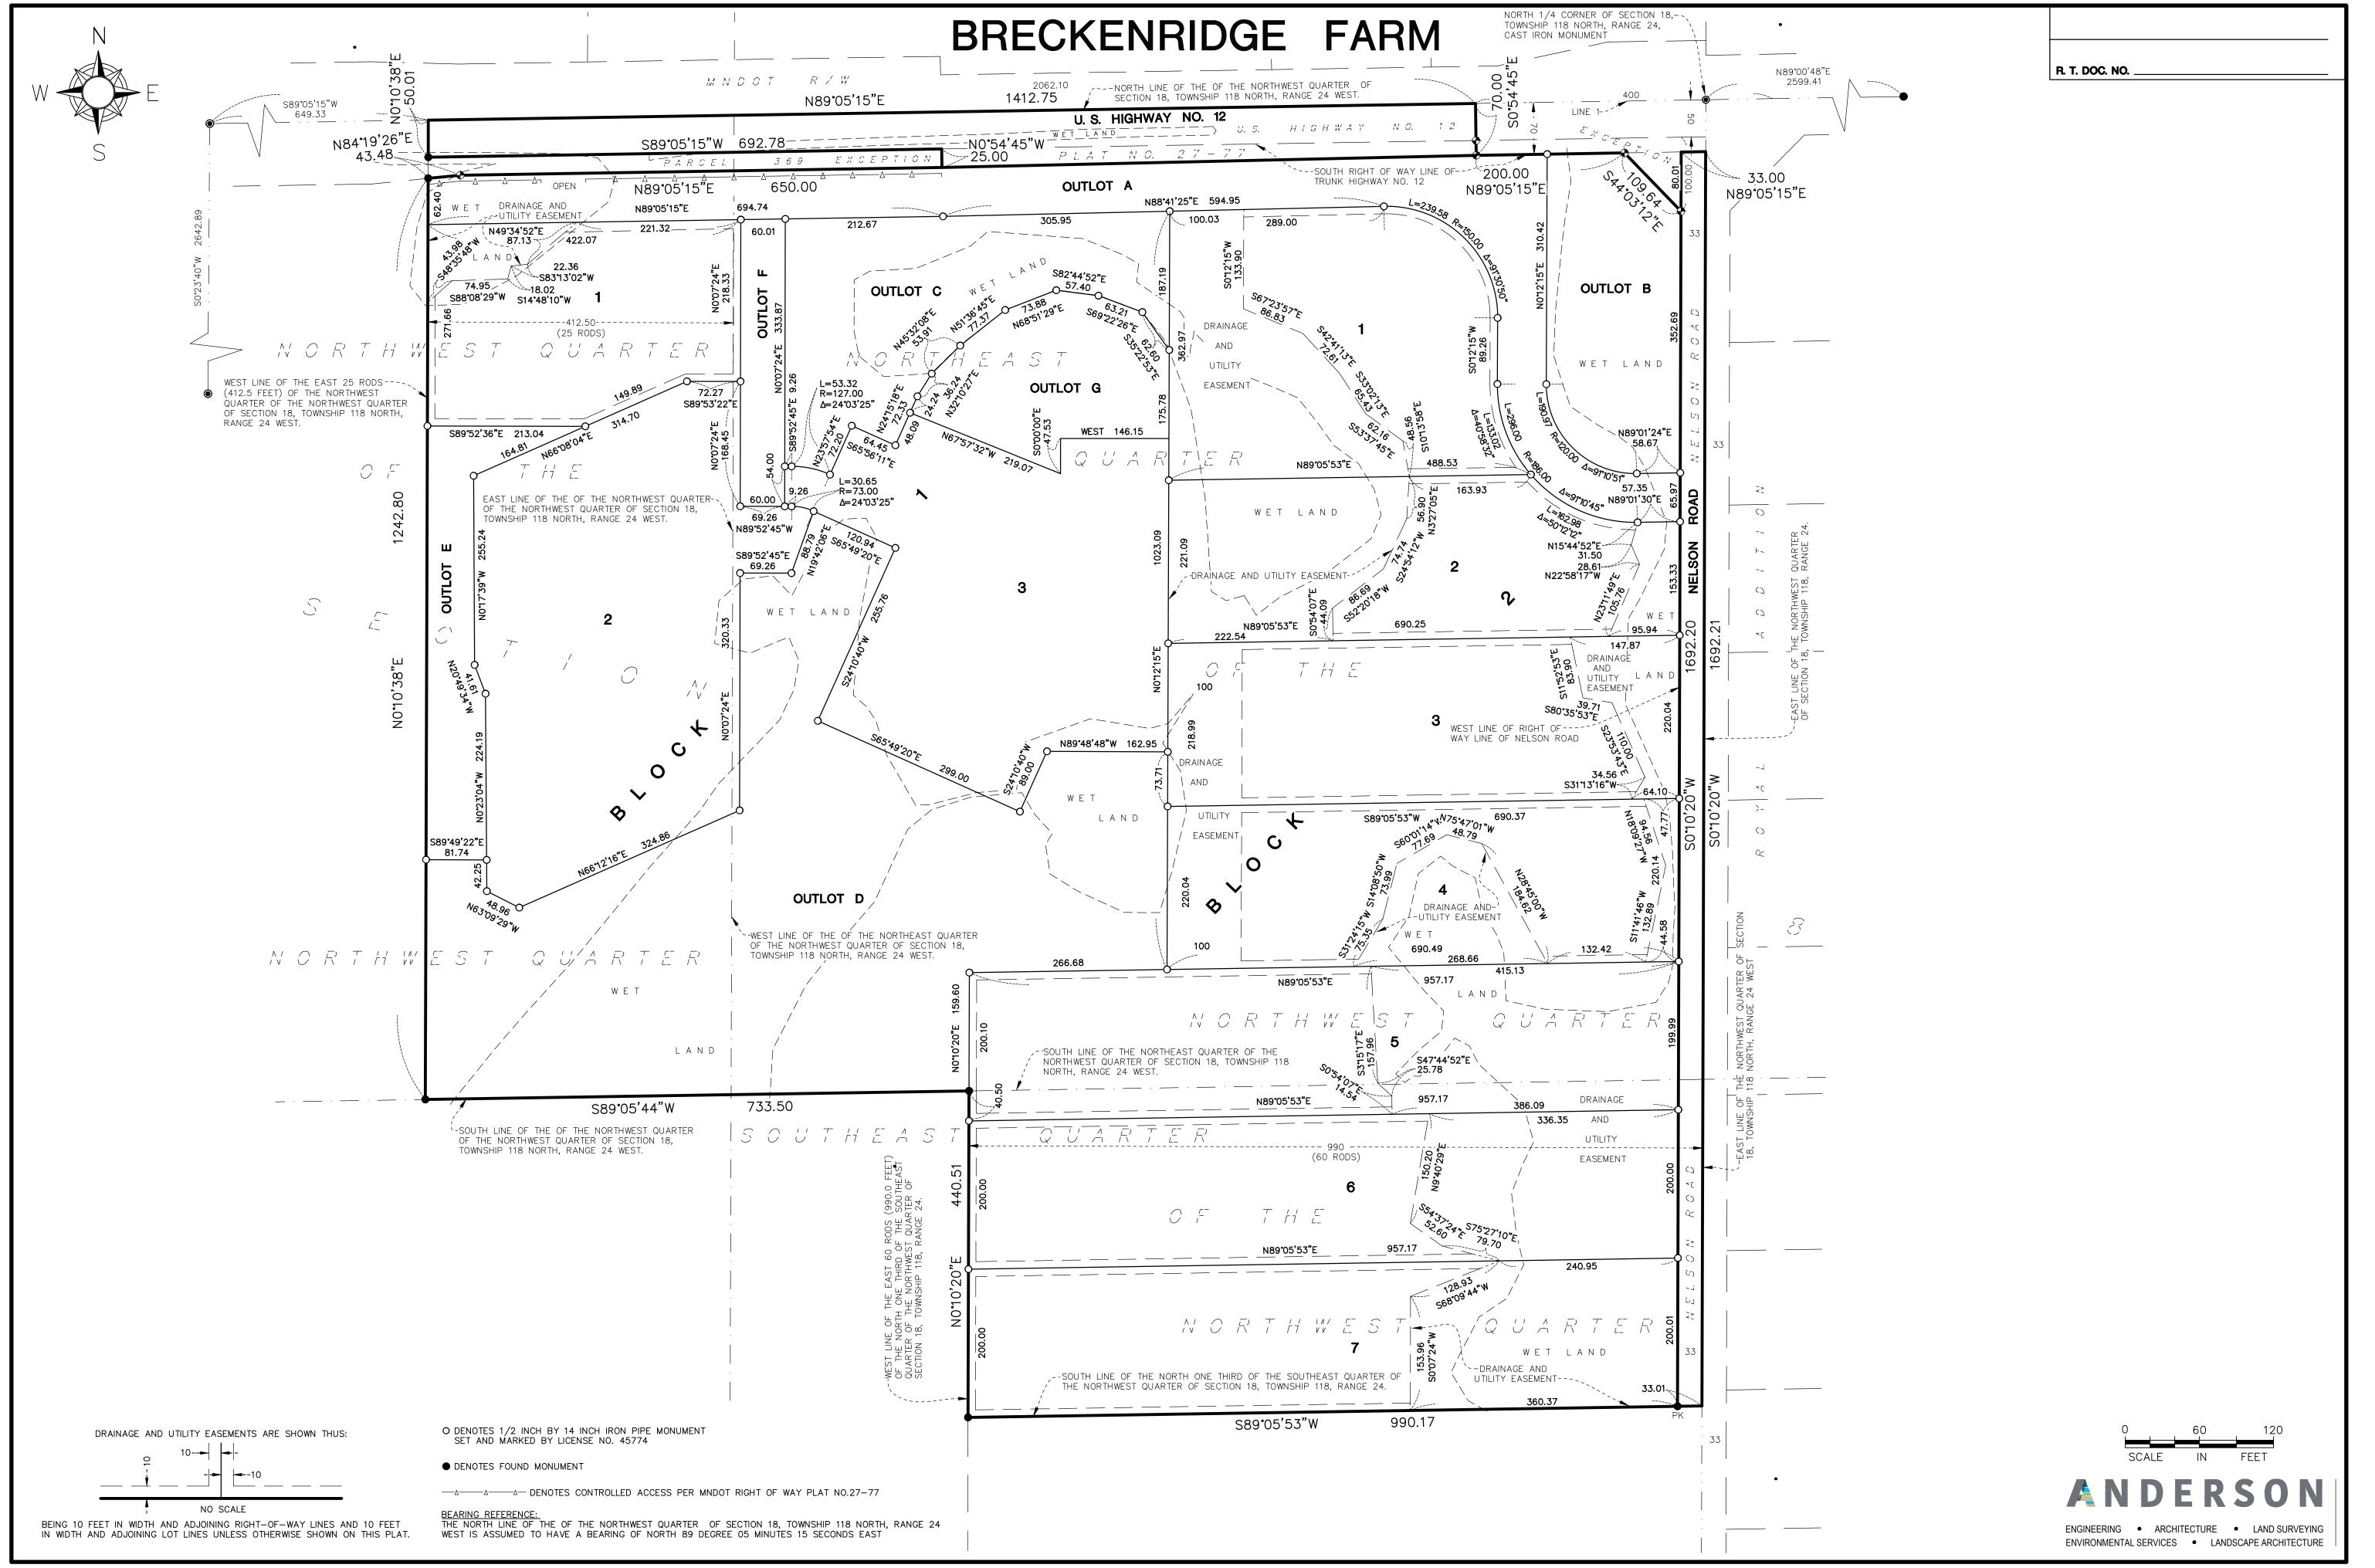


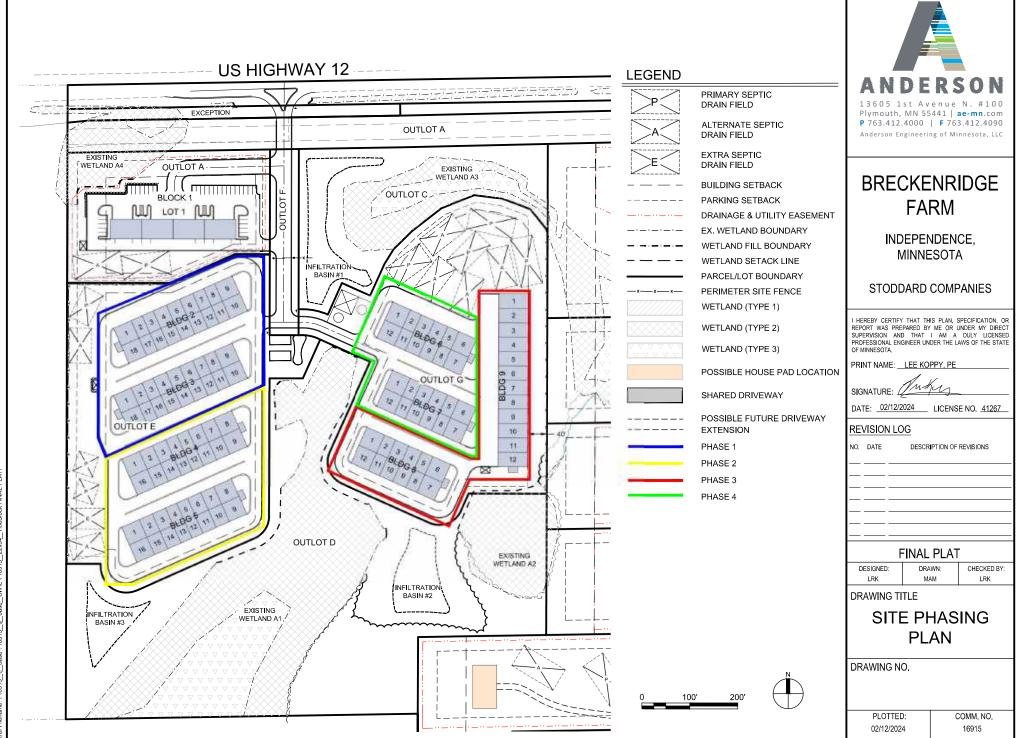

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PROPERTY LIMITS EXISTING WETLAND EXISTING EASEMENT EXISTING MAJOR CONTOUR **EXISTING MINOR CONTOUR** EXISTING STORM SEWER EXISTING DRAINTILE EXISTING GAS MAIN EXISTING OVERHEAD WIRES **EXISTING TELEPHONE** EXISTING UNDERGROUND ELECTRIC **EXISTING STORM SEWER INLET** REMOVE EXISTING BUILDING REMOVE EXISTING UTILITY LINE **REMOVE EXISTING TREES** EXISTING TREE CANOPY TO REMAIN REMOVE EXISTING DRIVEWAY TYPE 1 WETLAND TYPE 2 WETLAND TYPE 3 WETLAND UPLAND (AS FIELD DESIGNATED BY CERTIFIED SEPTIC DESIGNER DALE DENN - SEE REPORT) EXISTING TREE CANOPY PROPOSED TREE CANOPY



I HEREBY CERTIFY THAT THIS PLAN, SPECIFICATION, O REPORT WAS PREPARED BY ME OR UNDER MY DIRECT SUPERVISION AND THAT I AM A DULY LICENSED PROFESSIONAL ENGINEER UNDER THE LAWS OF THE STATE OF MINNESOTA.

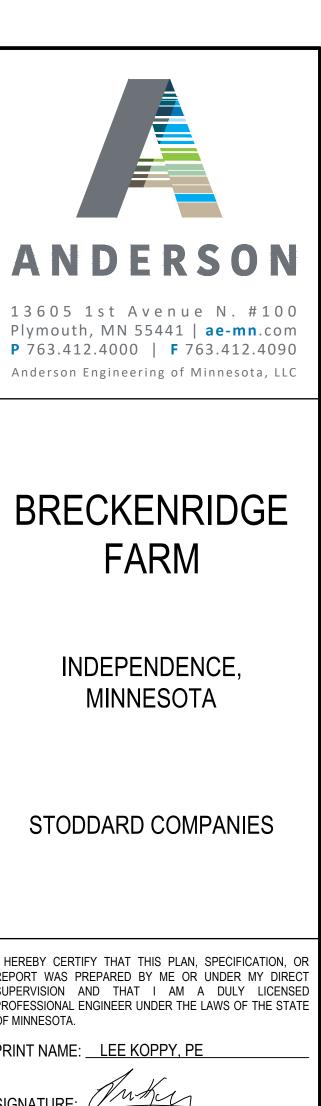RINT	NAME:	LEE	KOPPY	, PE

SIGNATURE:

REVISION LOG

DESCRIPTION OF REVISIONS NO. DATE

FINAL PLAT


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EXISTING CONDITIONS & REMOVALS PLAN			

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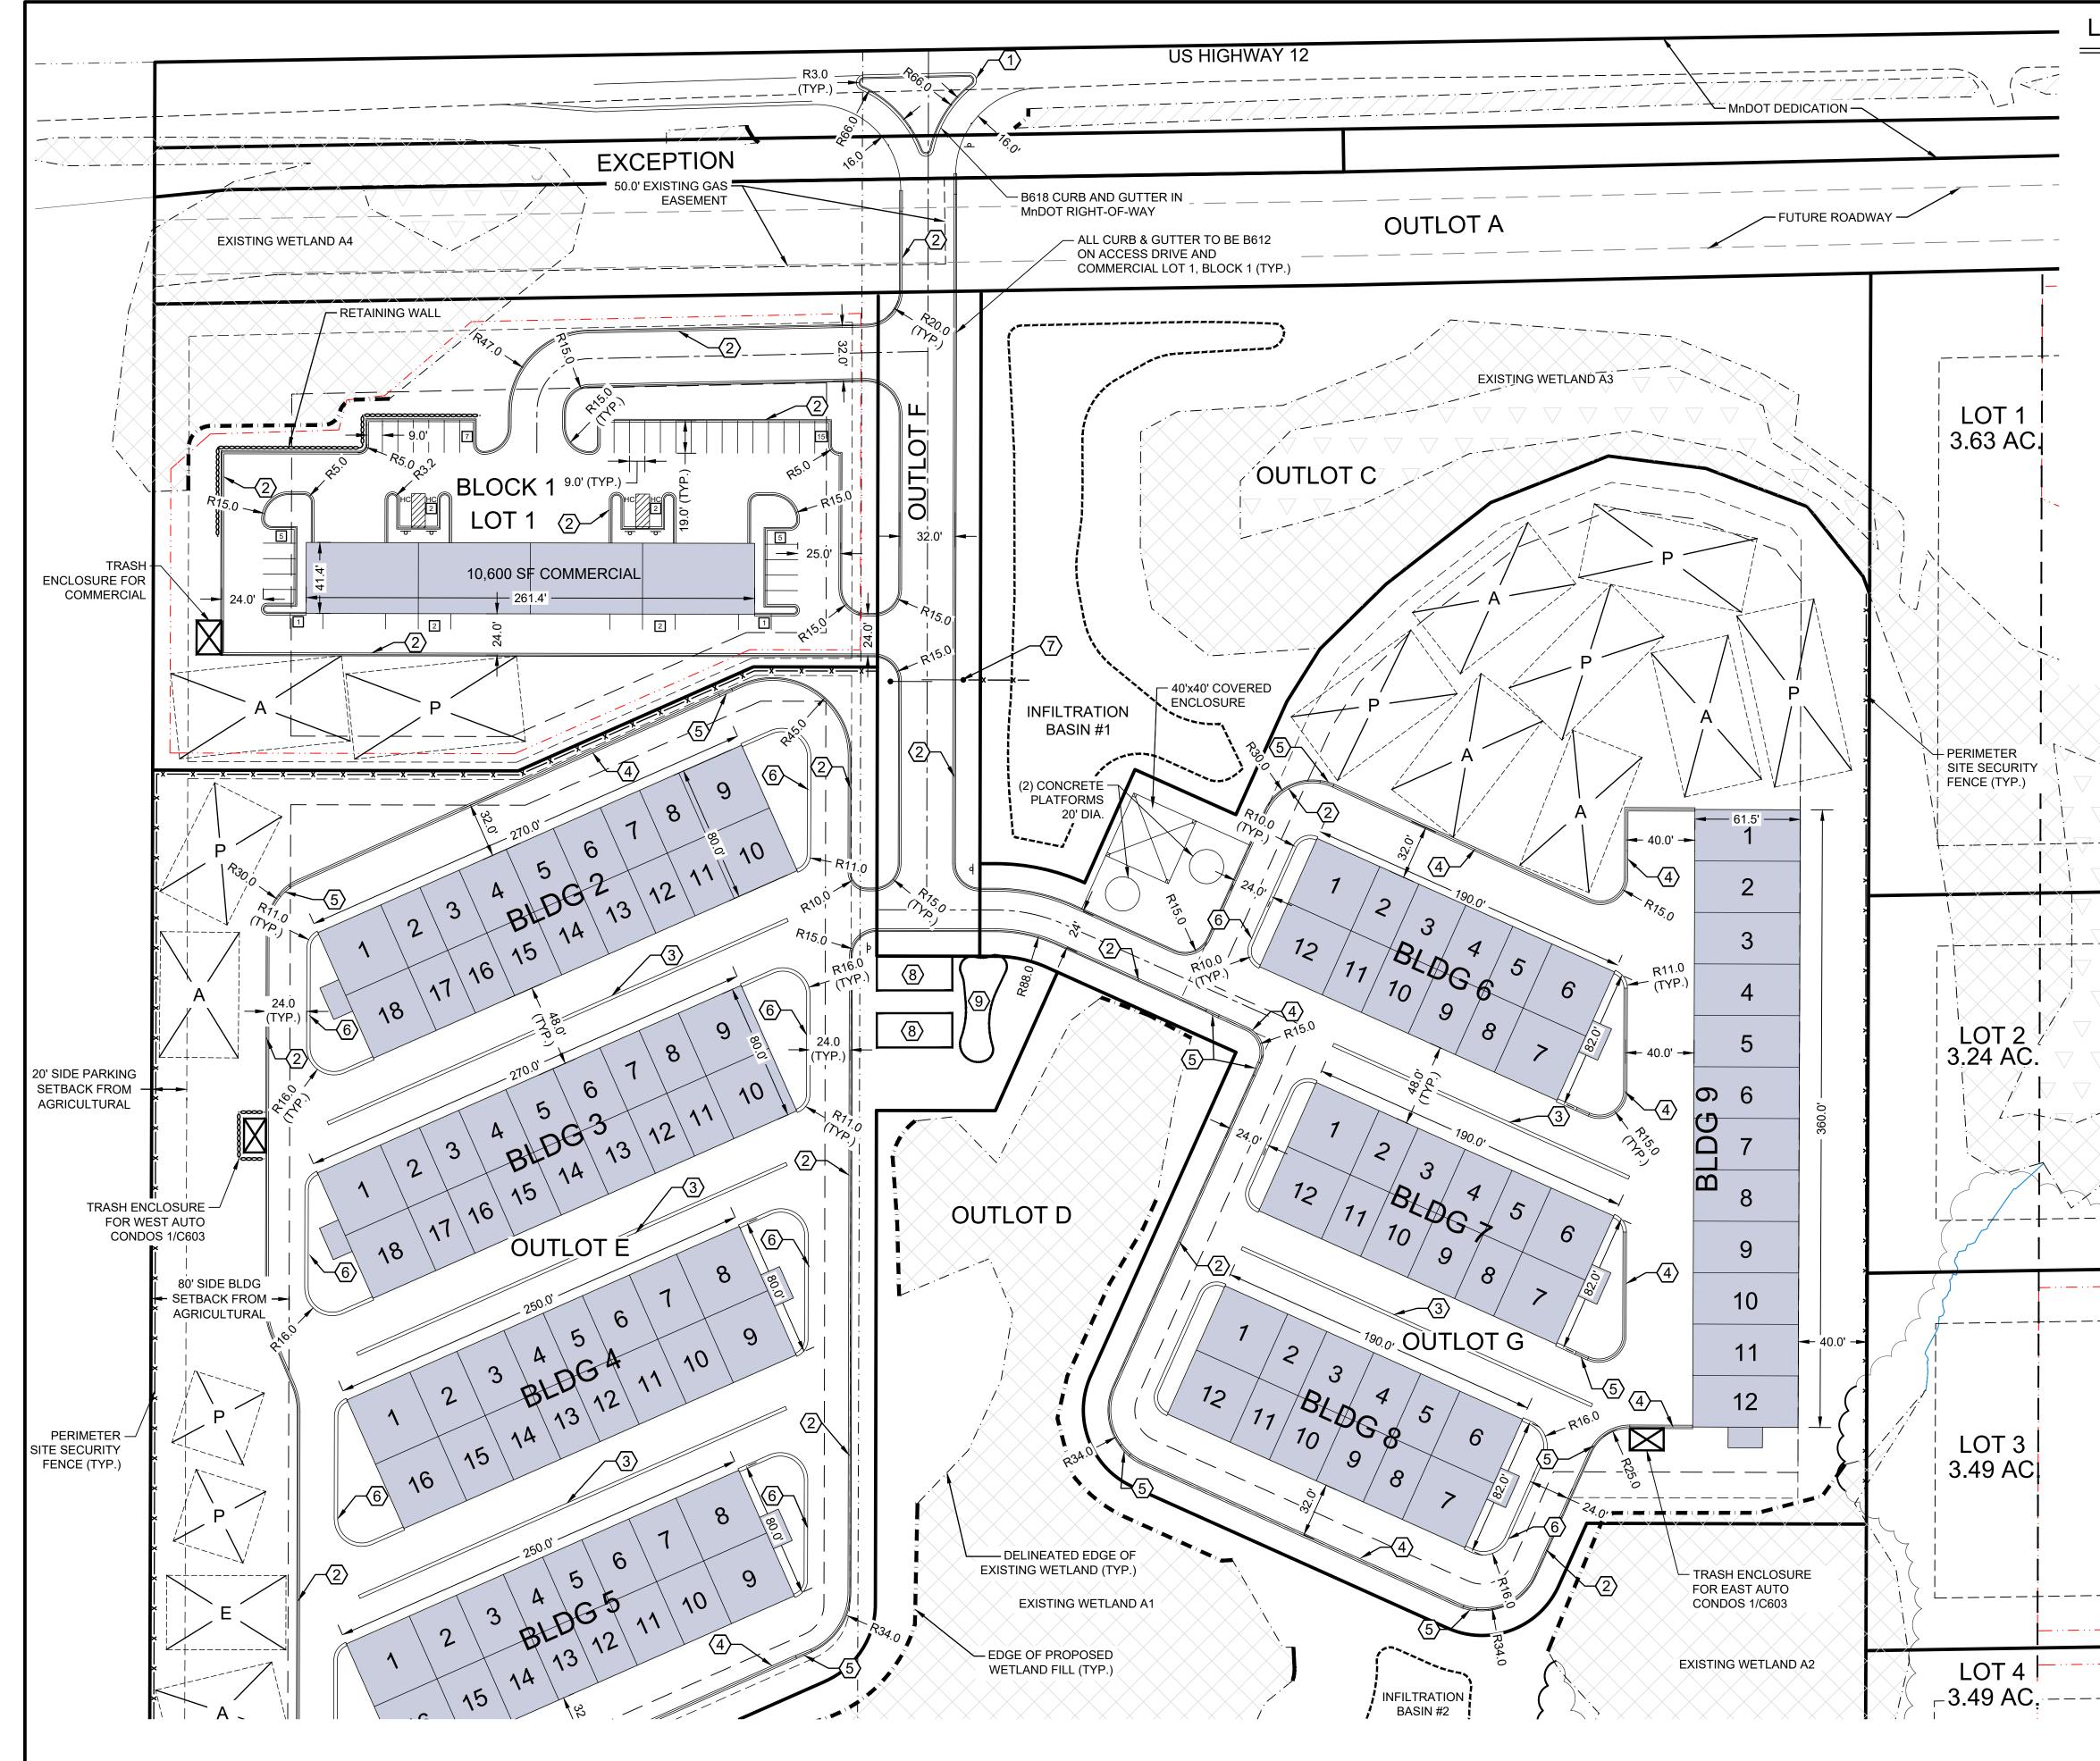
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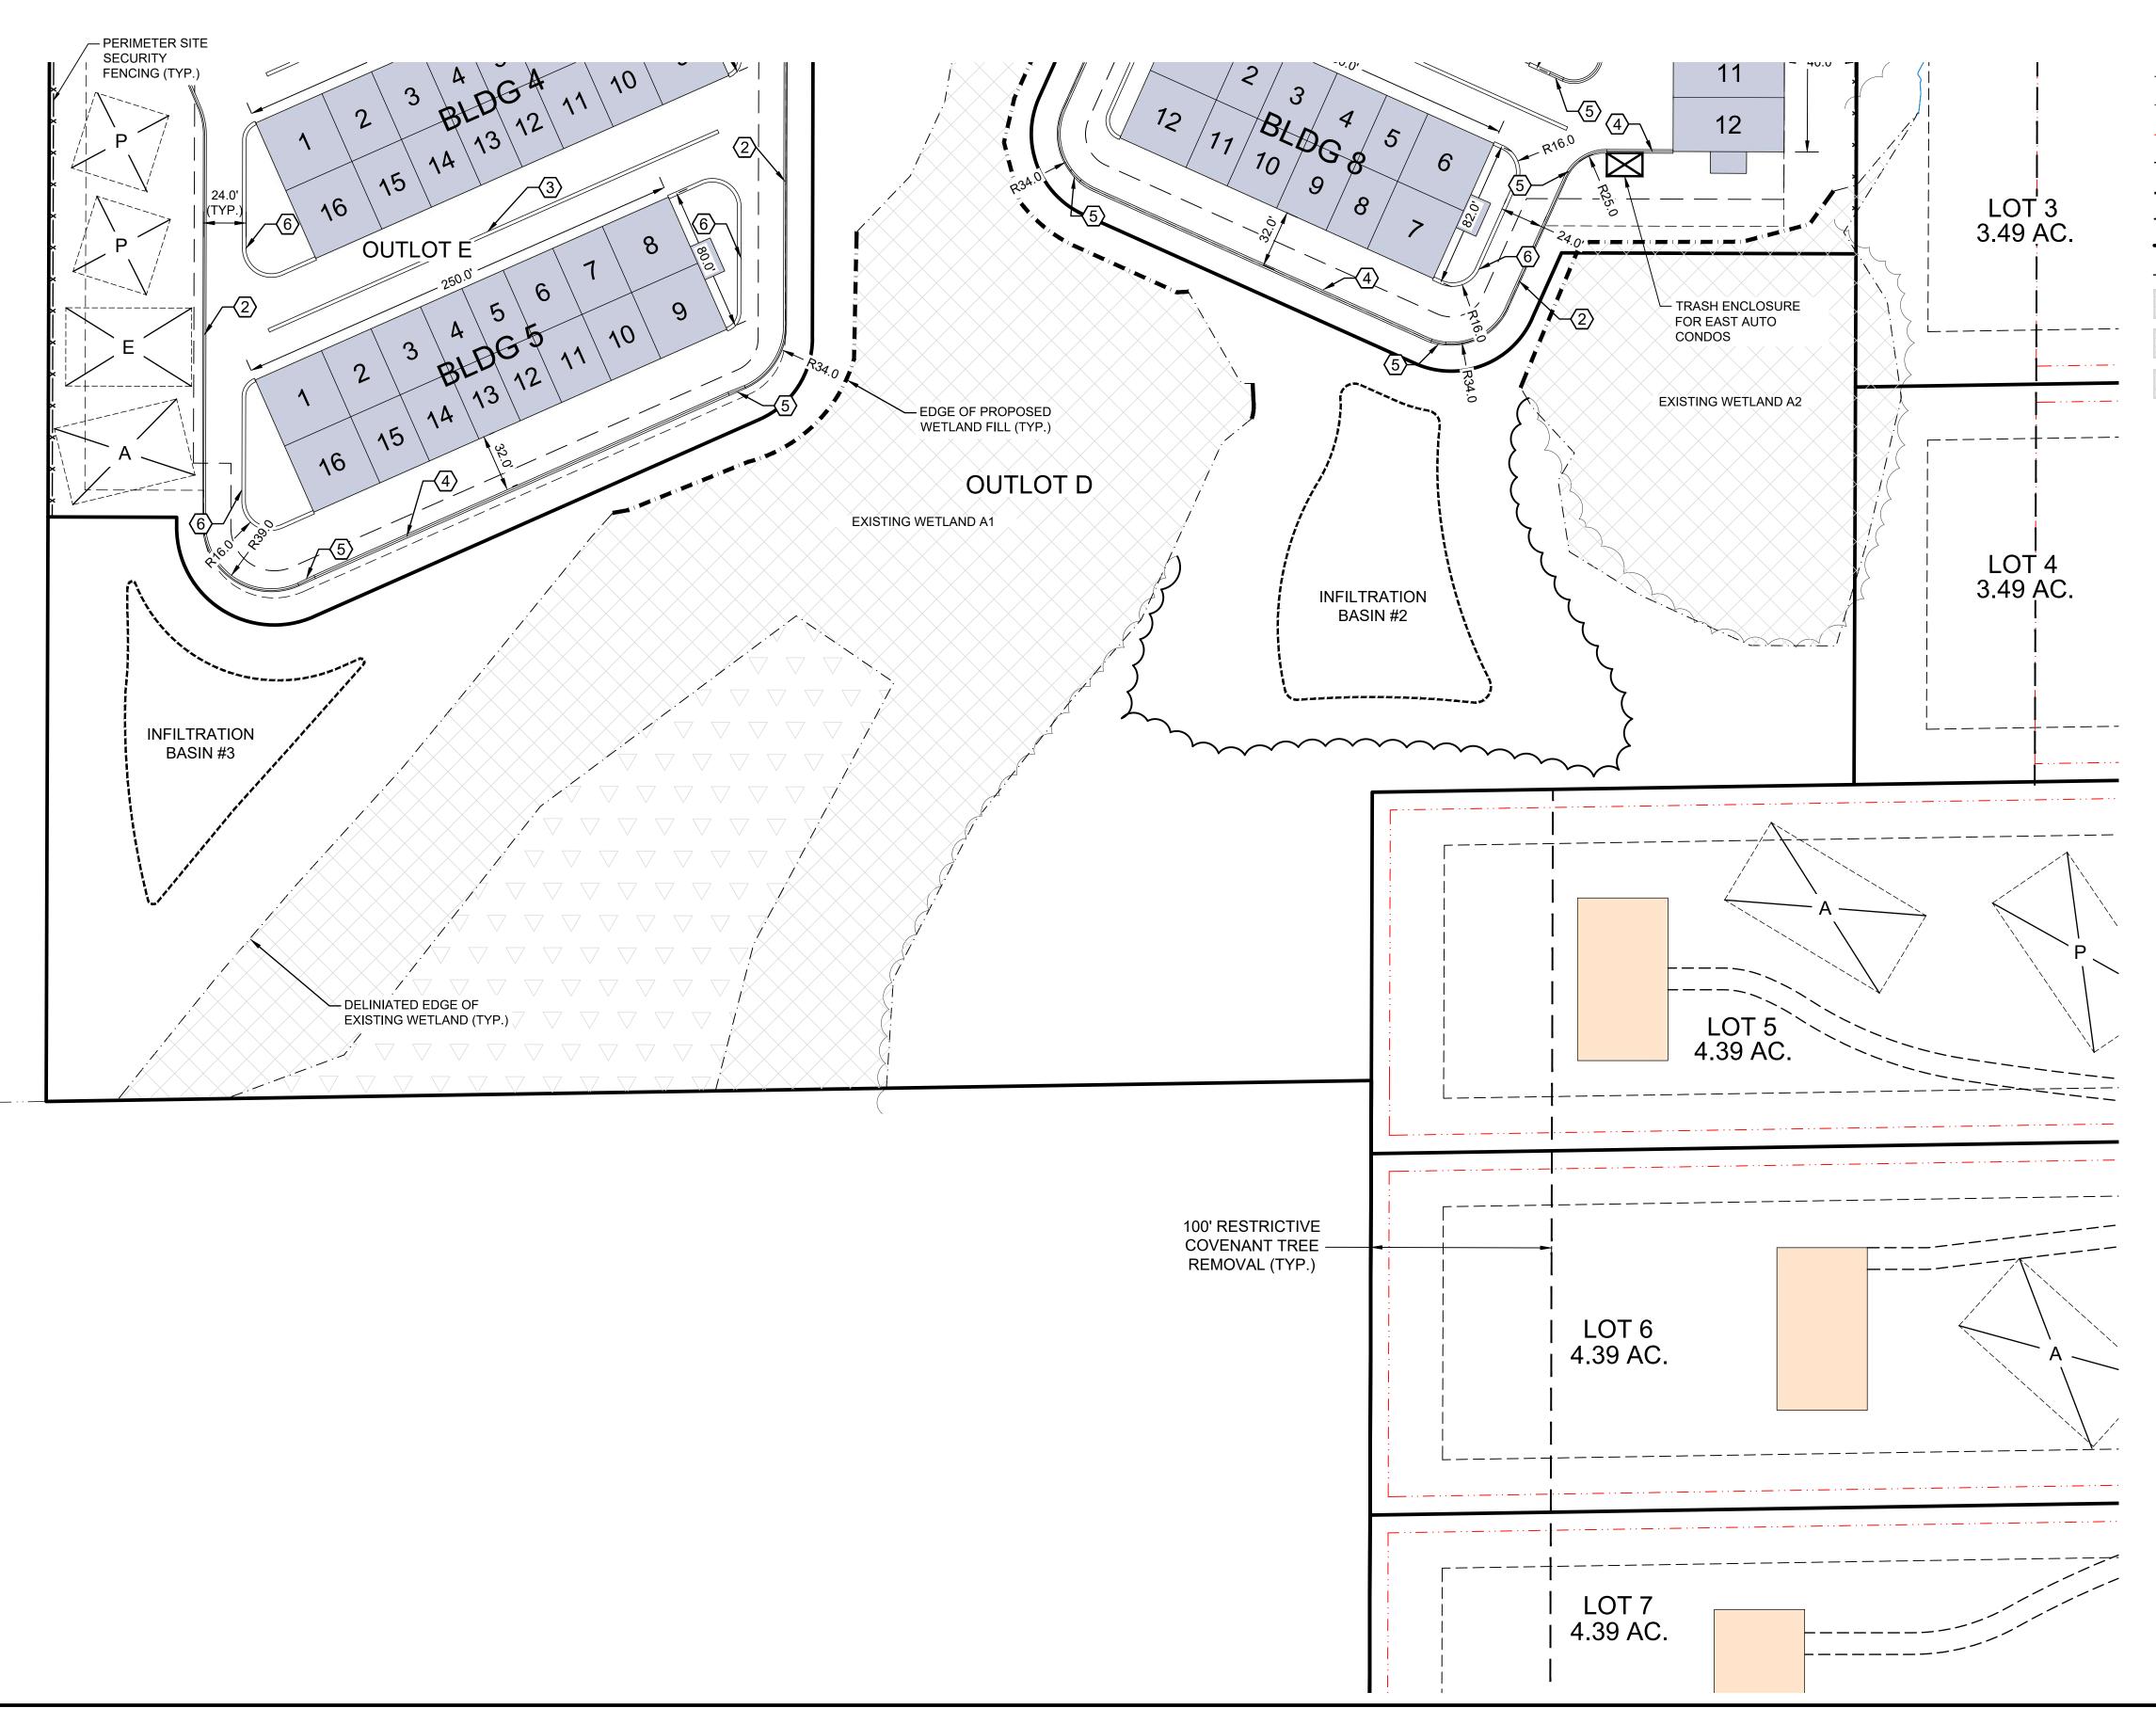


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· · · · ·	WETLAND FI	LL BOUNDARY		
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	8, 9, 16	20,000 SF EACH 1,600 SF 4, 15 1,200 SF 1,000 SF	REPORT WAS PREPARED I SUPERVISION AND THAT	THIS PLAN, SPECIFICATION, OR 3Y ME OR UNDER MY DIRECT I AM A DULY LICENSED INDER THE LAWS OF THE STATE
BUILDINGS 6, 7 LOT 1, 6,	7, 12	15,568 SF EACH 1,639 SF	OF MINNESOTA.	
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	-	1,844 SF	REVISION LOG	
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*OUTLOT C		2.37 ACRES		
*OUTLOT D OUTLOT E		8.97 ACRES 6.10 ACRES		
*OUTLOT F OUTLOT G		0.53 ACRES 5.69 ACRES		
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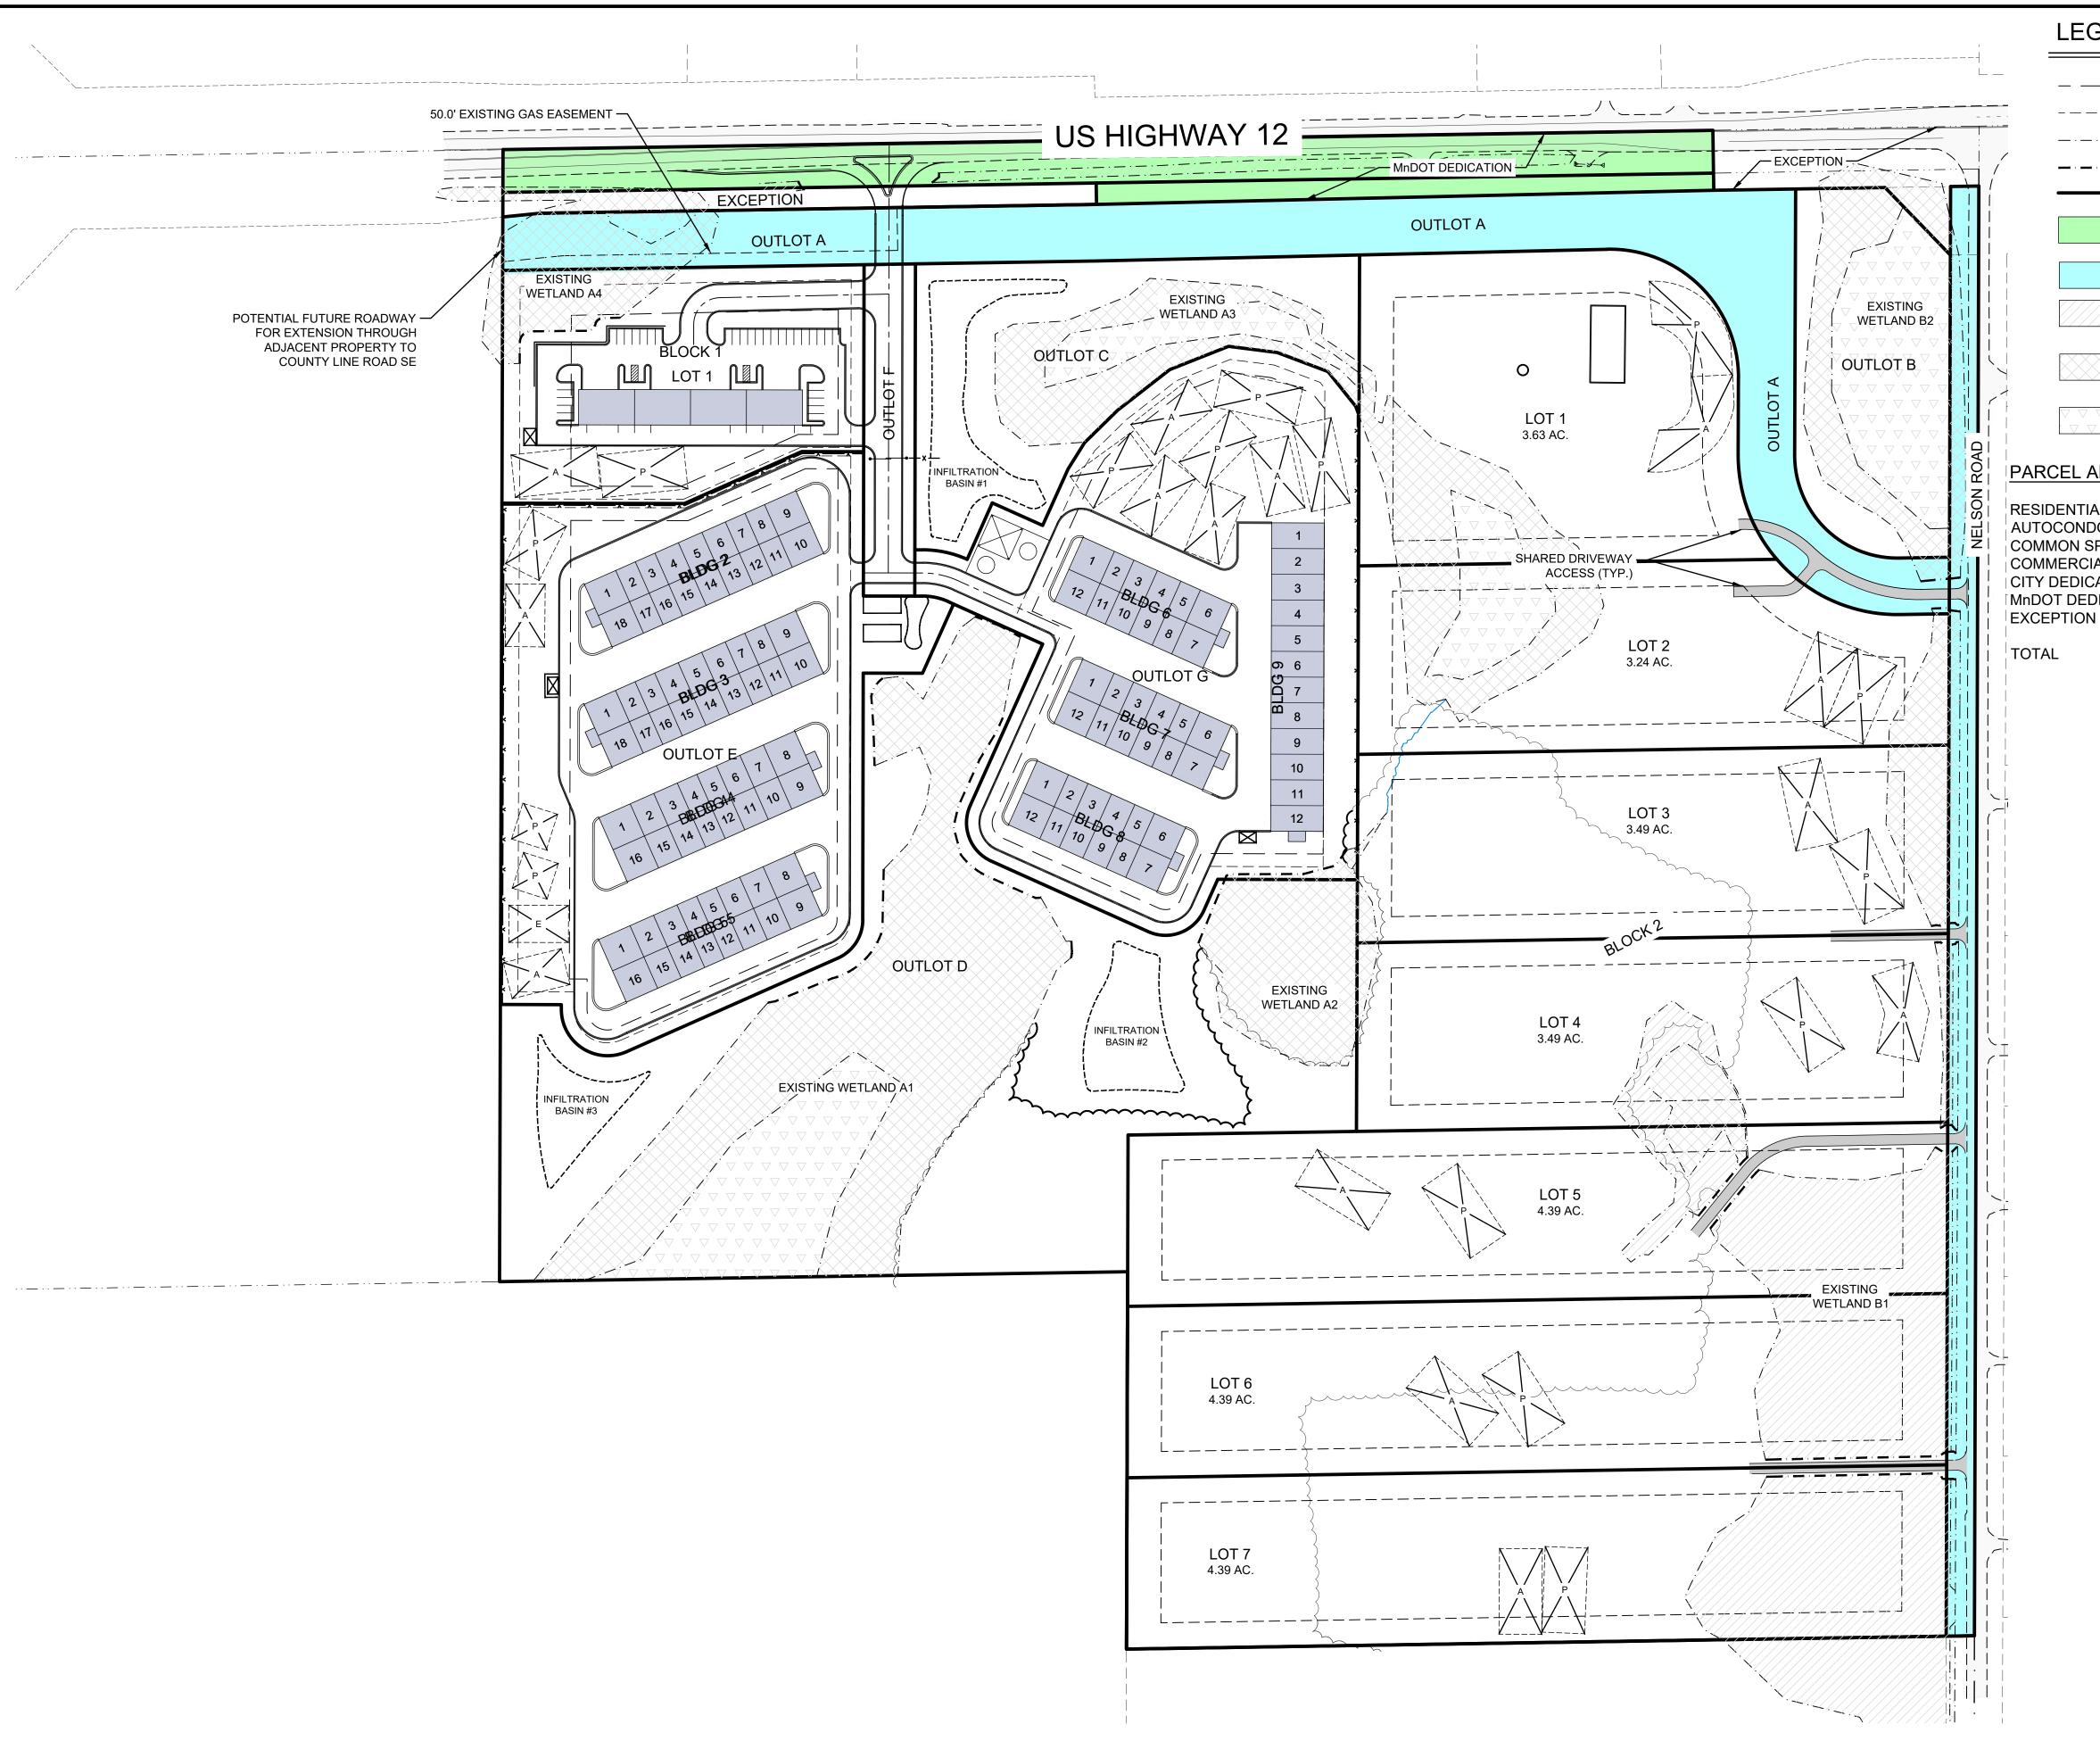


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_	· · · · ·	WETLAND FILL BOUNDARY		
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. ~	$\langle 4 \rangle$	SURMOUNTABLE CURB 5/C603		
	(5) (6)	TRANSITION CURB RIBBON CURB		
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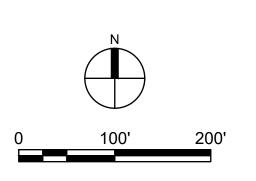
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E EXTRA SEPTIC DRAIN FIELD	ANDERSON
	13605 1st Avenue N. #100 Plymouth, MN 55441 ae-mn .com P 763.412.4000 F 763.412.4090 Anderson Engineering of Minnesota, LLC
EX. WETLAND BOUNDARY WETLAND FILL BOUNDARY WETLAND SETBACK LINE PARCEL/LOT BOUNDARY PERIMETER SITE FENCE WETLAND (TYPE 1) WETLAND (TYPE 2)	BRECKENRIDGE FARM
WETLAND (TYPE 3)	INDEPENDENCE, MINNESOTA
KEYNOTES:	
 1 B618 CURB & GUTTER 2 B612 CURB & GUTTER 3 CROSS GUTTER 4 SURMOUNTABLE CURB 5 TRANSITION CURB 	STODDARD COMPANIES
(6) RIBBON CURB(7) KEYED ACCESS GATE	I HEREBY CERTIFY THAT THIS PLAN, SPECIFICATION, OR REPORT WAS PREPARED BY ME OR UNDER MY DIRECT
8 PICKLE BALL COURT	SUPERVISION AND THAT I AM A DULY LICENSED PROFESSIONAL ENGINEER UNDER THE LAWS OF THE STATE OF MINNESOTA.
9 PUTTING GREEN	PRINT NAME: <u>LEE KOPPY, PE</u>
$\frac{PARKING}{BLOCK 2}$ N/A - RESIDENTIAL LOTS $\frac{BLOCK 1}{AUTO STALLS PROVIDED} = 42$ 10,600 SF COMMERCIAL @ 4.0 PER 1,000 SF = 42	SIGNATURE: DATE: 02/12/2024 LICENSE NO. 41267 REVISION LOG NO. DATE DESCRIPTION OF REVISIONS
BUILDINGS 2 THROUGH 5 - 72 AUTOCONDO UNITS PARKING STALLS PROVIDED = 151 1,700 LF PERIMETER PARKING @ 1 STALL/25 LF = 68 2,088 LF BUILDING FACE @ 1 STALL/25 LF = 83 BUILDINGS 6 THROUGH 9 - 48 AUTOCONDO UNITS	
AUTO STALLS PROVIDED = 97 1,000 LF PERIMETER PARKING @ 1 STALL/25 LF = 40 1,443 LF BUILDING FACE @ 1 STALL/25 LF = 57	FINAL PLAT
NOTE: ALL PROPOSED ROADWAY DIMENSIONS ARE TO FACE-OF-CURB.	DESIGNED: DRAWN: CHECKED BY: LRK MAM LRK DRAWING TITLE
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	BUILDING	SETBACK	
	PARKING	SETBACK	
- · _ · _ · _ · _	EX. WETL	AND BOUNDARY	
- , , , ,	WETLAND	FILL BOUNDARY	
	PARCEL/L	OT BOUNDARY	
	DEDICATE MNDOT (1	ED TO .99 ACRES)	
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	WETLAND	(TYPE 1)	
	WETLAND	(TYPE 2)	
$\begin{array}{c} \checkmark \bigtriangledown \lor \lor$	WETLAND	(TYPE 3)	
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NTIAL ONDOS ON SPACE/ OUTL RCIAL DICATION DEDICATION	OTS	AREA 27.02 ACRES 11.79 ACRES 13.52 ACRES 2.47 ACRES 4.53 ACRES 1.99 ACRES 0.93 ACRES	PERCENT 43.4% 18.9% 18.9% 3.9% 7.3% 3.2% <u>1.5%</u>

62.25 ACRES

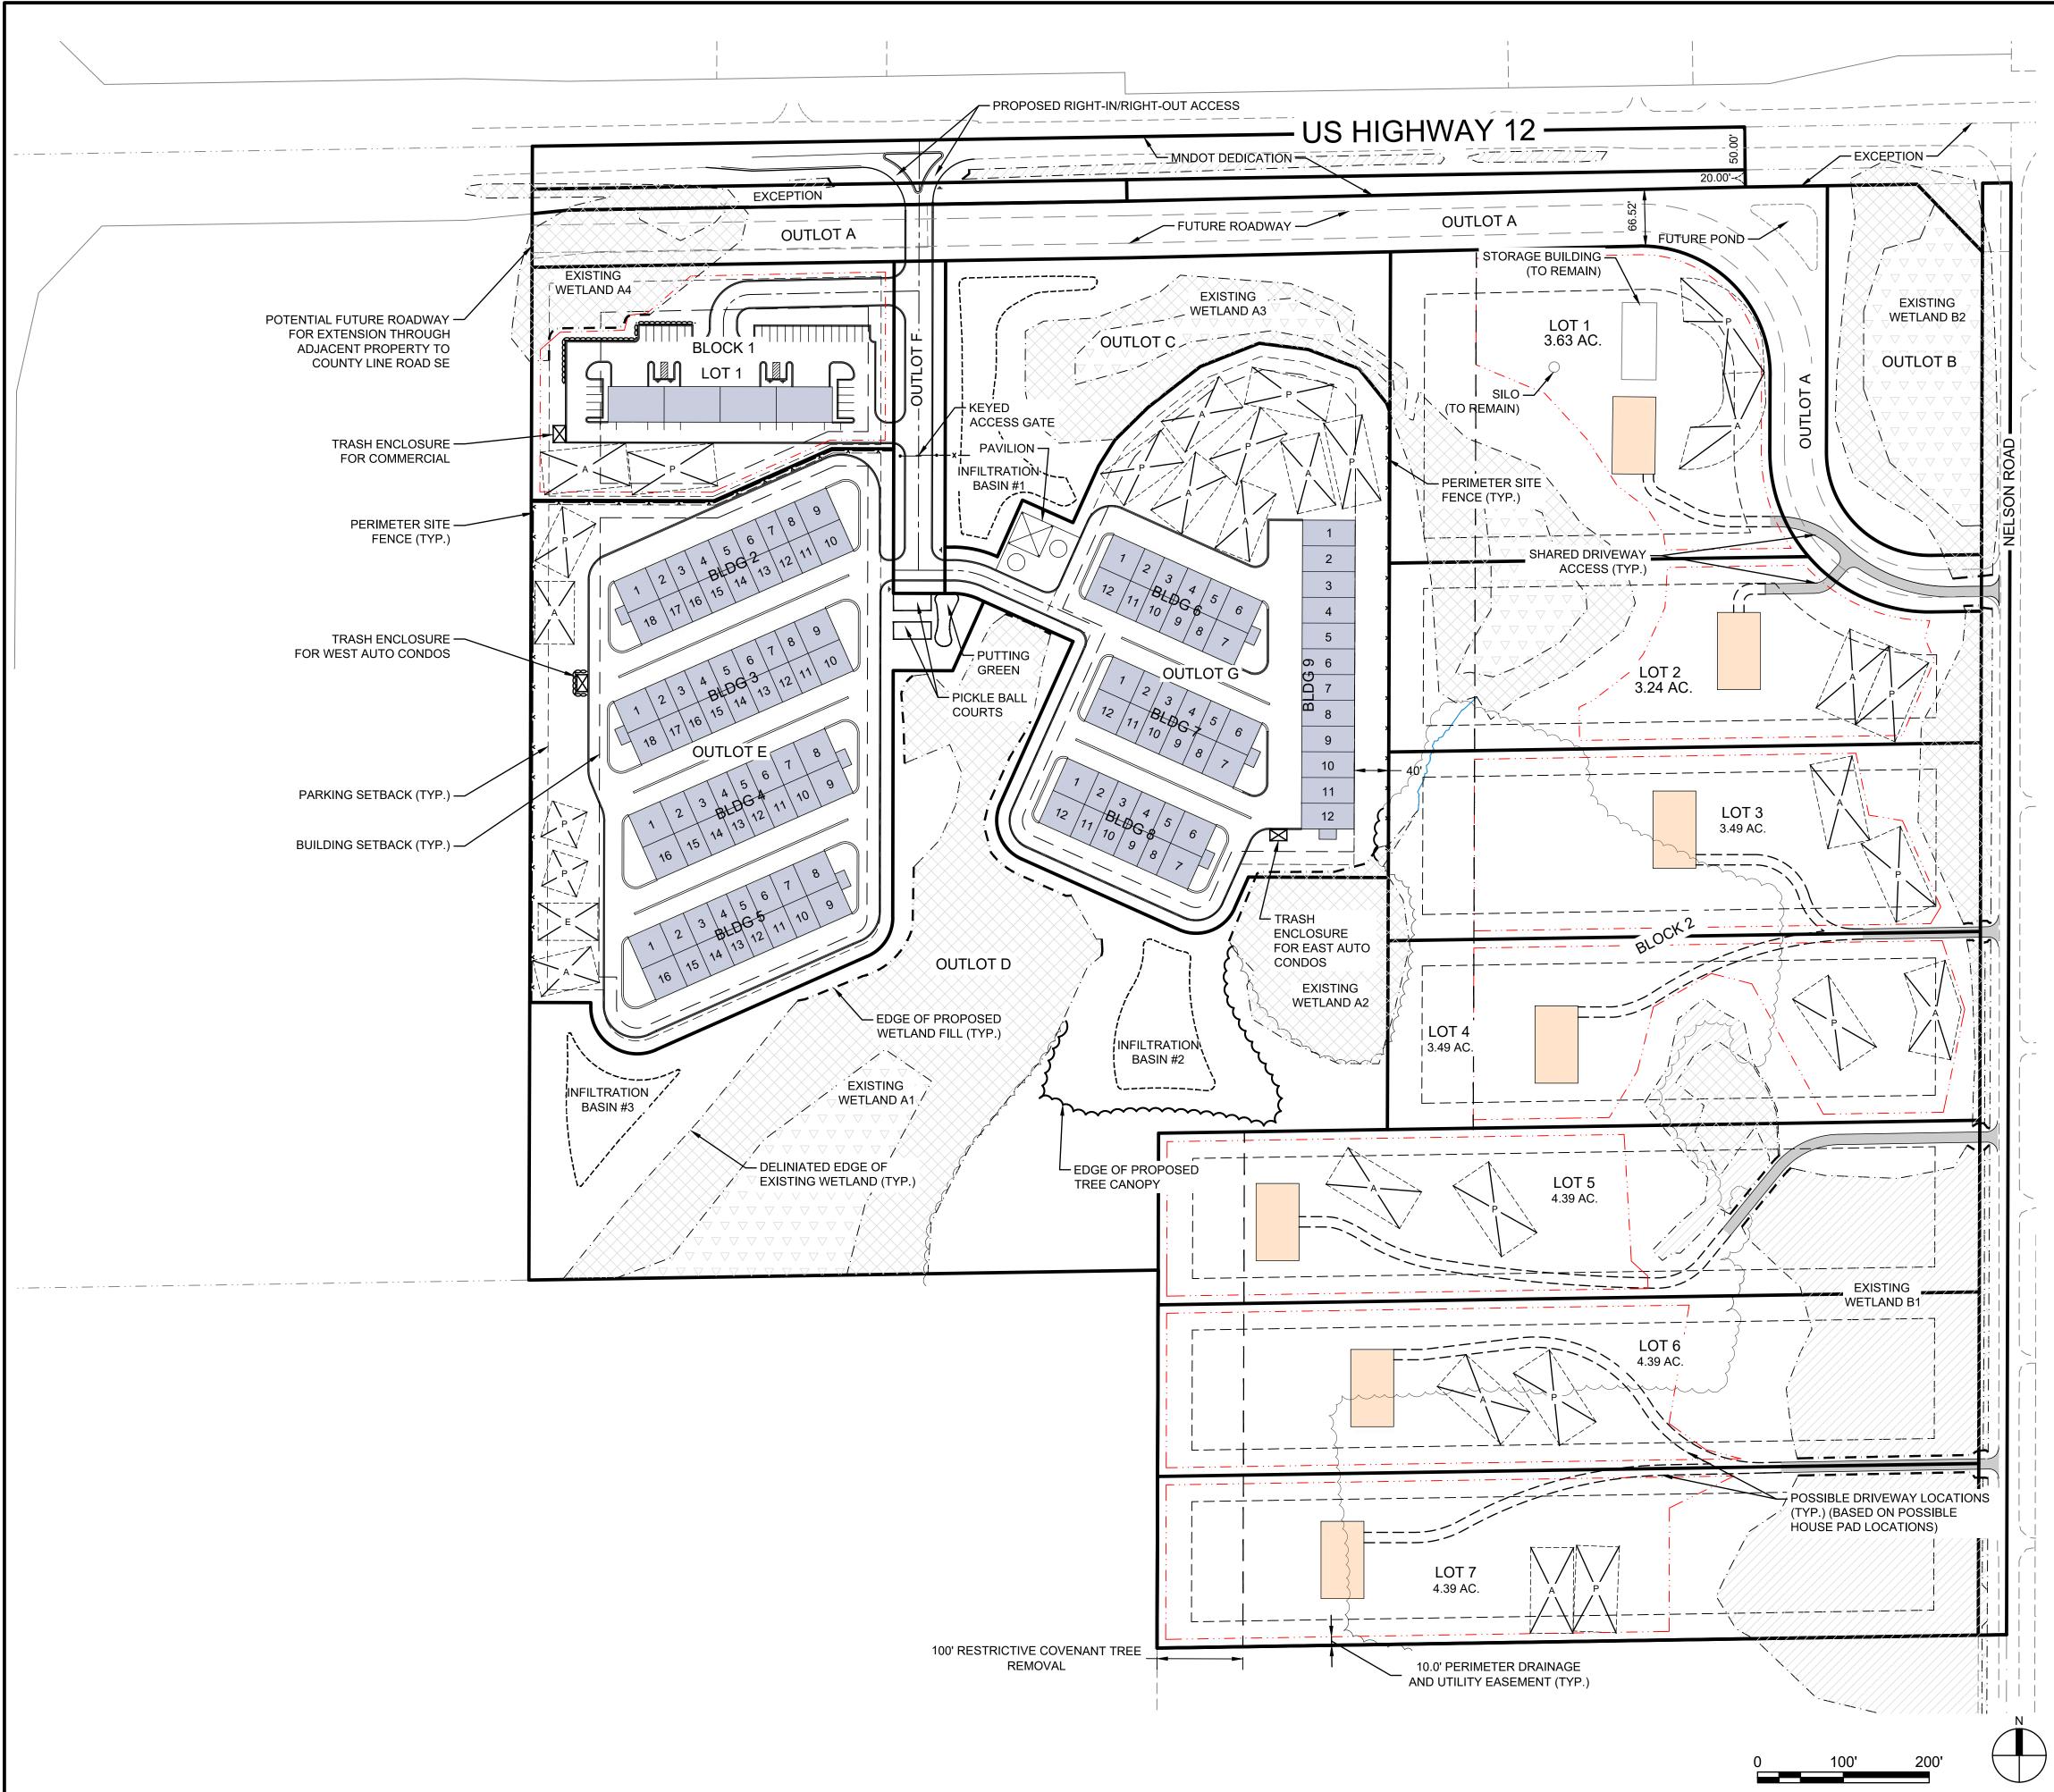100.0%





13605 1st Avenue N. #100 Plymouth, MN 55441 | ae-mn.com **P** 763.412.4000 | **F** 763.412.4090 Anderson Engineering of Minnesota, LLC

BRECKENRIDGE FARM

INDEPENDENCE, MINNESOTA

STODDARD COMPANIES

I HEREBY CERTIFY THAT THIS PLAN, SPECIFICATION, O REPORT WAS PREPARED BY ME OR UNDER MY DIRECT SUPERVISION AND THAT I AM A DULY LICENSED PROFESSIONAL ENGINEER UNDER THE LAWS OF THE STATE OF MINNESOTA.

RINT NAME:	LEE KOPPY,	ΡE
-		

SIGNATURE:

DATE: <u>02/12/2024</u> LICENSE NO. <u>41267</u>

REVISION LOG

NO. DATE DESCRIPTION OF REVISIONS

FINAL PLAT


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02/12/2024



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PRIMARY SEPTIC DRAIN FIELD ALTERNATE SEPTIC

EXTRA SEPTIC DRAIN FIELD

DRAIN FIELD

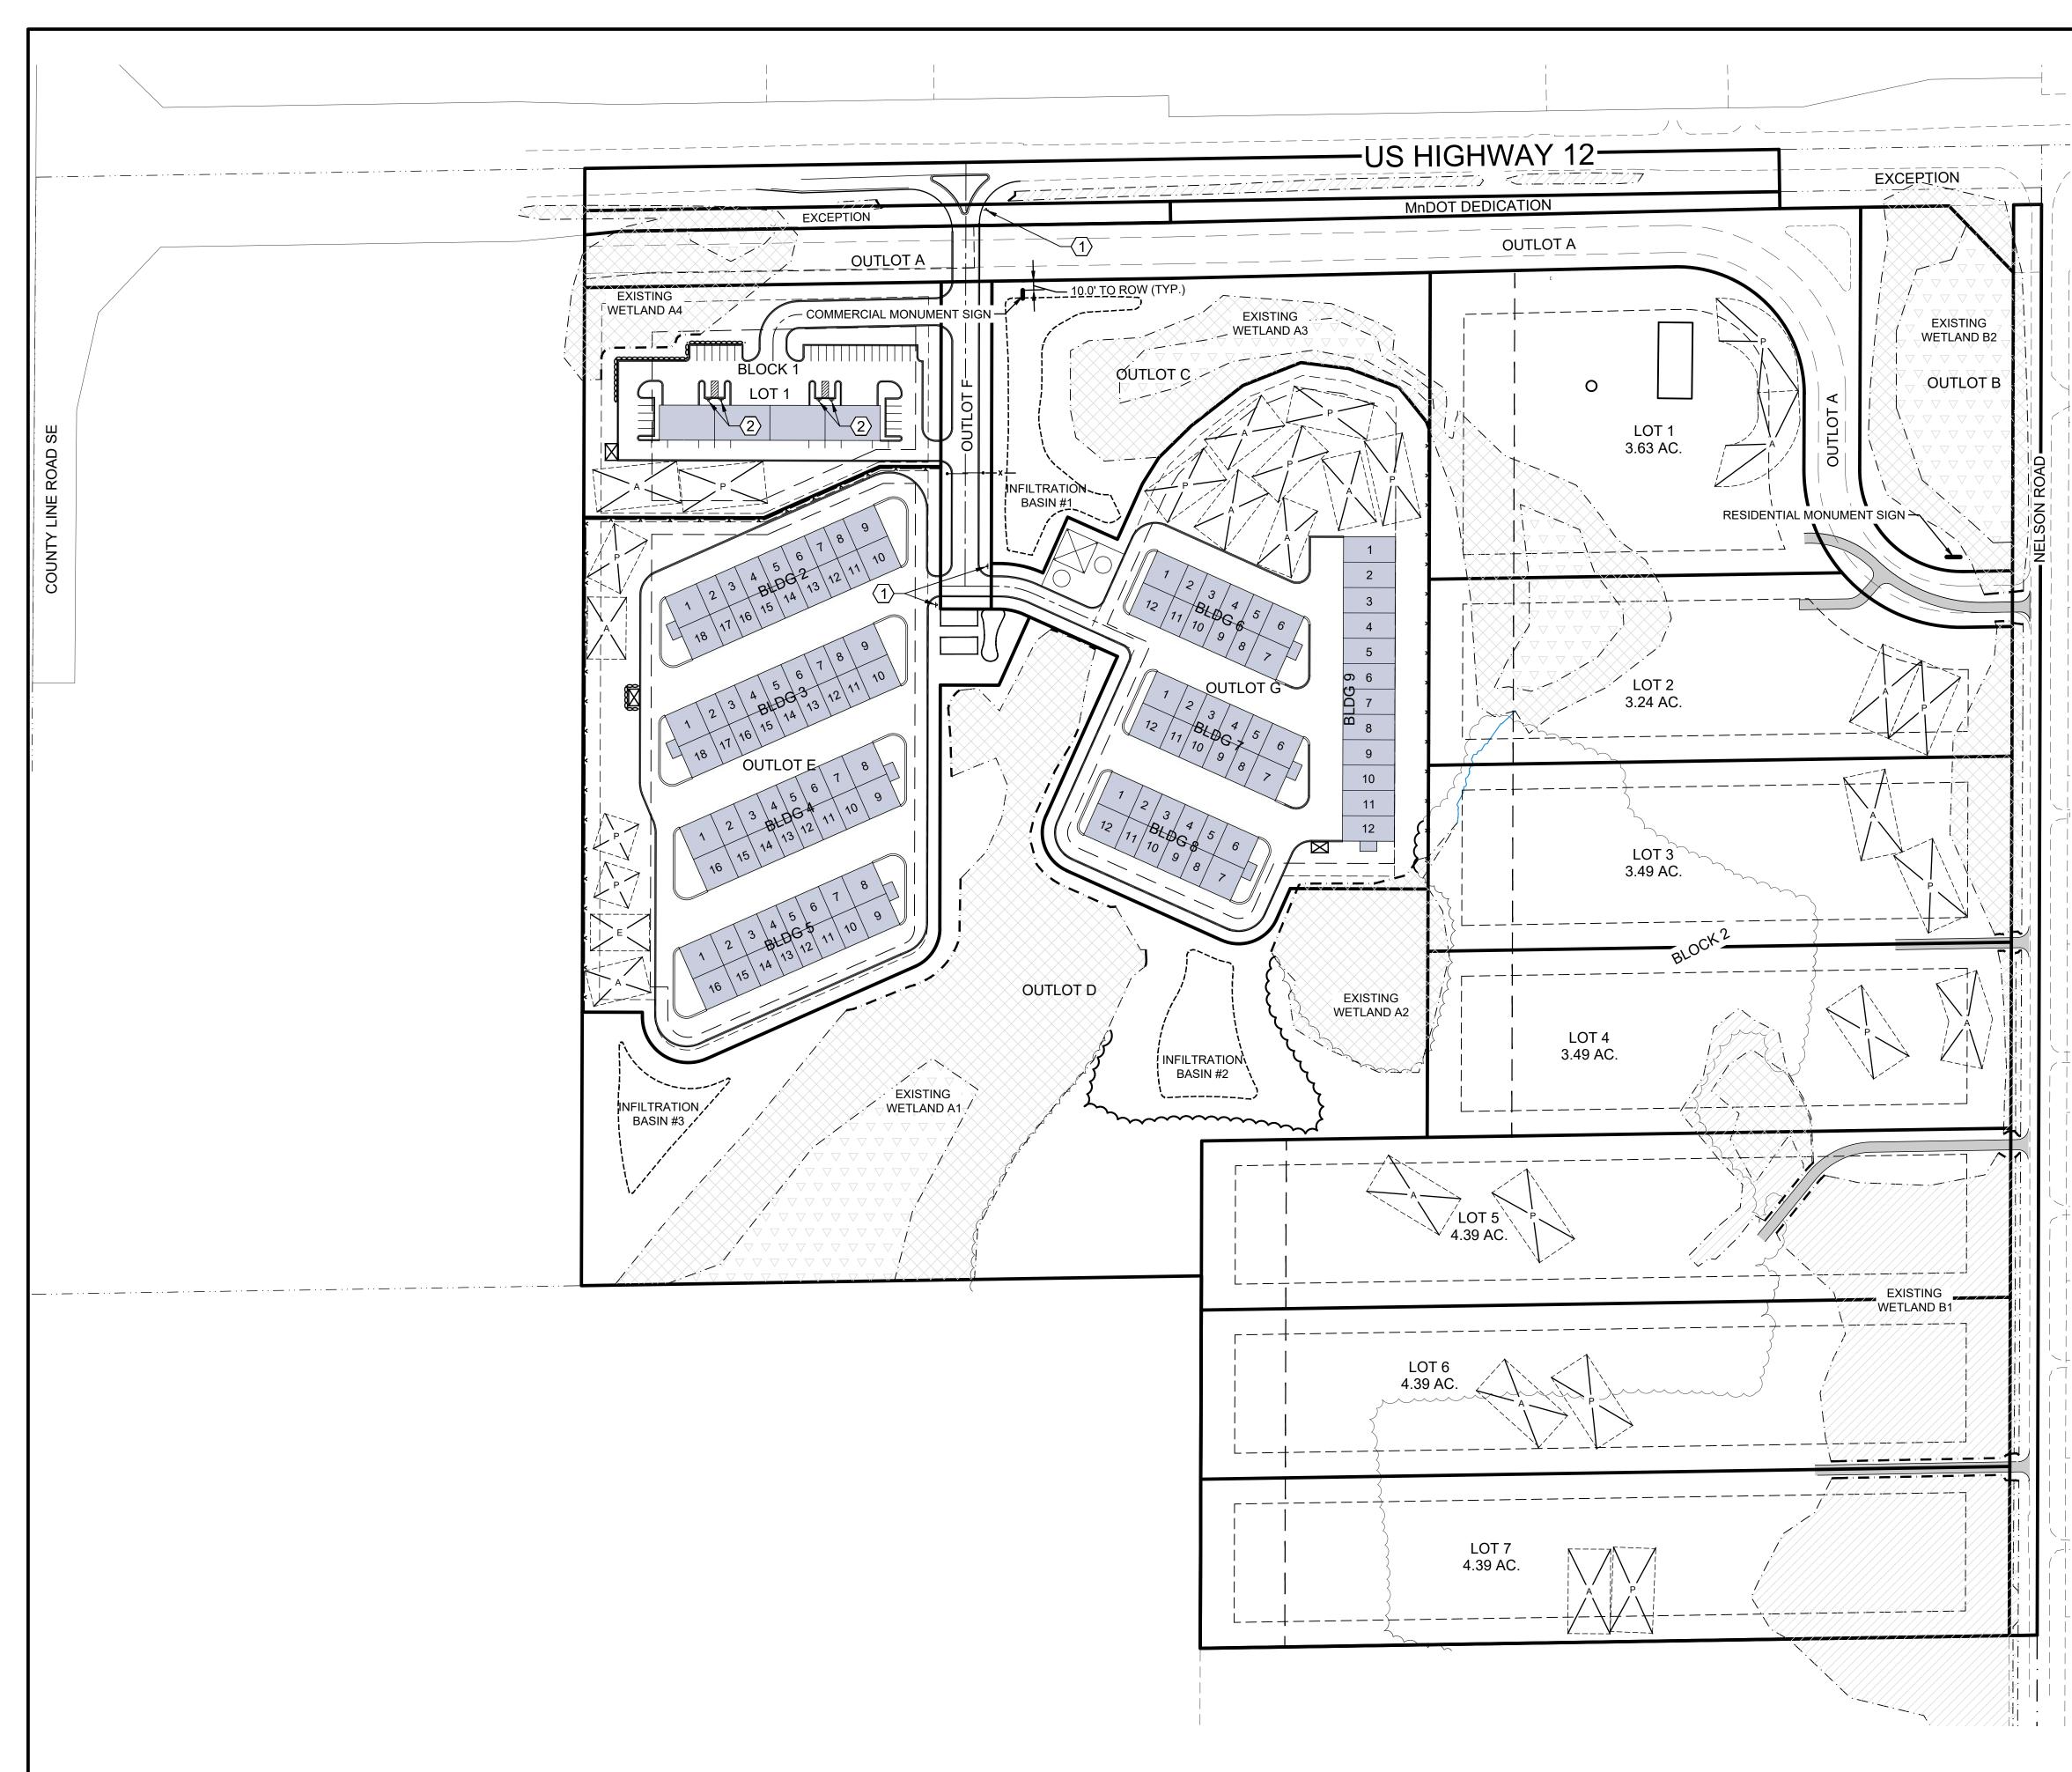BUILDING SETBACK PARKING SETBACK EX. WETLAND BOUNDARY WETLAND FILL BOUNDARY WETLAND SETBACK LINE PARCEL/LOT BOUNDARY PERIMETER SITE FENCE WETLAND (TYPE 1)

WETLAND (TYPE 2)

WETLAND (TYPE 3)


SHARED DRIVEWAY

KEY NOTES

$\langle 1 \rangle$	YIELD SIGN SEE DETAIL 7/C603
2>	HANDICAP ACCESSIBLE PARKING SEE DETAIL 6/C603


NOTES

- 1. COMMERCIAL TWO SIDED SIGN 80 SF MAX. SETBACK 10 FT FROM ROW.
- 2. RESIDENTIAL TWO SIDED SIGN 32 SF MAX.
- 3. SIGNAGE TO CONFORM TO CITY SIGN REGULATIONS SECTION NO. 550.
- 4. SHIELD ILLUMINATION FROM INCOMING TRAFFIC. ILLUMINATION CANNOT BE DIRECTED TOWARDS RESIDENCES.
- 5. SIGN MATERIALS: ANTIQUED COR-TEN STEEL AND WOOD FRAME

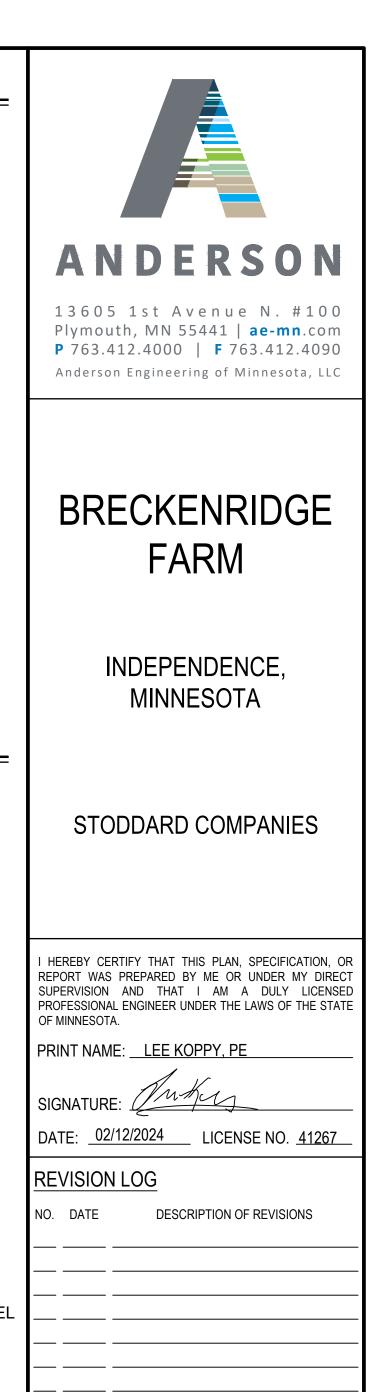



FINAL PLAT

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LRK	MAM	LRK			
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SIGNAGE PLAN					
DRAWING NO.					
C104					

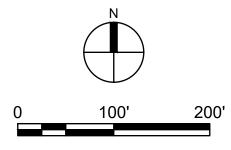


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02/12/2024	16915

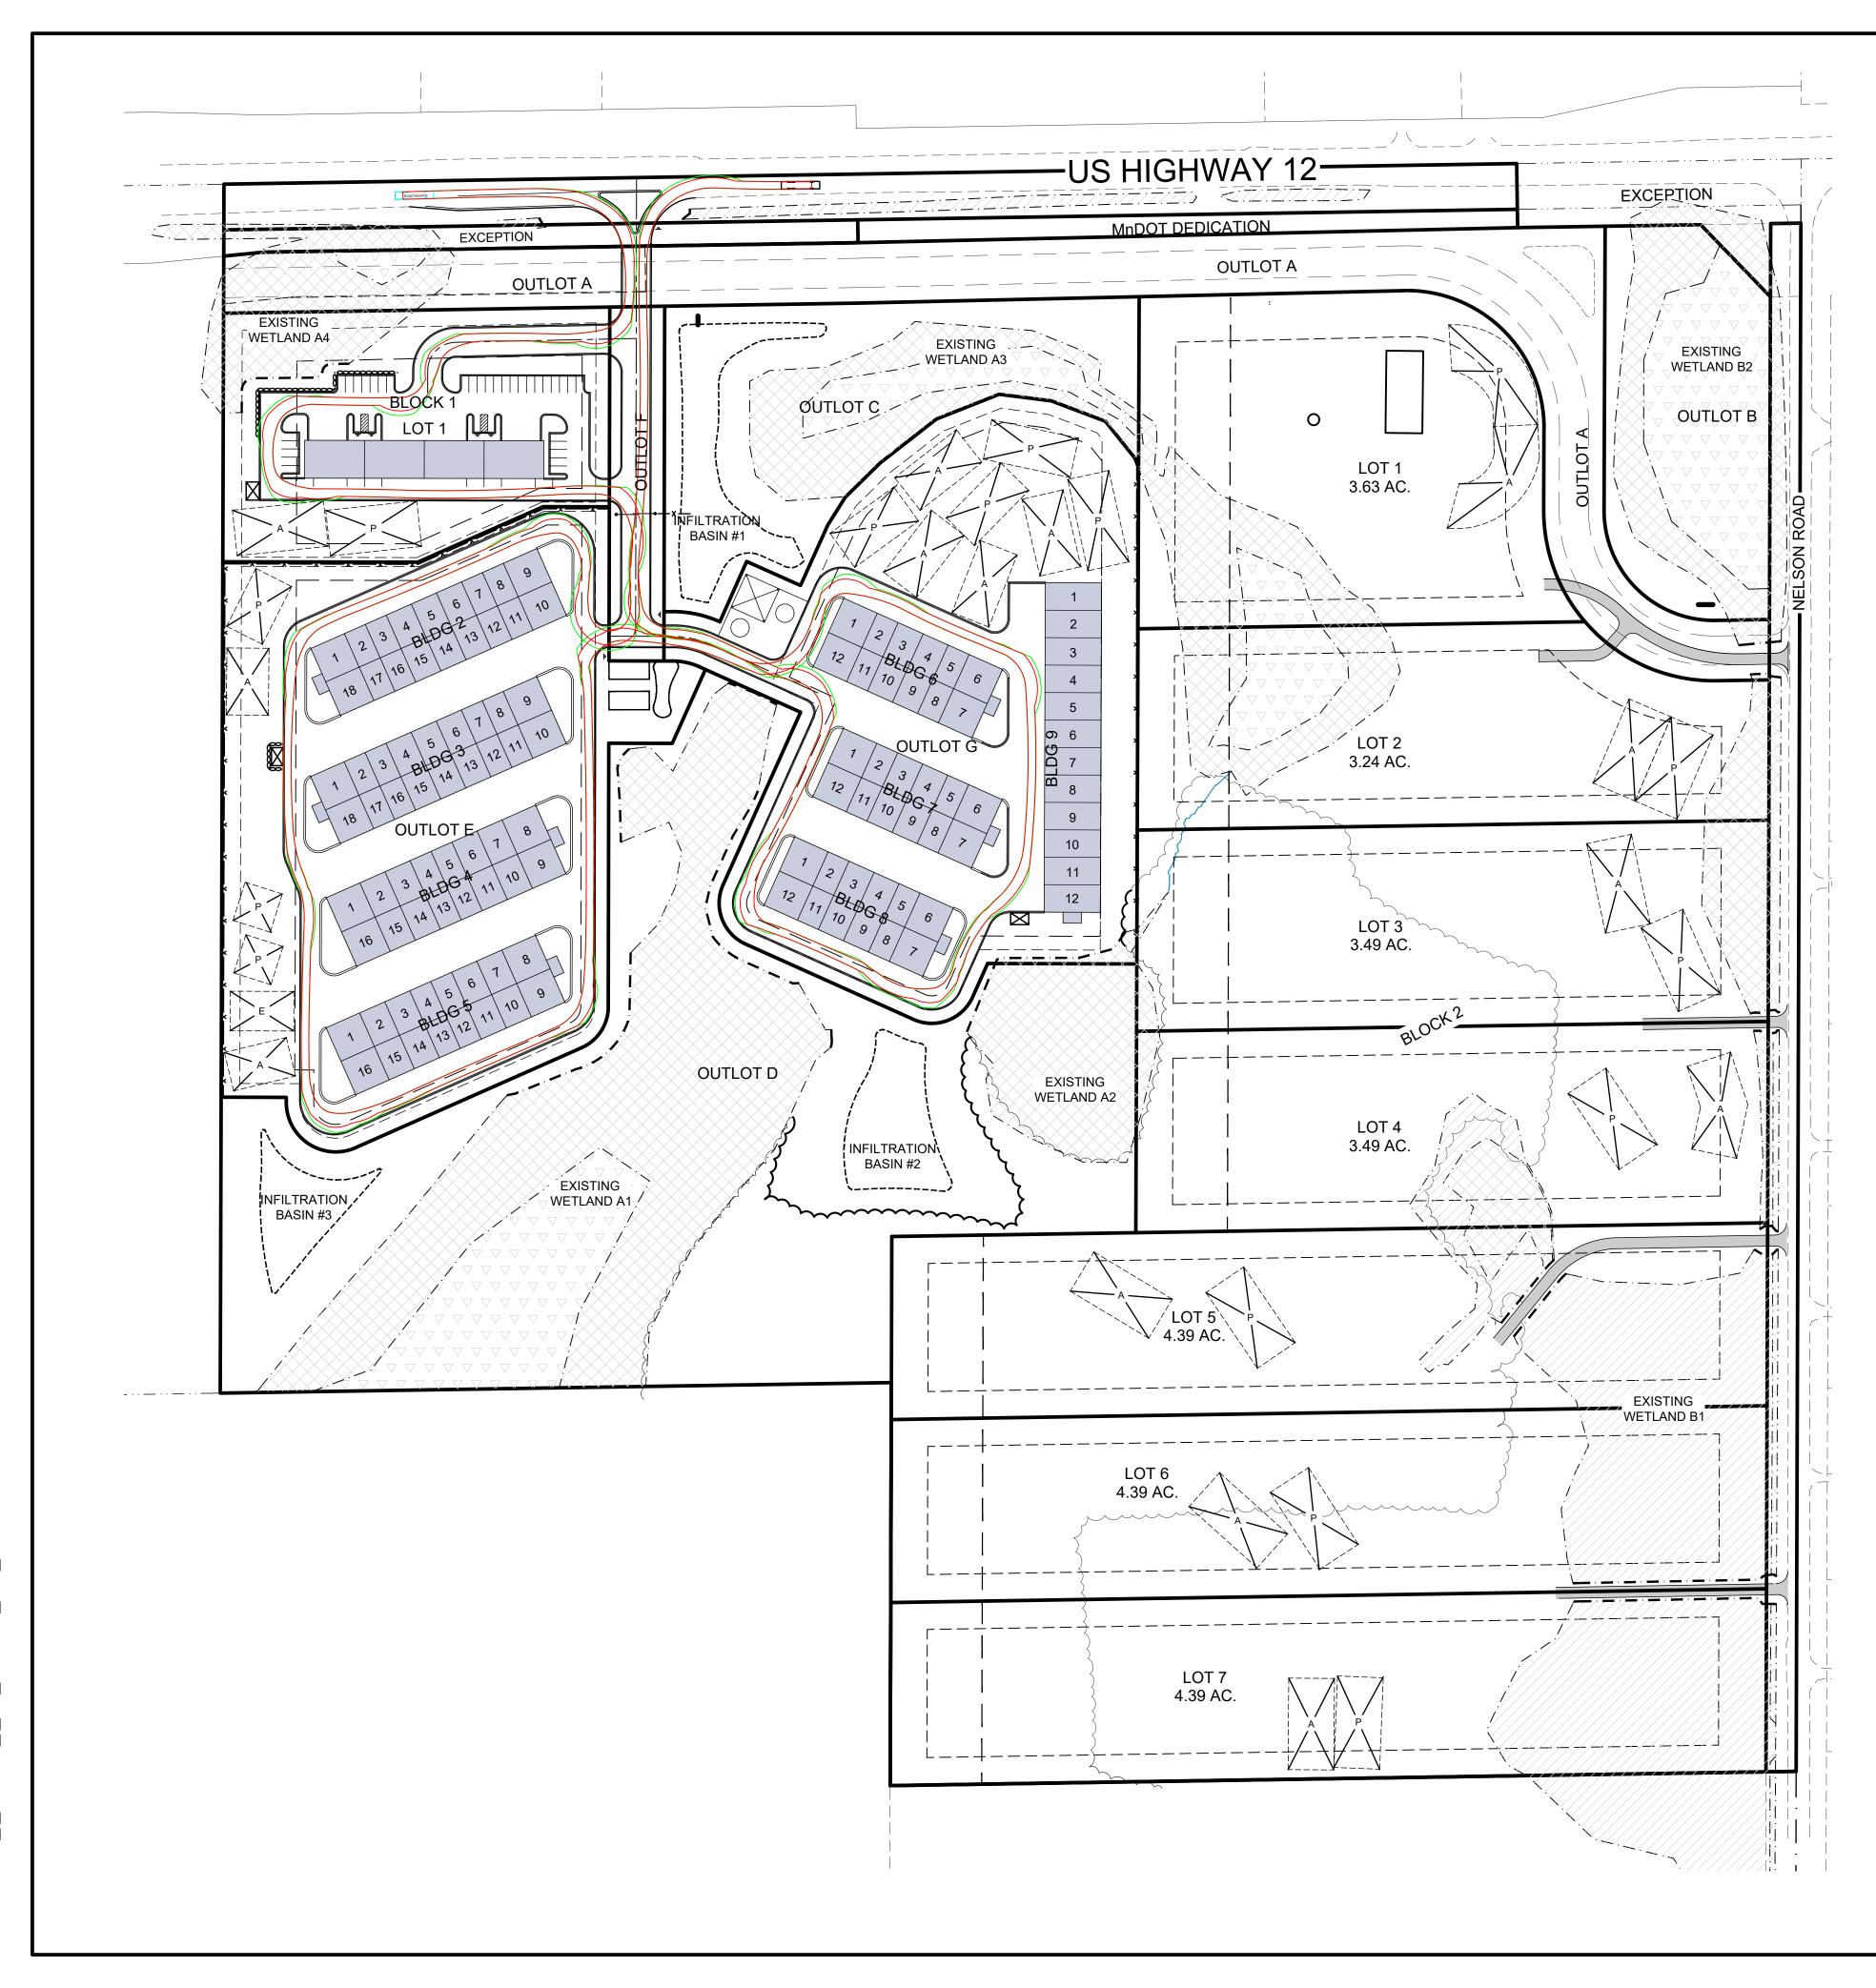

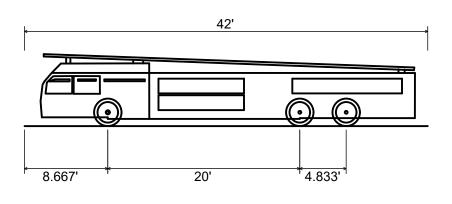

Pierce Velocity 100' Heavy-Duty Aerial Tower Overall Length Overall Width Overall Body Height Min Body Ground Clearance Track Width Lock-to-lock time Max Wheel Angle

LEGEND

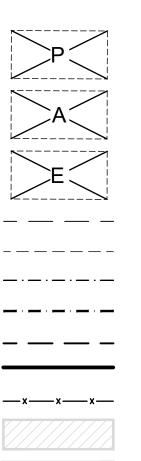

WHEEL PATH

OVERHANG PATH

PRIMARY SEPTIC DRAIN FIELD

ALTERNATE SEPTIC DRAIN FIELD

EXTRA SEPTIC DRAIN FIELD


BUILDING SETBACK PARKING SETBACK EX. WETLAND BOUNDARY WETLAND FILL BOUNDARY WETLAND SETBACK LINE PARCEL/LOT BOUNDARY PERIMETER SITE FENCE WETLAND (TYPE 1)

WETLAND (TYPE 2)

WETLAND (TYPE 3)

SHARED DRIVEWAY



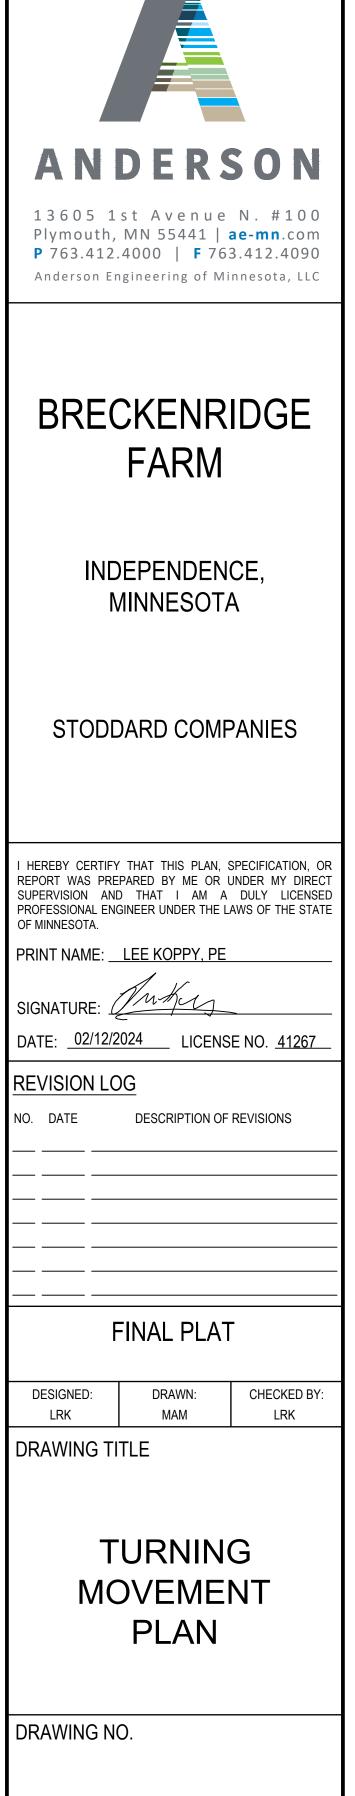

C105


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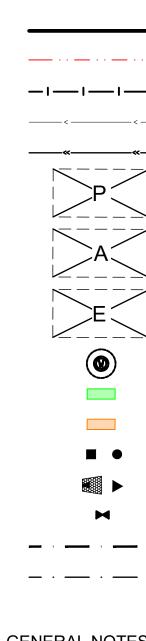
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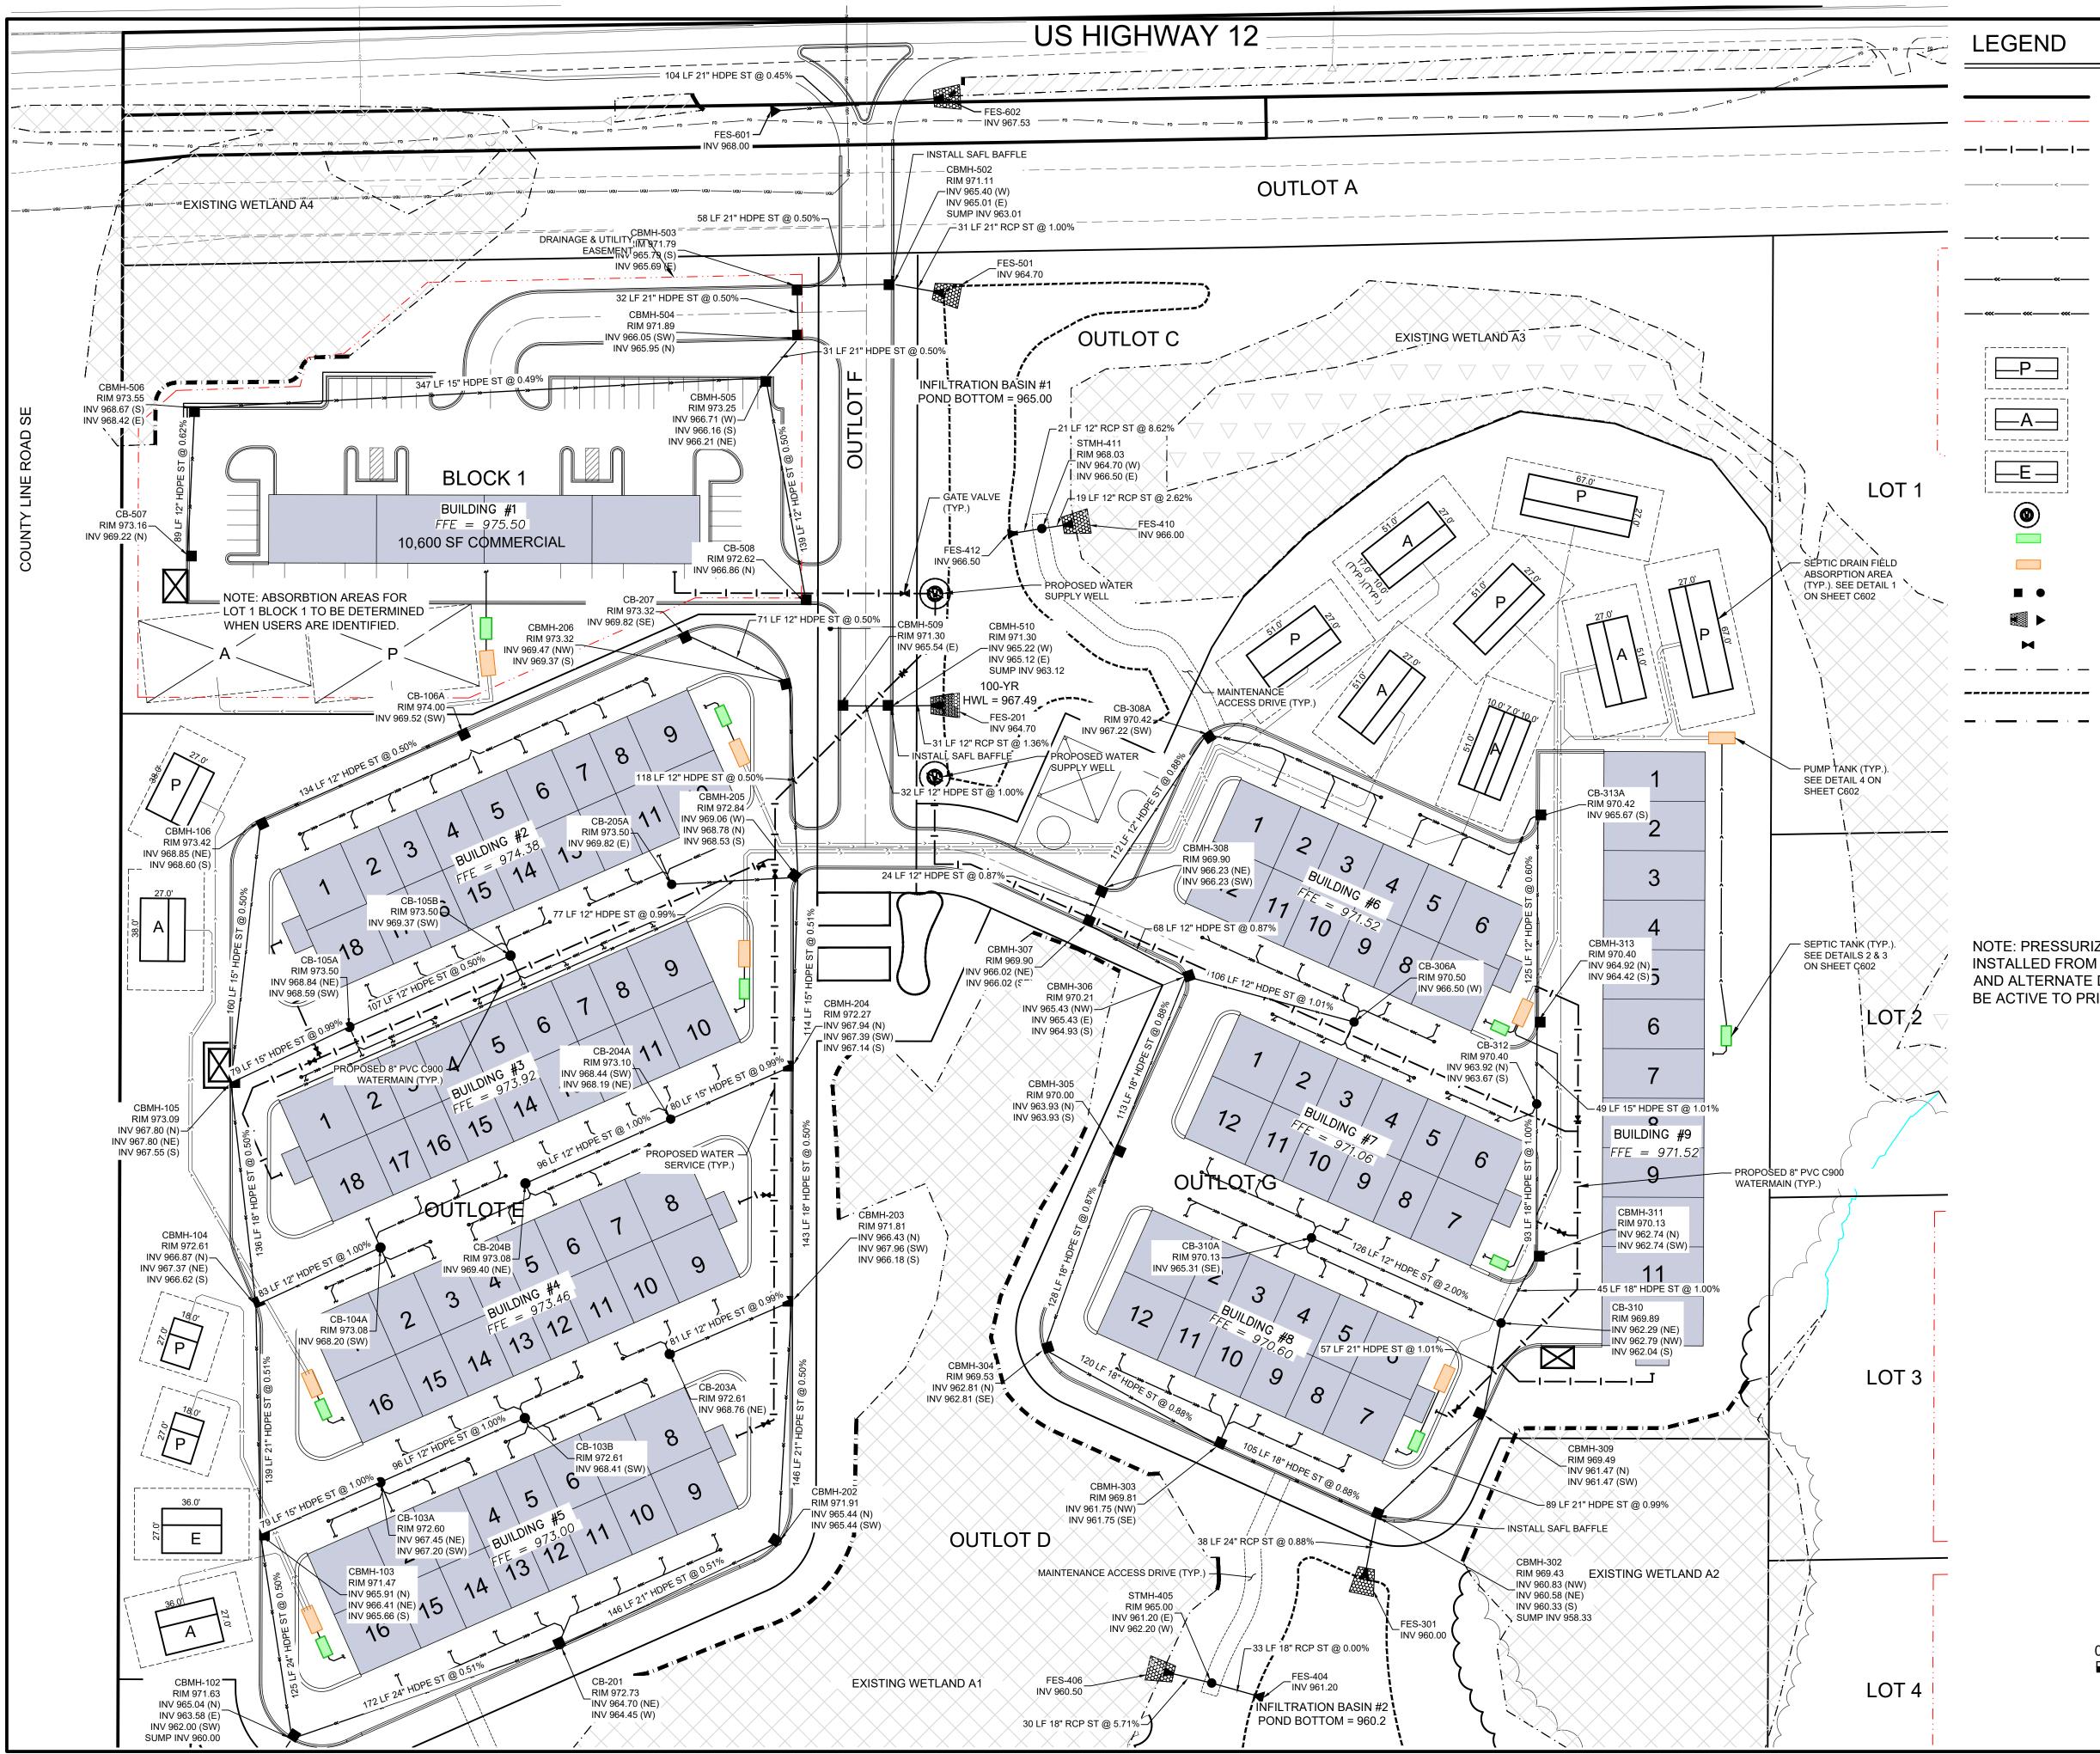
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- GENERAL NOTES 1. ALL WATERN MINIMUM DE HORIZONTAI CROSSINGS **BE INSULATE** DEPTHS CAN THE ENGINE DEPTH CANN 2. ALL NEW NC
- SHALL HAVE 3. SUBSTITUTIO AND APPRO
- 4. ALL PORTIO FEET OF THE IN ACCORDA SECTION 110
- 5. PVC SANITA MINNESOTA STANDARD 1 OR F794 RES OR PUSH-ON WELDING US MUST COMPL 6. HDPE STORM
- RULES, CHAF STANDARD 1 CONNECTIO COMPLY WIT 7. WATER SER
- PIPE SHALL SERVICE SIZ INSTALLED F REQUIREME CONDUCTIVI FOR BACTER STANDARD S TRACER WIR WATERMAIN STANDARDS 8. SANITARY SE PIPE SHALL B
- WHERE 7.5 F APPLIES TO / SANITARY SE C.E.A.M. STA AND ALIGNM
- 9. ALL JOINTS / SHALL BE W MUST BE USE MANHOLES A

LEGEND					
 	 PROPERTY LIMITS DRAINAGE AND UTILITY EASE PROPOSED WATERMAIN 	EMENT			
	 PROPOSED SANITARY SEWE 	R			CON
	 PROPOSED STORM SEWER PRIMARY SEPTIC 		ANL) E K	SON
	DRAIN FIELD ALTERNATE SEPTIC		Plymouth, N	MN 55441	e N. #100 ae-mn .com 763.412.4090
	DRAIN FIELD		Anderson Eng	ineering of	Minnesota, LLC
E	EXTRA SEPTIC DRAIN FIELD				
	PROPOSED WATER WELL				
	PROPOSED SANITARY SEPTI PROPOSED SANITARY PUMP	-	BKFC	KENH	RIDGE
	STORM INLETS	TANK PROPOSED		FARM	Λ
	PROPOSED FES				1
	PROPOSED WATERMAIN GAT				
	 WETLAND FILL BOUNDARY 				
_ · _ · _ · _ · ·	 EXISTING WETLAND BOUNDA 	RY		EPENDE INNESO	•
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MINIMUM DEPT HORIZONTAL A CROSSINGS FF BE INSULATED DEPTHS CANN THE ENGINEEF DEPTH CANNO		ROVIDE MINIMUM 10' F ALL WATERMAIN R. WATERMAIN TO /HERE COVER SHALL CONTACT NIMUM COVER	STODD	ARD CON	MPANIES
	METALLIC SANITARY AND WATER RACER WIRE, PER SPECIFICATION				
3. SUBSTITUTION	S FROM INFO. SHOWN HERON SH	IALL BE REVIEWED			N, SPECIFICATION, OR R UNDER MY DIRECT
	D BY THE ENGINEER OF RECORD OF THE STORM SEWER SYSTEM		PROFESSIONAL ENGIN		A DULY LICENSED IE LAWS OF THE STATE
FEET OF THE B	UILDING OR WATER SERVICE LIN	E MUST BE TESTED	OF MINNESOTA.		
IN ACCORDANC SECTION 1109.	CE WITH MINNESOTA RULES, CHA 0	PTER 4714,	PRINT NAME: <u>L</u>	<u>.EE KOPPY, F</u>	<u>PE</u>
5. PVC SANITARY	SEWER MUST MEET ASTM STAN		SIGNATURE:	Inthe	1
	JLES, CHAPTER 4714, TABLE 701. ² FITTINGS MUST COMPLY WITH AS		DATE: 02/12/202	24	NSE NO. <u>41267</u>
OR F794 RESPI	ECTIVELY. JOINTS MUST BE APPR	OVED MECHANICAL	DATE. <u>02/12/20</u>	<u></u> LICE	NSE NO. <u>41207</u>
	ITILIZING ELASTOMERIC SEAL, OF IG ASTM F656 AND ASTM D2564. T		REVISION LOC	3	
MUST COMPLY	WITH ASTM D232.		NO. DATE	DESCRIPTION	OF REVISIONS
	SEWERS MUST MEET ASTM F714 (ER 4714, SECTION 1102.4 AND INS				
	WATER TIGHT JOINTS MUST BE U 5, INCLUDING STRUCTURES. THE I				
COMPLY WITH	ASTM D2321.				
	CE MATERIALS AND SANITARY SE PVC C900. CONTRACTOR SHALL				
	AND MATERIALS PRIOR TO CONS E WILL REQUIRE TESTING PER CI				
REQUIREMENT	'S. THIS WILL INCLUDE, AT A MININ AND PRESSURE TESTING, AS WI	ИUM,	FI	NAL PLA	٩T
	AND PROPER DISINFECTION. FO ECIFICATIONS UNLESS NOTED OT				
,	JOINT RESTRAINTS AND THRUST PE AND FITTING, PER CITY OF INI		DESIGNED: LRK	DRAWN: MAM	CHECKED BY: LRK
STANDARDS.	·		DRAWING TIT	LE	
	/ER GRAVITY PIPE MATERIALS SH INSULATED PER CITY AND C.E.A.				
	OT COVER DEPTHS ARE NOT ACH				
-	L PROPOSED NEW PIPE FOR THIS /ER PIPE WILL REQUIRE TESTING				
C.E.A.M. STAND	DARDS. THIS WILL INCLUDE, AT A	MINIMUM, LEAKAGE	OVER	RALL U [.]	TILITY
9. ALL JOINTS AN SHALL BE WAT MUST BE USED	D CONNECTIONS IN THE STORM ER TIGHT. APPROVED RESILIENT TO MAKE WATER TIGHT CONNEC D CATCH BASINS.	RUBBER JOINTS		PLAN	
	Ν		DRAWING NO		
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	0 100'	200'			
			PLOTTED: 02/12/2024		COMM. NO. 16915



PROPERTY LIMITS **DRAINAGE & UTILITY EASEMENT PROPOSED WATERMAIN** PROPOSED SANITARY SEWER (PRESSURIZED) **PROPOSED SANITARY SEWER** (GRAVITY)

PROPOSED STORM SEWER PROPOSED STORM SEWER (FLOOR DRAIN CONNECTIONS)

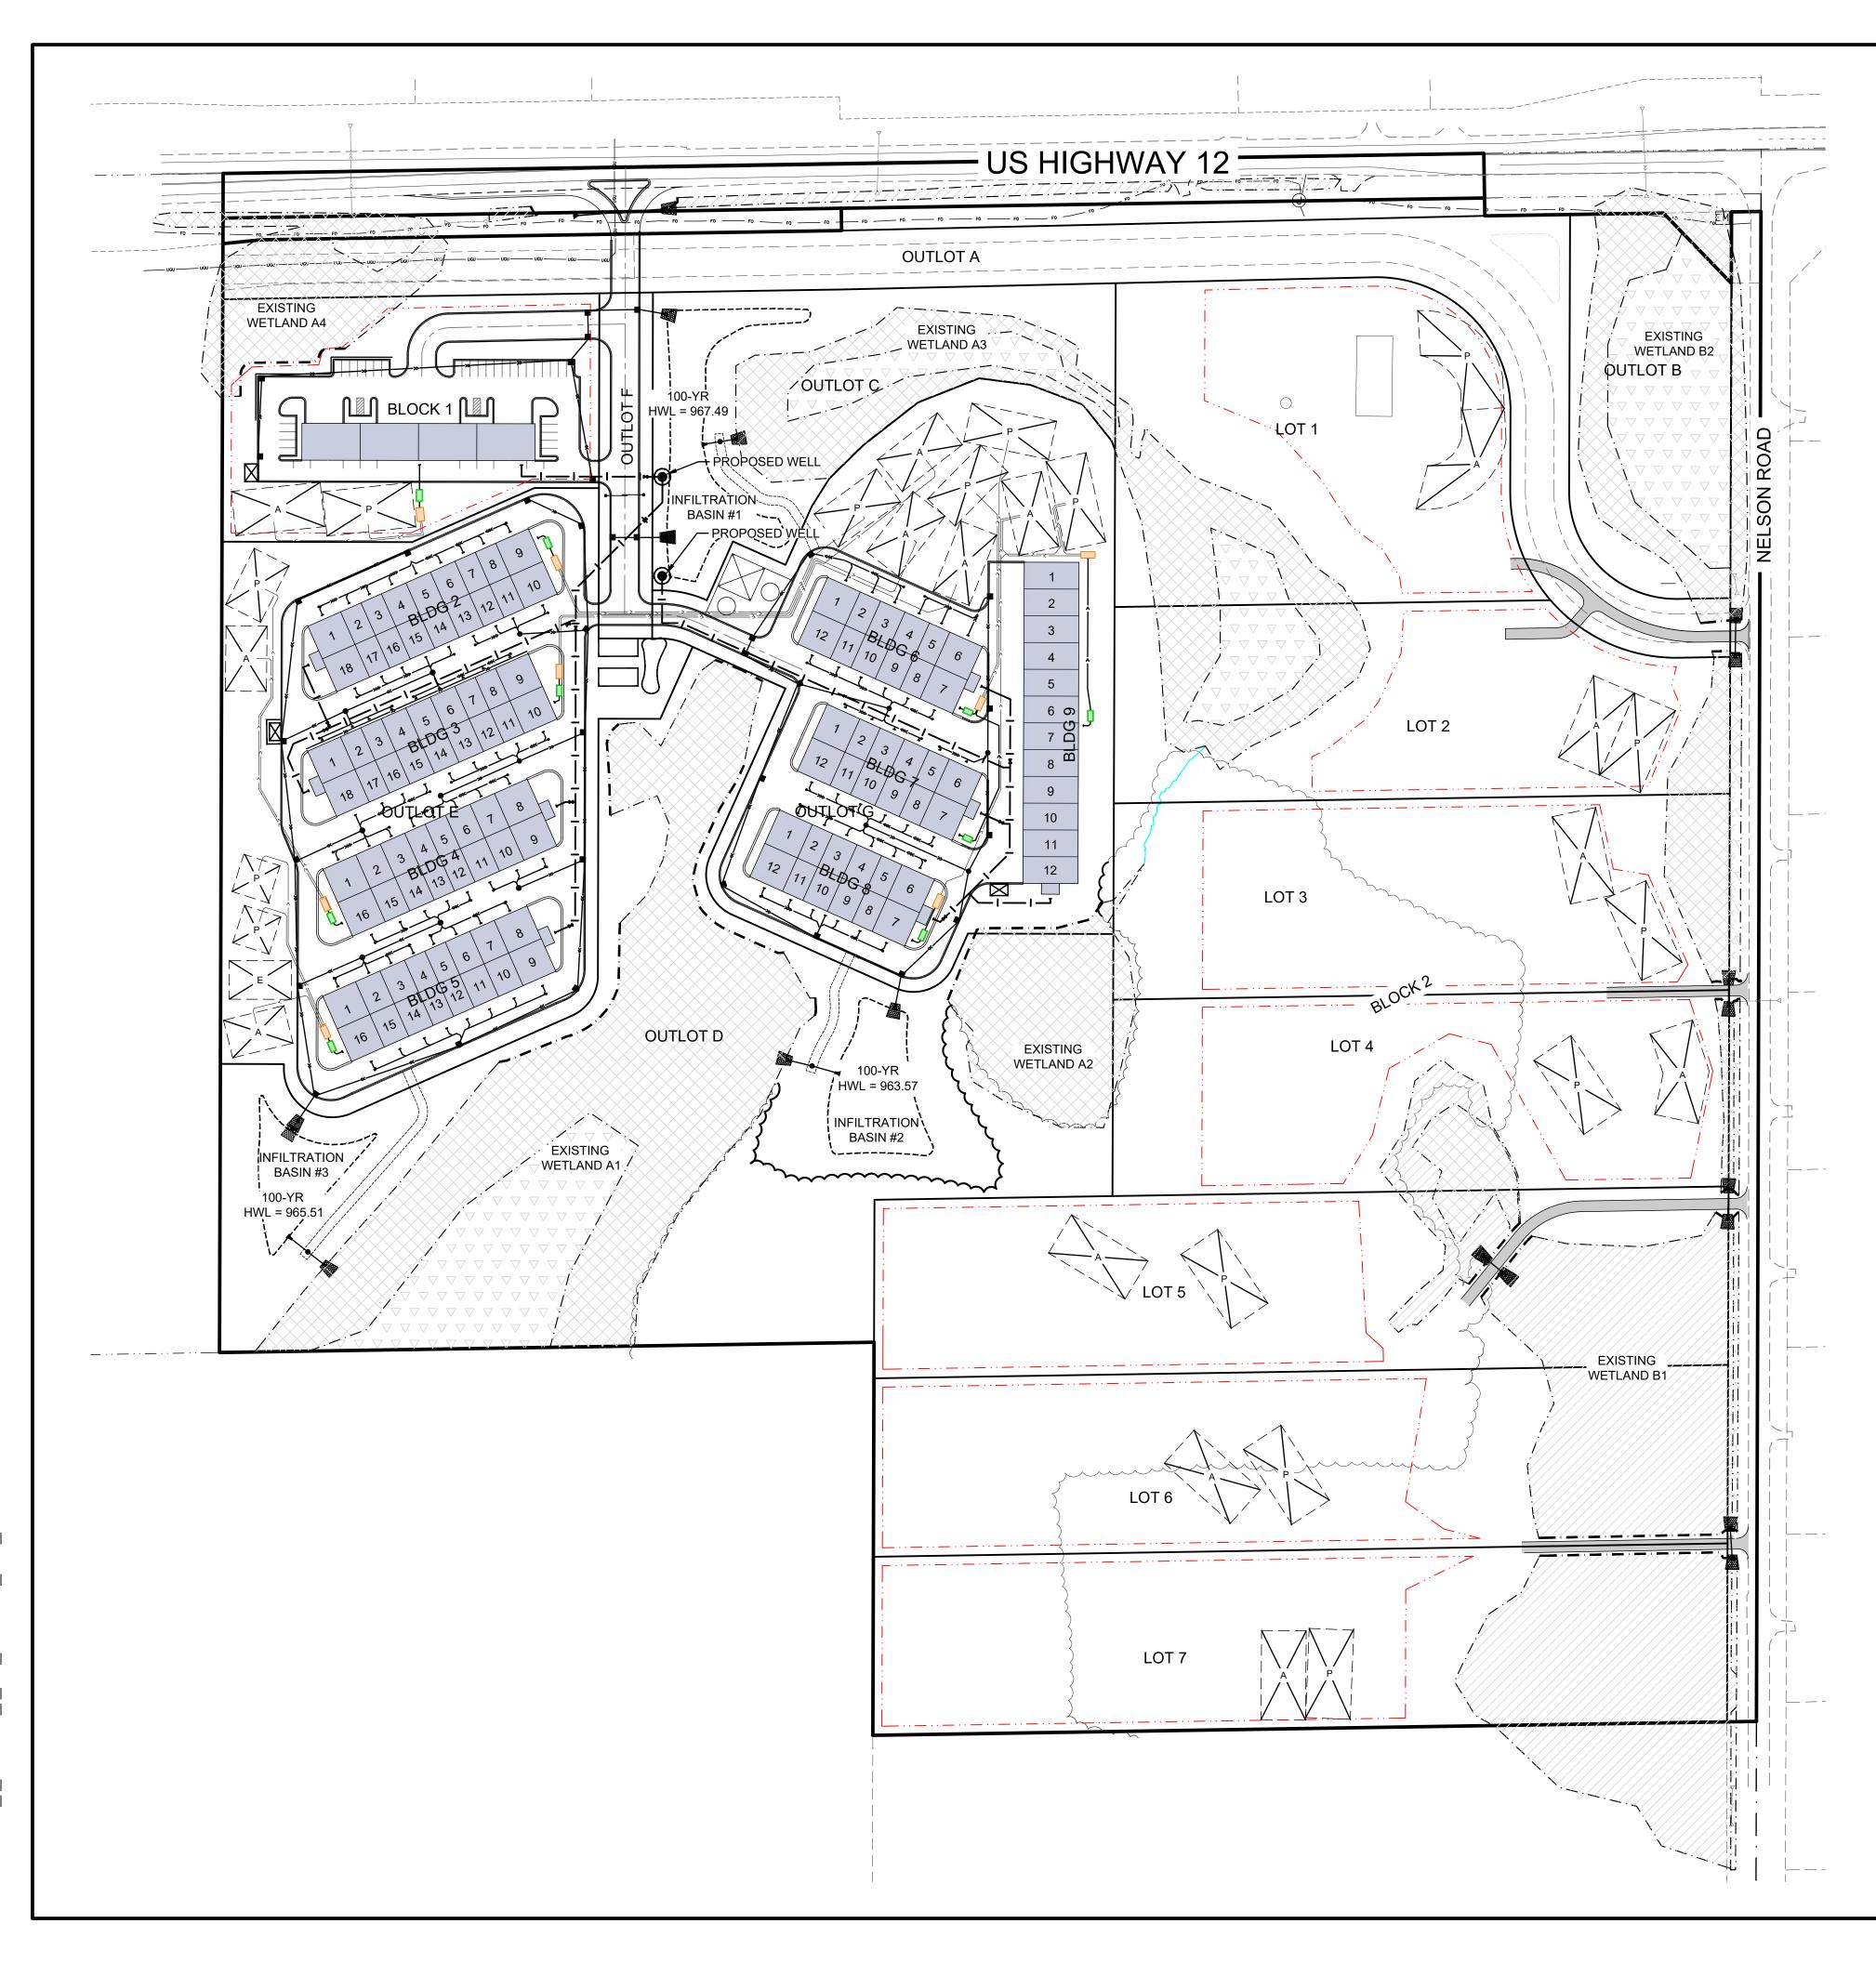PRIMARY SEPTIC DRAIN FIELD


ALTERNATE SEPTIC DRAIN FIELD


EXTRA SEPTIC DRAIN FIELD


PROPOSED WATER WELL PROPOSED SANITARY SEPTIC TANK PROPOSED SANITARY PUMP TANK **PROPOSED STORM INLETS PROPOSED FES** PROPOSED WATERMAIN GATE VALVE EXISTING WETLAND BOUNDARY **BOTTOM OF INFILTRATION BASIN** WETLAND FILL BOUNDARY

NOTE: PRESSURIZED SANITARY SEWER PIPE TO BE INSTALLED FROM EACH BUILDING TO BOTH PRIMARY AND ALTERNATE DRAIN FIELDS. ONLY PUMPING WILL BE ACTIVE TO PRIMARY DRAIN FIELDS.

	N	
0	50'	100'

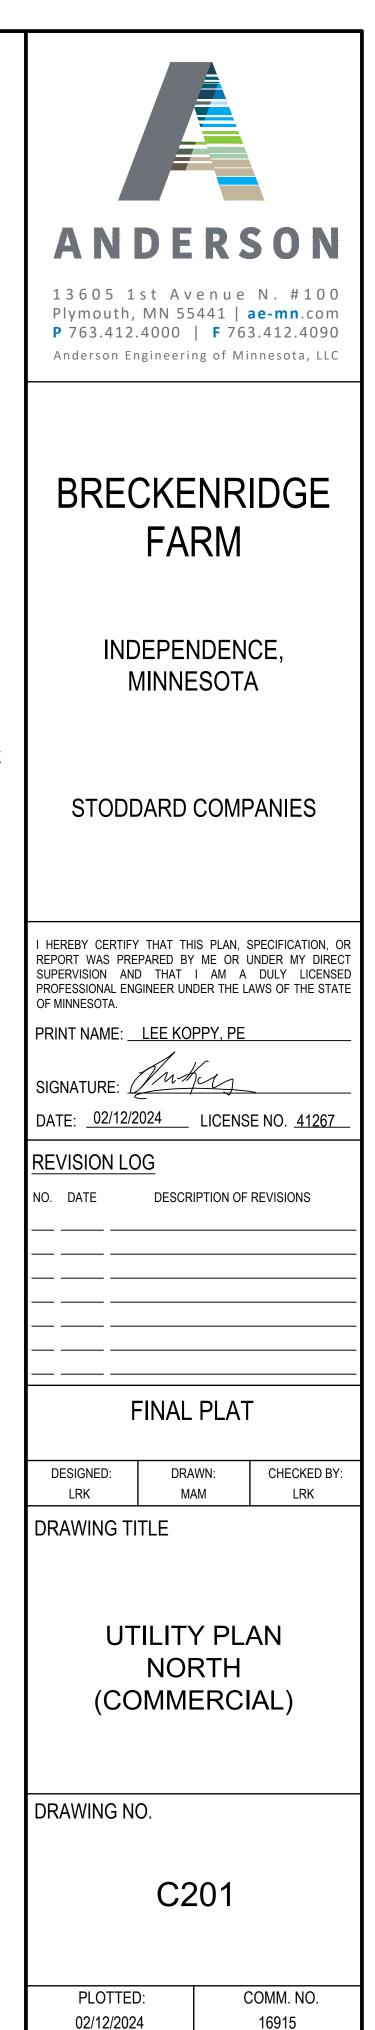

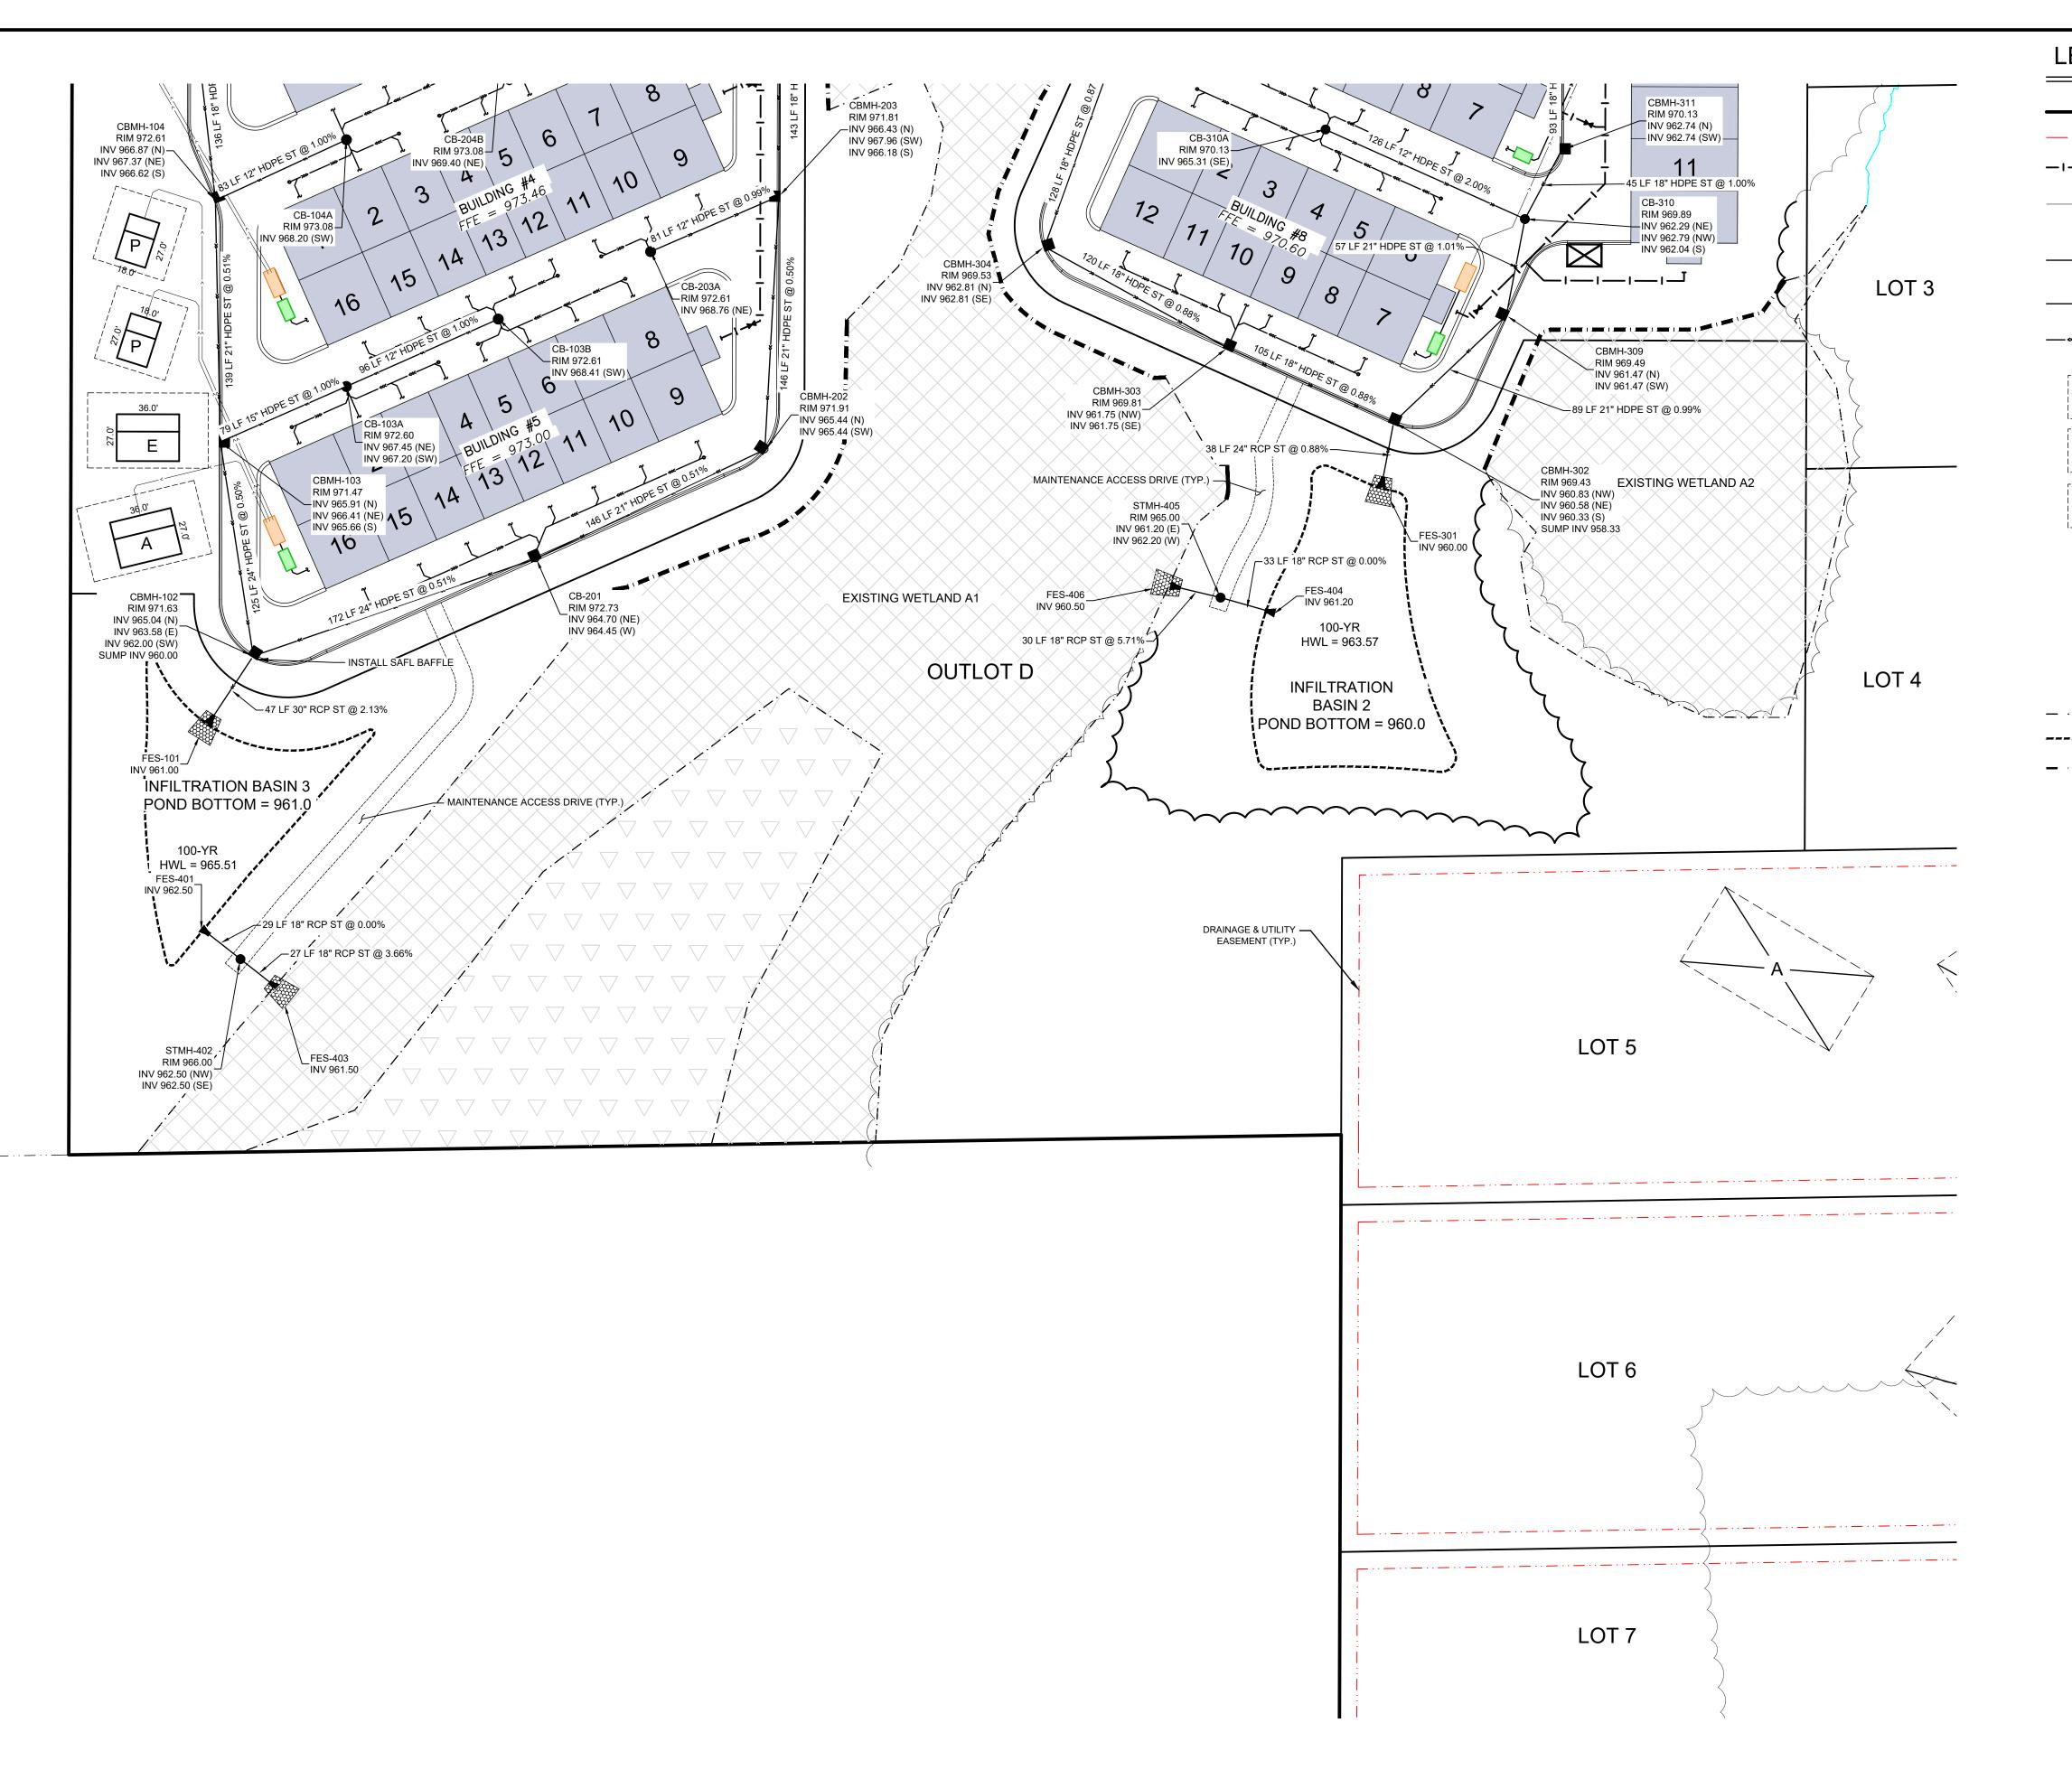

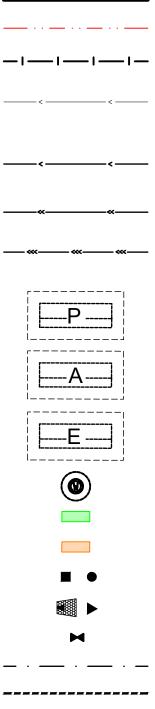

 PROPERTY LIMITS

 DRAINAGE & UTILITY EASEMENT

 PROPOSED WATERMAIN

 PROPOSED SANITARY SEWER

 (PRESSURIZED)

PROPOSED SANITARY SEWER (GRAVITY)

PROPOSED STORM SEWER PROPOSED STORM SEWER (FLOOR DRAIN CONNECTIONS)

PRIMARY SEPTIC DRAIN FIELD

ALTERNATE SEPTIC DRAIN FIELD

EXTRA SEPTIC DRAIN FIELD

PROPOSED WATER WELL
PROPOSED SANITARY SEPTIC TANK
PROPOSED SANITARY PUMP TANK
PROPOSED STORM INLETS
PROPOSED FES
PROPOSED WATERMAIN GATE VALVE
EXISTING WETLAND BOUNDARY
BOTTOM OF INFILTRATION BASIN
WETLAND FILL BOUNDARY



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P 763.412.4000 | F 763.412.4090
Anderson Engineering of Minnesota, LLC

BRECKENRIDGE FARM

INDEPENDENCE, MINNESOTA

STODDARD COMPANIES

I HEREBY CERTIFY THAT THIS PLAN, SPECIFICATION, OR REPORT WAS PREPARED BY ME OR UNDER MY DIRECT SUPERVISION AND THAT I AM A DULY LICENSED PROFESSIONAL ENGINEER UNDER THE LAWS OF THE STATE OF MINNESOTA.

PRINT NAME:	LEE KOPPY, PE

SIGNATURE:

DATE: 02/12/2024 LICENSE NO. 41267


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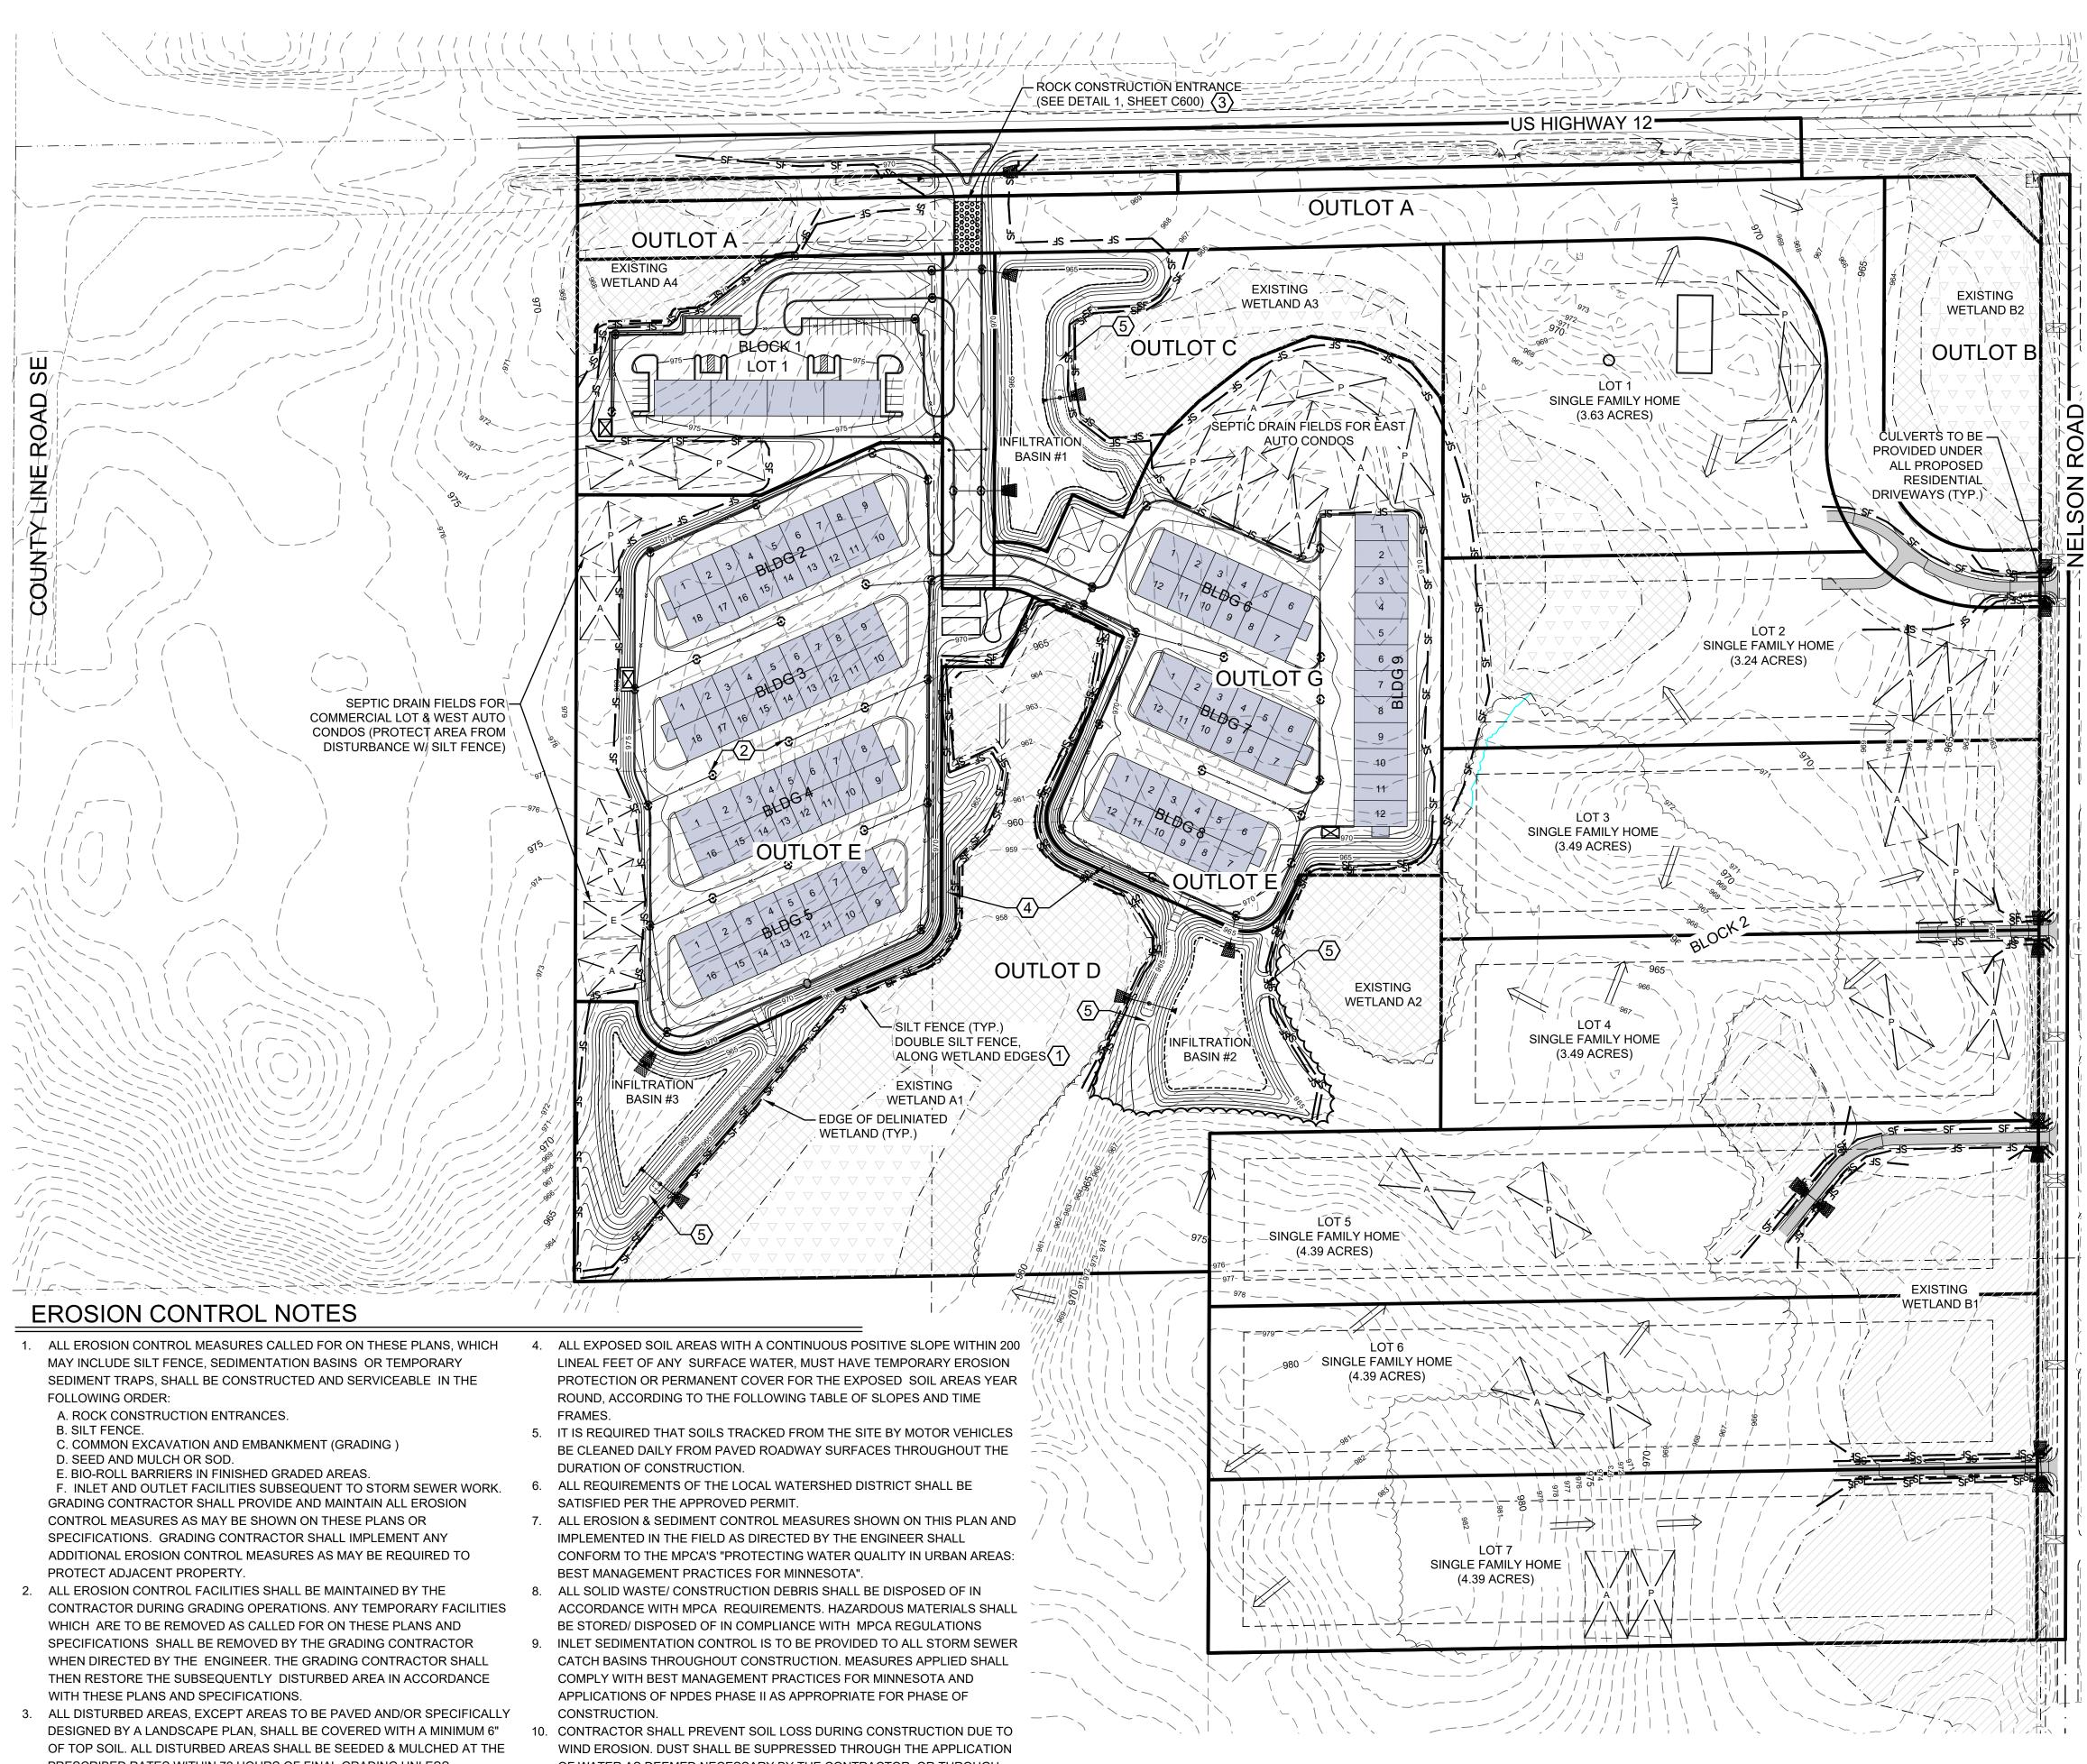
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FINAL PLAT

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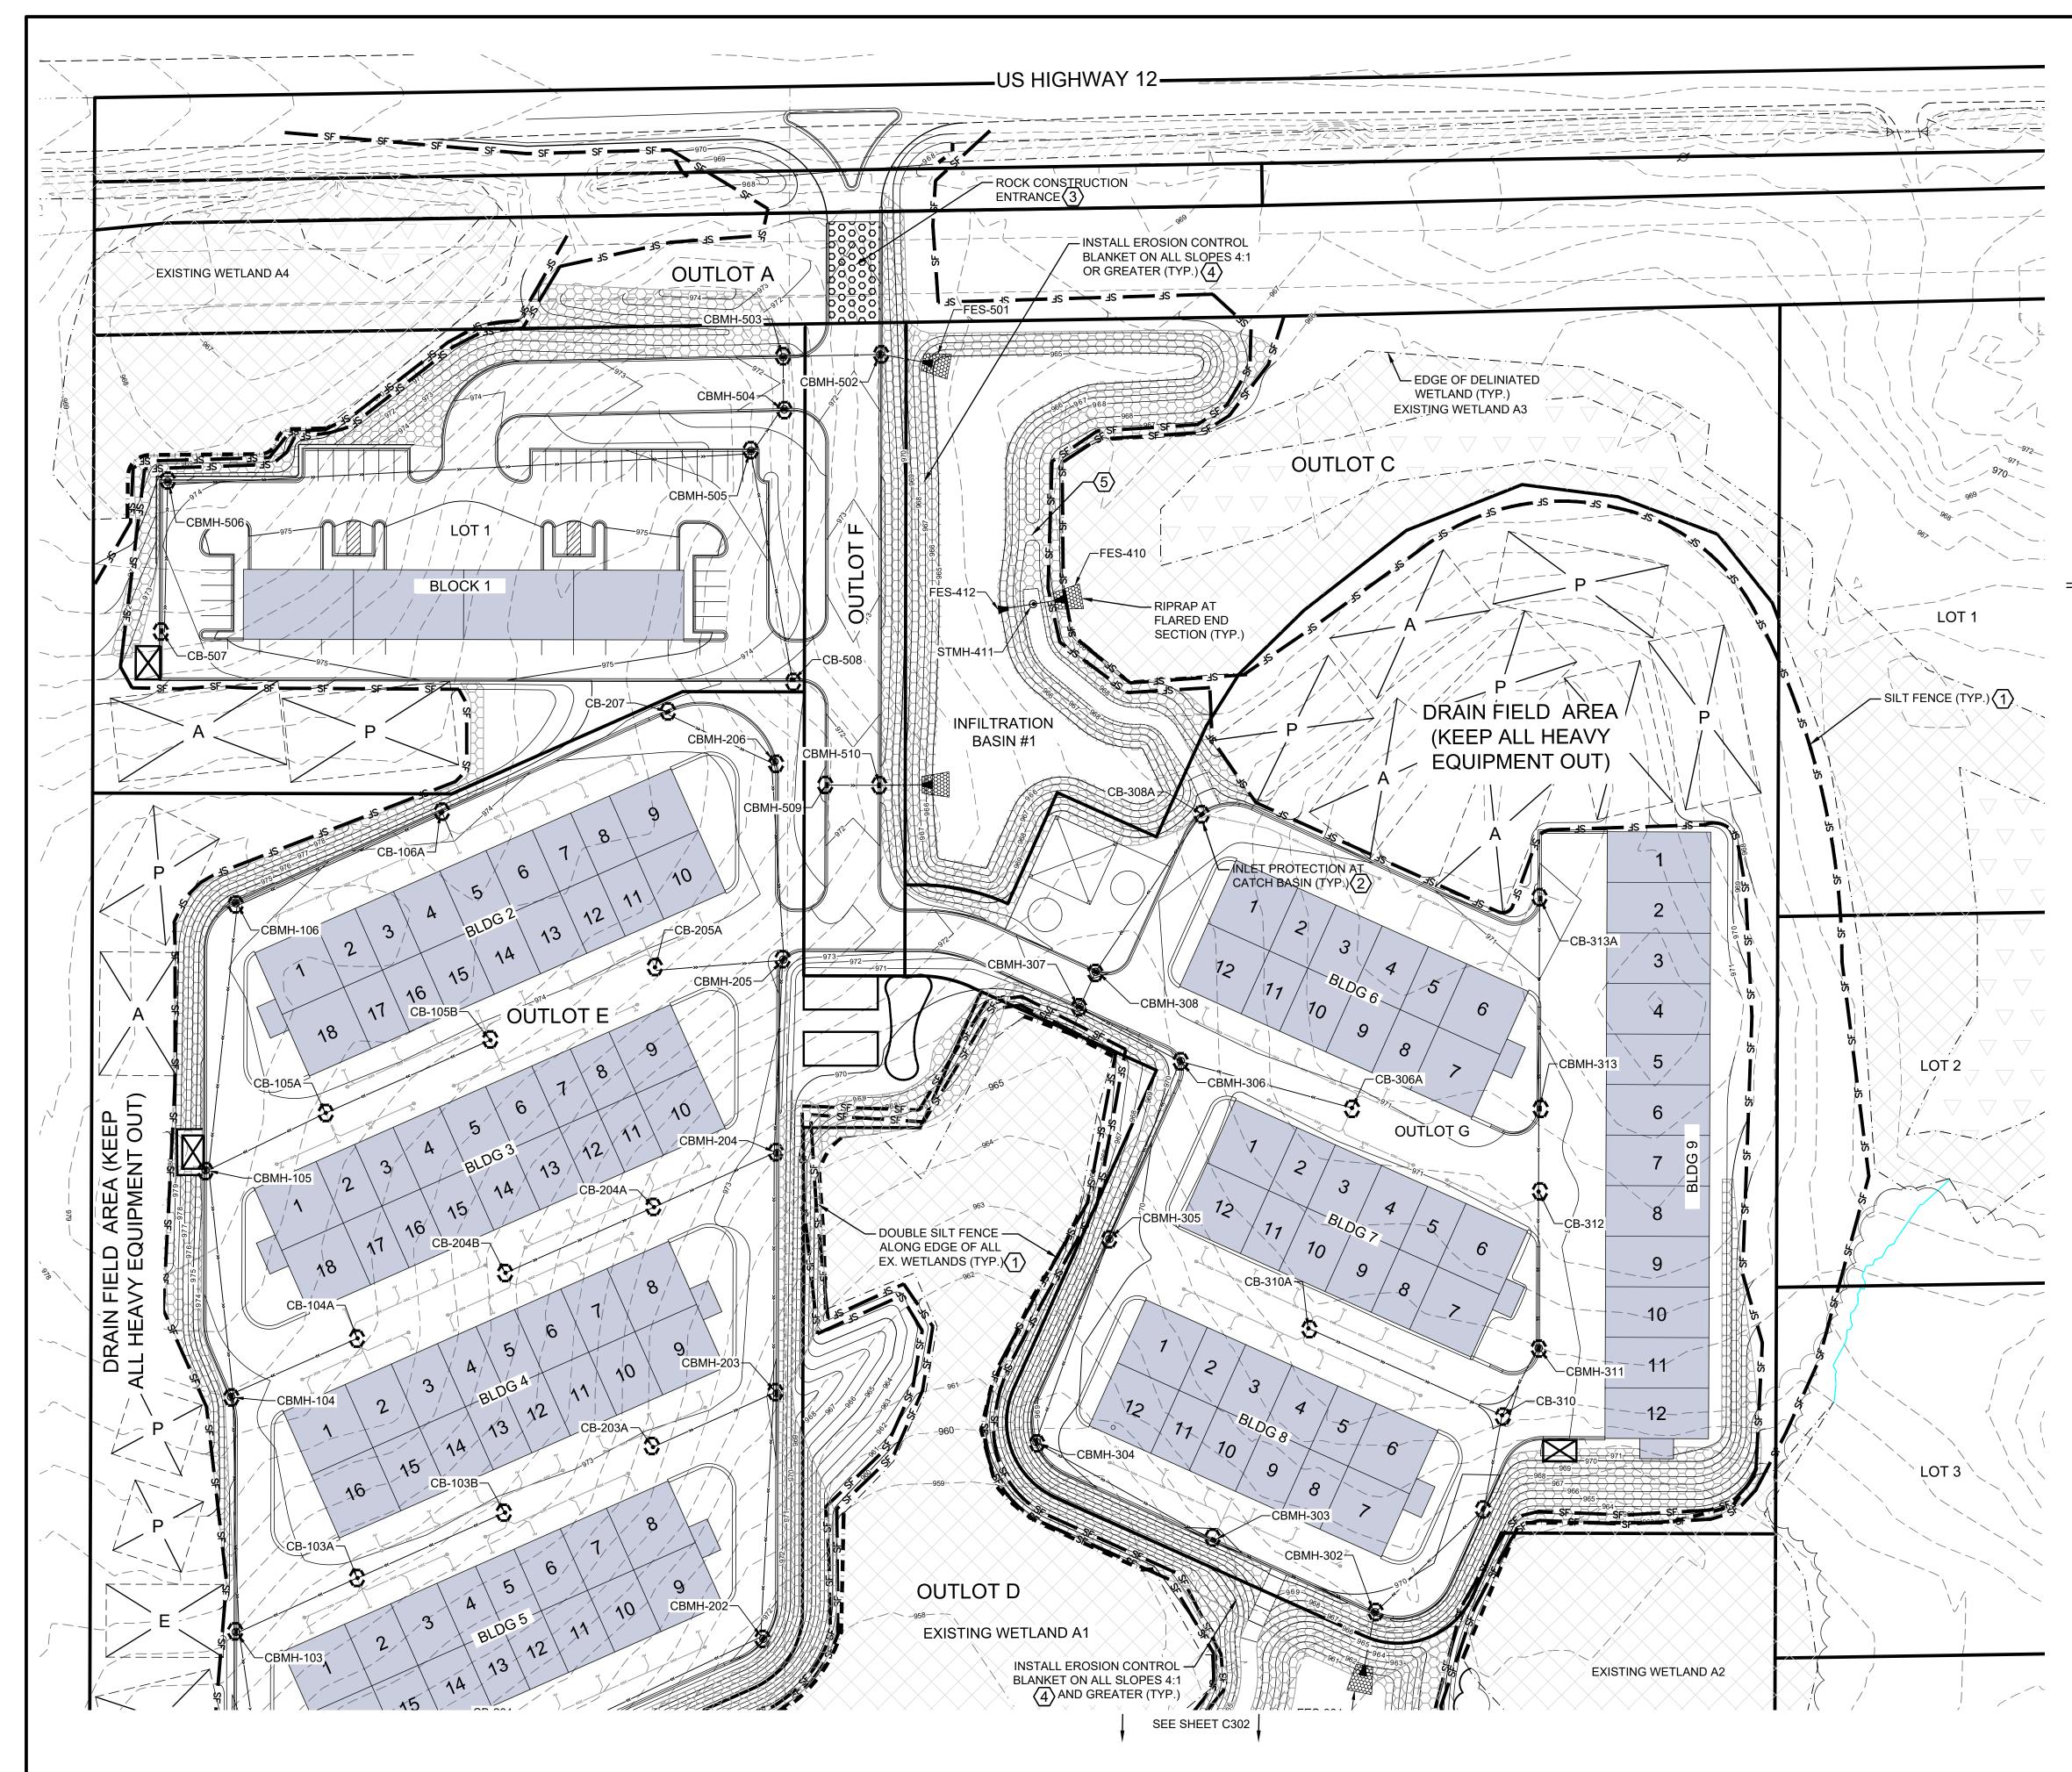


- PRESCRIBED RATES WITHIN 72 HOURS OF FINAL GRADING UNLESS OTHERWISE NOTED.

- OF WATER AS DEEMED NECESSARY BY THE CONTRACTOR, OR THROUGH EQUIVALENT BMP'S AS APPROVED BY THE ENGINEER.

L	EGEND		
	966	PROPERTY LIMITS EXISTING MINOR CONTOUR EXISTING MAJOR CONTOUR PROPOSED MINOR CONTOUR PROPOSED MAJOR CONTOUR EXISTING SPOT ELEVATION DRAINAGE ARROW BIO-ROLL EROSION CONTROL SILT FENCE	A N D E R S O N 13605 1st Avenue N. #100 Plymouth, MN 55441 ae-mn.com P 763.412.4000 F 763.412.4090 Anderson Engineering of Minnesota, LLC
		PROPOSED STORM SEWER INLET PROTECTION RIP-RAP FLARED END ROCK CONSTRUCTION ENTRANCE ALTERNATE AND PRIMARY DRAIN FIELD	BRECKENRIDGE FARM
K	EY NOTES		
(1)	SEDIMENT PR	INTAIN SILT FENCE PERIMETER OTECTION IN TURF AREAS. USE NEEDED IN PAVED AREA. (TYP.)	INDEPENDENCE, MINNESOTA
2	INSTALL & MA PROTECTION	INTAIN INLET SEDIMENT (TYP.)	
3	CONSTRUCTION LOCATION(S) MAINTAINED T	P ROCK ENTRANCE AT ON INGRESS & EGRESS PRIOR TO EXCAVATION & TO BE THROUGHOUT THE ENTIRE ON PROCESS. (SEE DETAIL 1,	STODDARD COMPANIES
4	WITHIN DRAIN EROSION CON INSTALLED. EI BE "NATURAL MNDOT SPEC	SLOPES 4:1 OR STEEPER AND AGE SWALES TO HAVE ITROL BLANKET & SEED ROSION CONTROL BLANKET TO NET ONLY" CATEGORY 3N PER 3885. (TYP.) (SEE DETAIL 4, SEE SHEETS C301 & C302 FOR	I HEREBY CERTIFY THAT THIS PLAN, SPECIFICATION, OR REPORT WAS PREPARED BY ME OR UNDER MY DIRECT SUPERVISION AND THAT I AM A DULY LICENSED PROFESSIONAL ENGINEER UNDER THE LAWS OF THE STATE OF MINNESOTA. PRINT NAME: <u>LEE KOPPY, PE</u> SIGNATURE: MAMM
5	INSTALL RIP-R SPILLWAY.	AP AT EMERGENCY OVERFLOW	DATE: 02/12/2024 LICENSE NO. 41267 REVISION LOG NO. DATE DESCRIPTION OF REVISIONS
			FINAL PLAT
			DESIGNED: DRAWN: CHECKED BY: LRK MAM LRK DRAWING TITLE
			OVERALL EROSION CONTROL PLAN DRAWING NO.
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INLET PROTECTION RIP-RAP FLARED END ENTRANCE WOOD MULCH FIBER BLANKET $A \sim P \sim P$ ALTERNATE AND PRIMARY

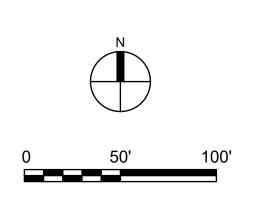KEY NOTES

- $\langle 1 \rangle$ INSTALL & MAINTAIN SILT FENCE PERIMETER SEDIMENT PROTECTION IN TURF AREAS. USE BIO-ROLLS AS NEEDED IN PAVED AREA. (TYP.)
- (2) INSTALL & MAINTAIN INLET SEDIMENT PROTECTION (TYP.)
- $\langle 3 \rangle$ INSTALL TEMP ROCK ENTRANCE OR HARD SURFACE ASPHALT/CONCRETE AT **CONSTRUCTION INGRESS & EGRESS** LOCATION(S) PRIOR TO EXCAVATION & TO BE MAINTAINED THROUGHOUT THE ENTIRE CONSTRUCTION PROCESS.
- $\langle 4 \rangle$ AREAS WITH SLOPES 4:1 OR STEEPER AND WITHIN DRAINAGE SWALES TO HAVE **EROSION CONTROL BLANKET & SEED** INSTALLED. EROSION CONTROL BLANKET TO BE "NATURAL NET ONLY" CATEGORY 3N PER MNDOT SPEC 3885. (TYP.) (SEE DETAIL 4, SHEET C600).
- (5) INSTALL RIP-RAP AT EMERGENCY OVERFLOW SPILLWAY.

ANDERSON
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BRECKENRIDGE FARM
INDEPENDENCE, MINNESOTA
STODDARD COMPANIES
I HEREBY CERTIFY THAT THIS PLAN, SPECIFICATION, OR REPORT WAS PREPARED BY ME OR UNDER MY DIRECT SUPERVISION AND THAT I AM A DULY LICENSED PROFESSIONAL ENGINEER UNDER THE LAWS OF THE STATE OF MINNESOTA. PRINT NAME: <u>LEE KOPPY, PE</u> SIGNATURE: MAM
DATE: <u>02/12/2024</u> LICENSE NO. <u>41267</u>
REVISION LOG
NO. DATE DESCRIPTION OF REVISIONS
FINAL PLAT
DESIGNED: DRAWN: CHECKED BY: LRK MAM LRK DRAWING TITLE
EROSION CONTROL PLAN NORTH (COMMERCIAL)
DRAWING NO.
C301


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WOOD MULCH FIBER BLANKET ALTERNATE AND PRIMARY

KEY NOTES

(1) INSTALL & MAINTAIN SILT FENCE PERIMETER SEDIMENT PROTECTION IN TURF AREAS. USE **BIO-ROLLS AS NEEDED IN PAVED AREA. (TYP.)**

ENTRANCE

- 2 INSTALL & MAINTAIN INLET SEDIMENT PROTECTION (TYP.)
- $\langle 3 \rangle$ INSTALL TEMP ROCK ENTRANCE OR HARD SURFACE ASPHALT/CONCRETE AT **CONSTRUCTION INGRESS & EGRESS** LOCATION(S) PRIOR TO EXCAVATION & TO BE MAINTAINED THROUGHOUT THE ENTIRE CONSTRUCTION PROCESS.
- $\langle 4 \rangle$ AREAS WITH SLOPES 4:1 OR STEEPER AND WITHIN DRAINAGE SWALES TO HAVE EROSION CONTROL BLANKET & SEED INSTALLED. EROSION CONTROL BLANKET TO BE "NATURAL NET ONLY" CATEGORY 3N PER MNDOT SPEC 3885. (TYP.)
- (5) INSTALL RIP-RAP AT EMERGENCY OVERFLOW SPILLWAY.

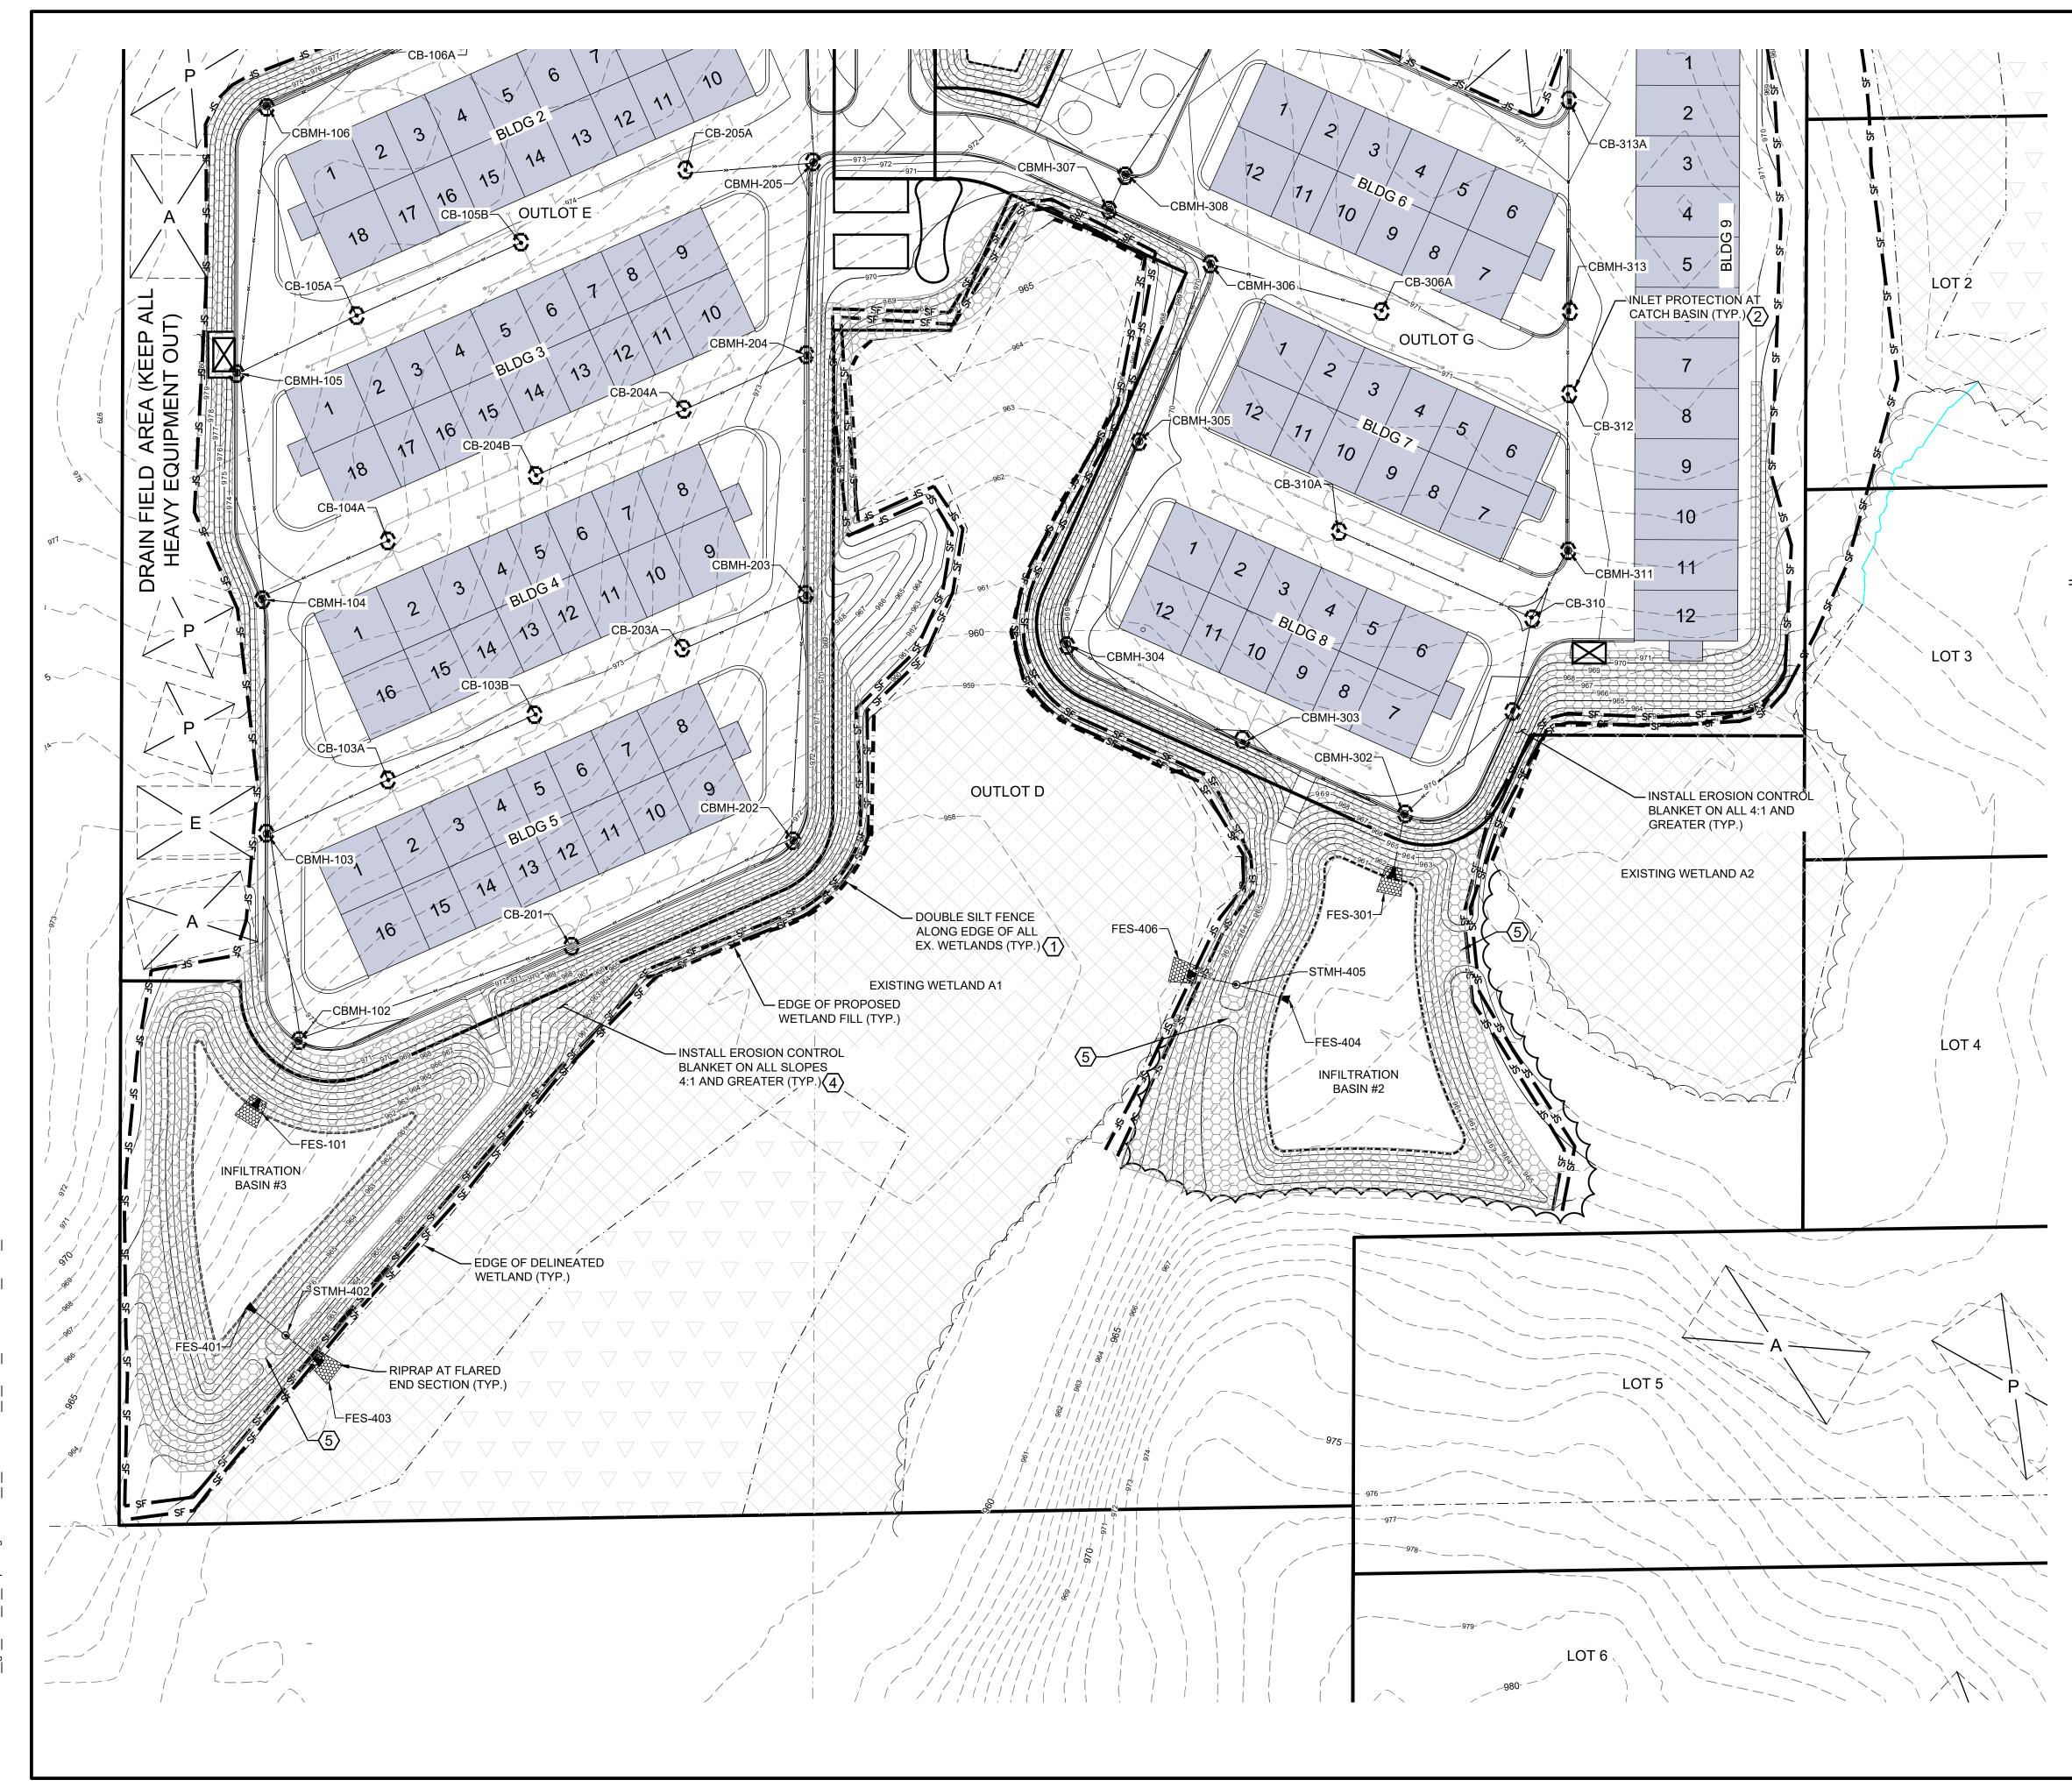A N D E R S O N 13605 1st Avenue N. #100 Plymouth, MN 55441 ae-mn.com P 763.412.4000 F 763.412.4090 Anderson Engineering of Minnesota, LLC
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INDEPENDENCE, MINNESOTA
STODDARD COMPANIES
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SIGNATURE:
REVISION LOG NO. DATE DESCRIPTION OF REVISIONS
FINAL PLAT
DESIGNED: DRAWN: CHECKED BY: LRK MAM LRK DRAWING TITLE
EROSION CONTROL PLAN SOUTH (COMMERCIAL)
DRAWING NO.
C302


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PROPERTY LIMITS WETLAND DELINEATION LINE EDGE OF PROPOSED WETLAND FILL DRAINAGE AND UTILITY EASEMENT EXISTING MINOR CONTOUR EXISTING MAJOR CONTOUR PROPOSED MINOR CONTOUR PROPOSED MAJOR CONTOUR DRAINAGE ARROW PROPOSED CONCRETE C&G SPOT ELEVATION FINISHED FLOOR ELEVATION

RESIDENTIAL DRIVEWAY (CONSTRUCTED WITH THIS PROJECT) POSSIBLE FUTURE DRIVEWAY EXTENSION PRIMARY SEPTIC DRAIN FIELD

ALTERNATE SEPTIC DRAIN FIELD

EXTRA SEPTIC DRAIN FIELD POSSIBLE HOUSE PAD LOCATION


HOUSE PAD LOCATIONS AND DRIVEWAY EXTENSIONS SHOWN ON RESIDENTIAL LOTS 1-7 ARE BASED ON POSSIBLE LOCATIONS FOR FUTURE HOUSE CONSTRUCTION. ACTUAL LOCATIONS MAY VARY.

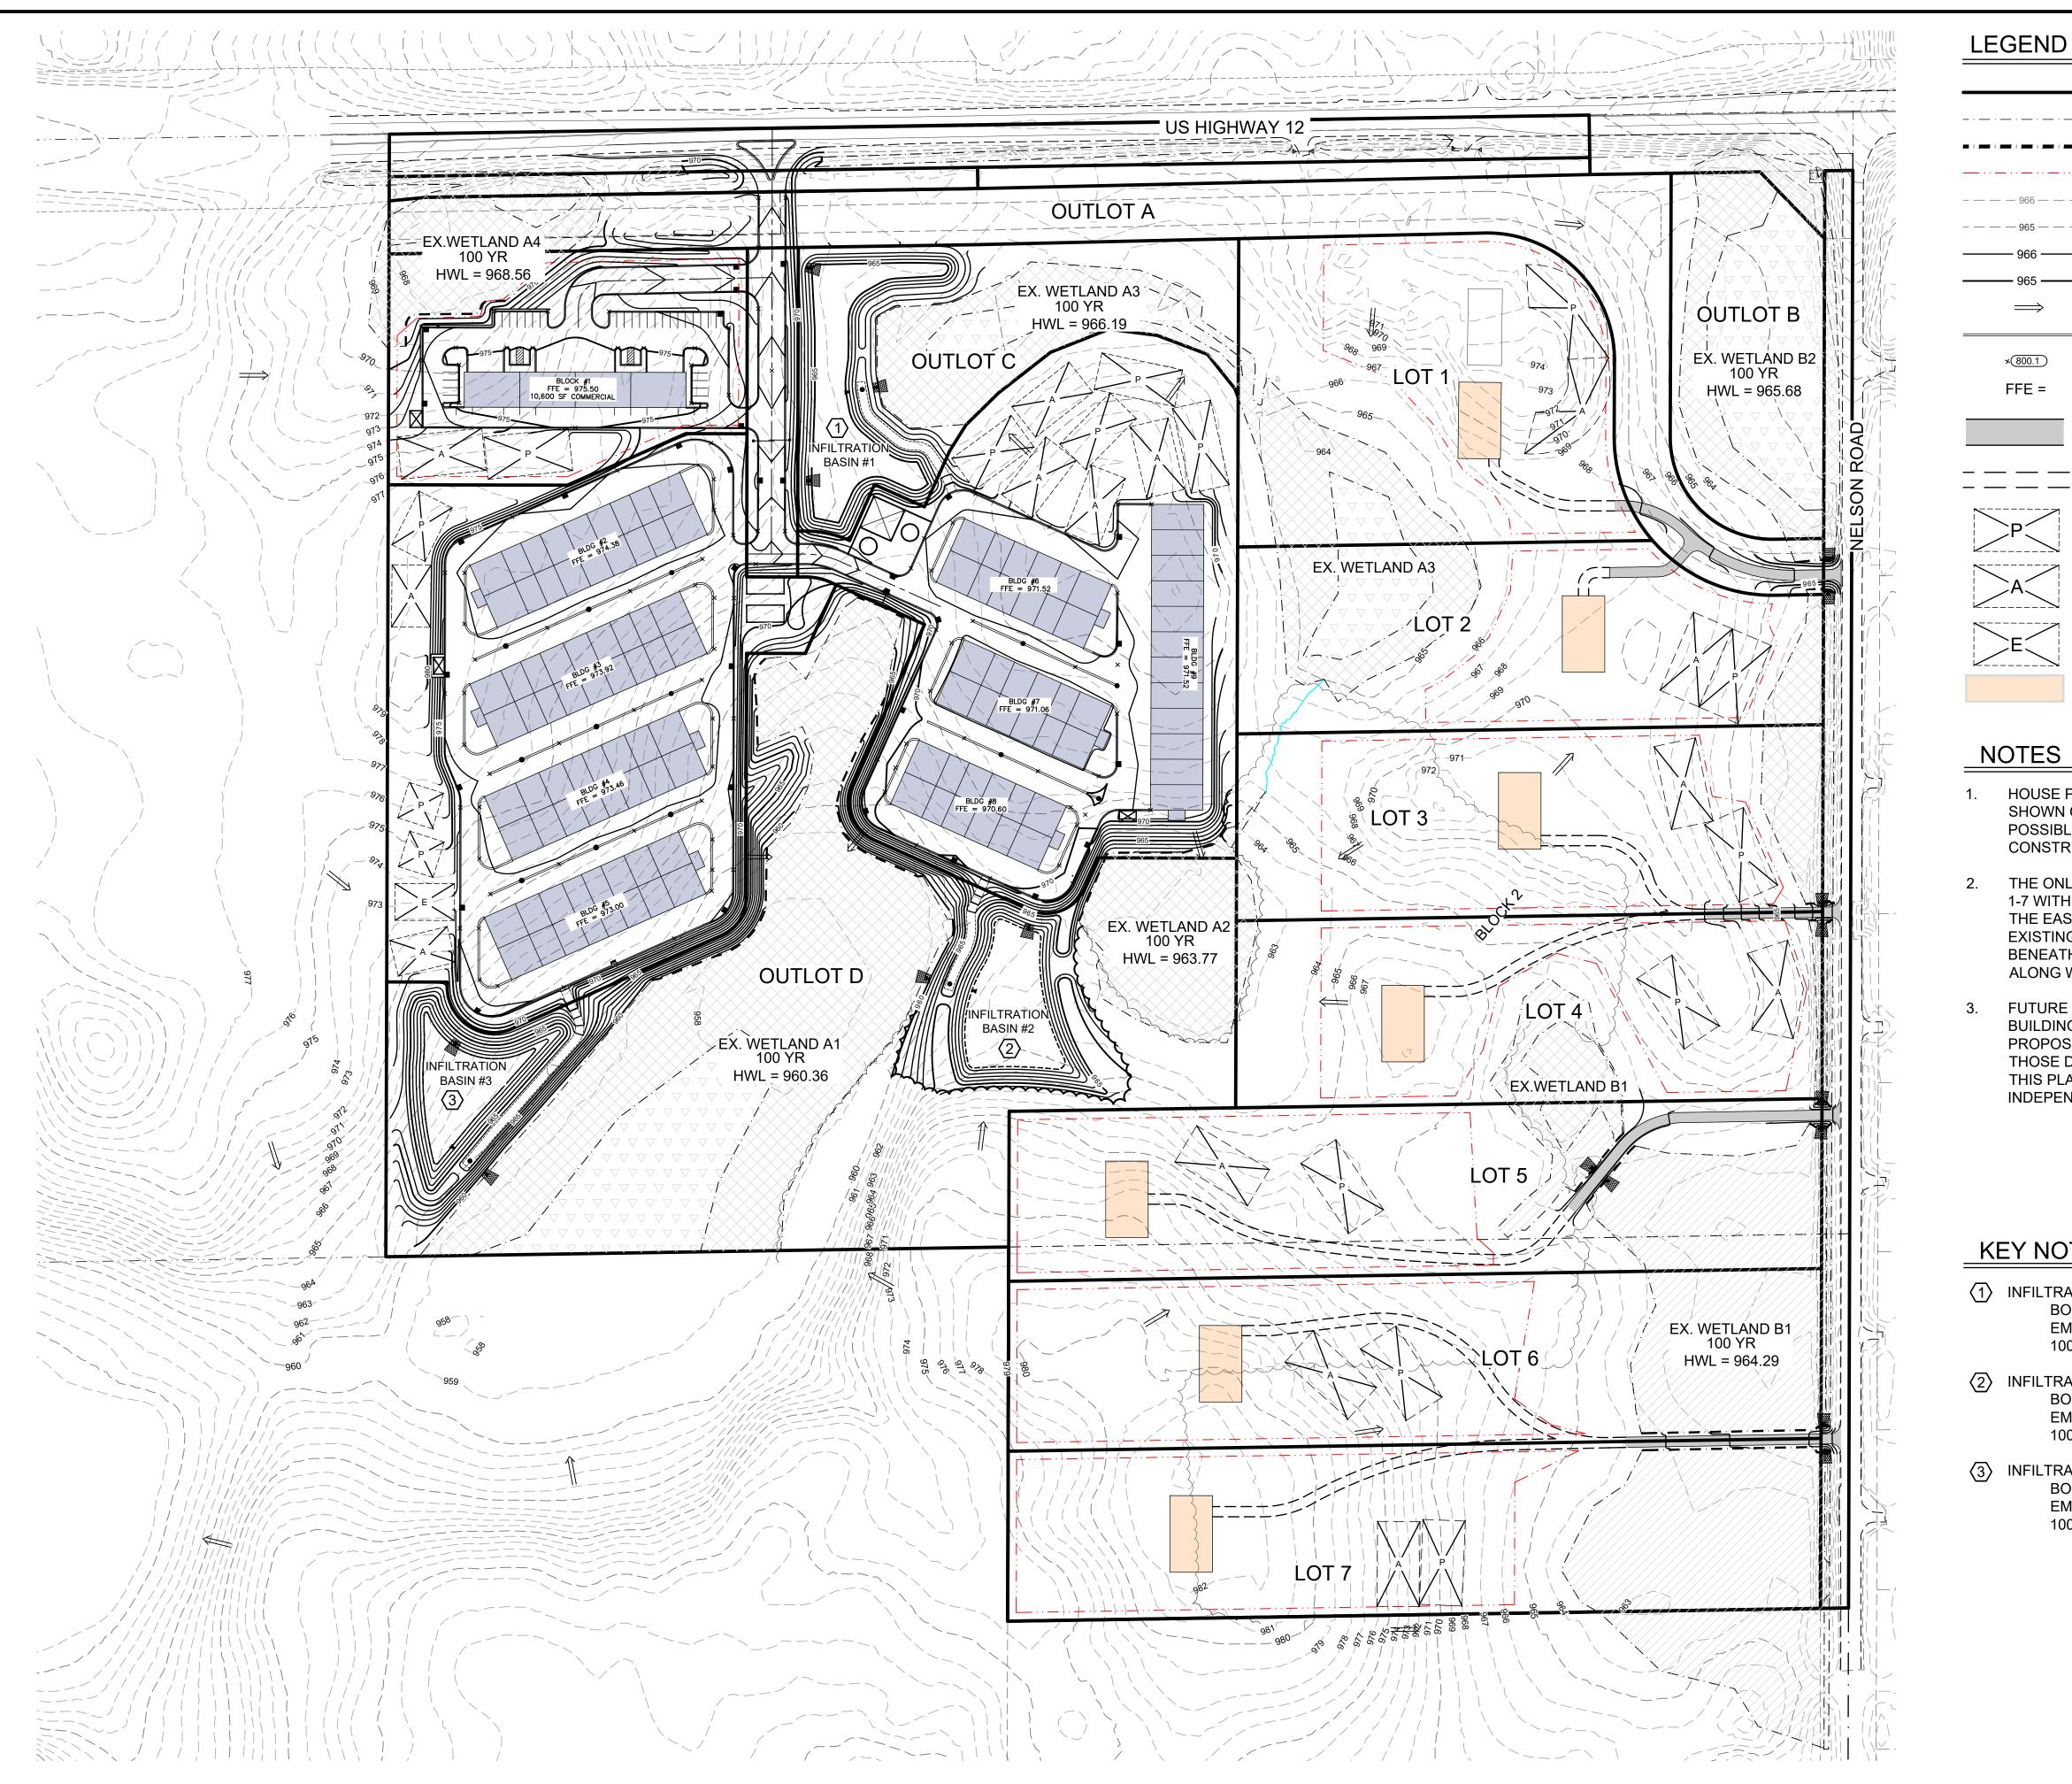THE ONLY WORK PROPOSED ON RESIDENTIAL LOTS 1-7 WITH THIS PROJECT IS THE CONSTRUCTION OF THE EAST END OF THE DRIVEWAYS THROUGH THE EXISTING WETLANDS AND STORM SEWER CULVERTS BENEATH EACH DRIVEWAY TO PRESERVE DITCH FLOW ALONG WEST EDGE OF NELSON ROAD.

FUTURE HOME CONSTRUCTION WILL REQUIRE BUILDING PERMIT REVIEW WITH FINAL DESIGN FOR PROPOSED HOUSE AND DRIVEWAY EXTENSION. THOSE DESIGNS MAY VARY FROM WHAT IS SHOWN ON THIS PLAN, BUT MUST COMPLY WITH CITY OF INDEPENDENCE ORDINANCES.

KEY NOTES


ILTRATION BASIN #1 BOTTOM ELEVATION = 965.00 EMERGENCY OVERFLOW = 967.99 100 YR HWL = 967.49	
ILTRATION BASIN #2 BOTTOM ELEVATION = 960.20 EMERGENCY OVERFLOW = 964.07 100 YR HWL = 963.57	
ILTRATION BASIN #3 BOTTOM ELEVATION = 961.00 EMERGENCY OVERFLOW = 966.01 100 YR HWL = 965.51	
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PLOTTED:

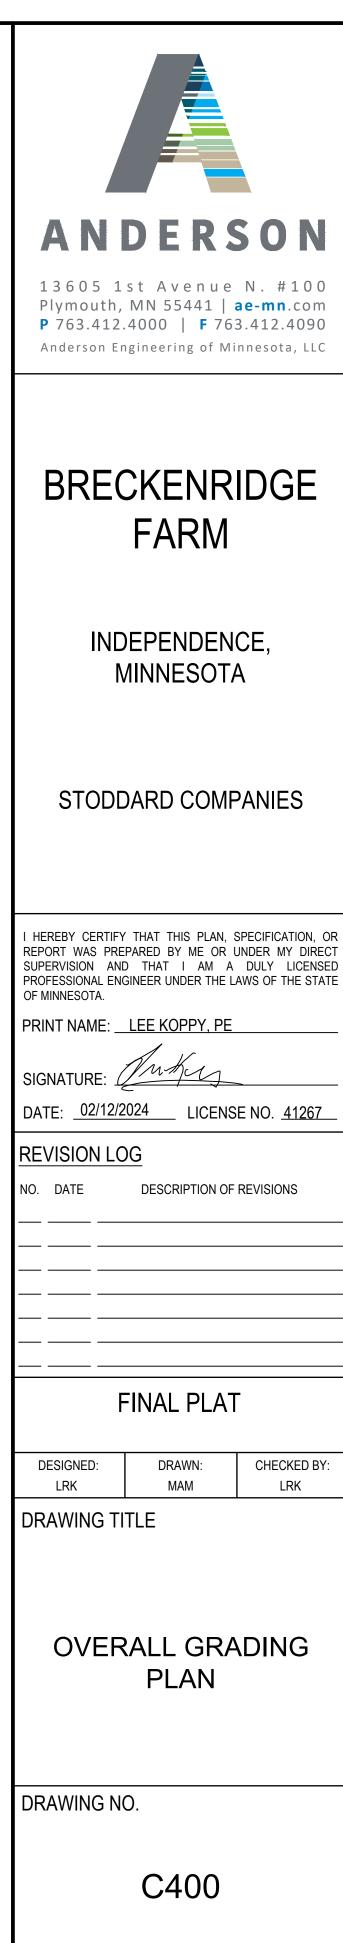02/12/2024

COMM. NO.



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PROPERTY LIMITS WETLAND DELINEATION LINE EDGE OF PROPOSED WETLAND FILL DRAINAGE AND UTILITY EASEMENT EXISTING MINOR CONTOUR EXISTING MAJOR CONTOUR PROPOSED MINOR CONTOUR PROPOSED MAJOR CONTOUR DRAINAGE ARROW PROPOSED CONCRETE C&G SPOT ELEVATION

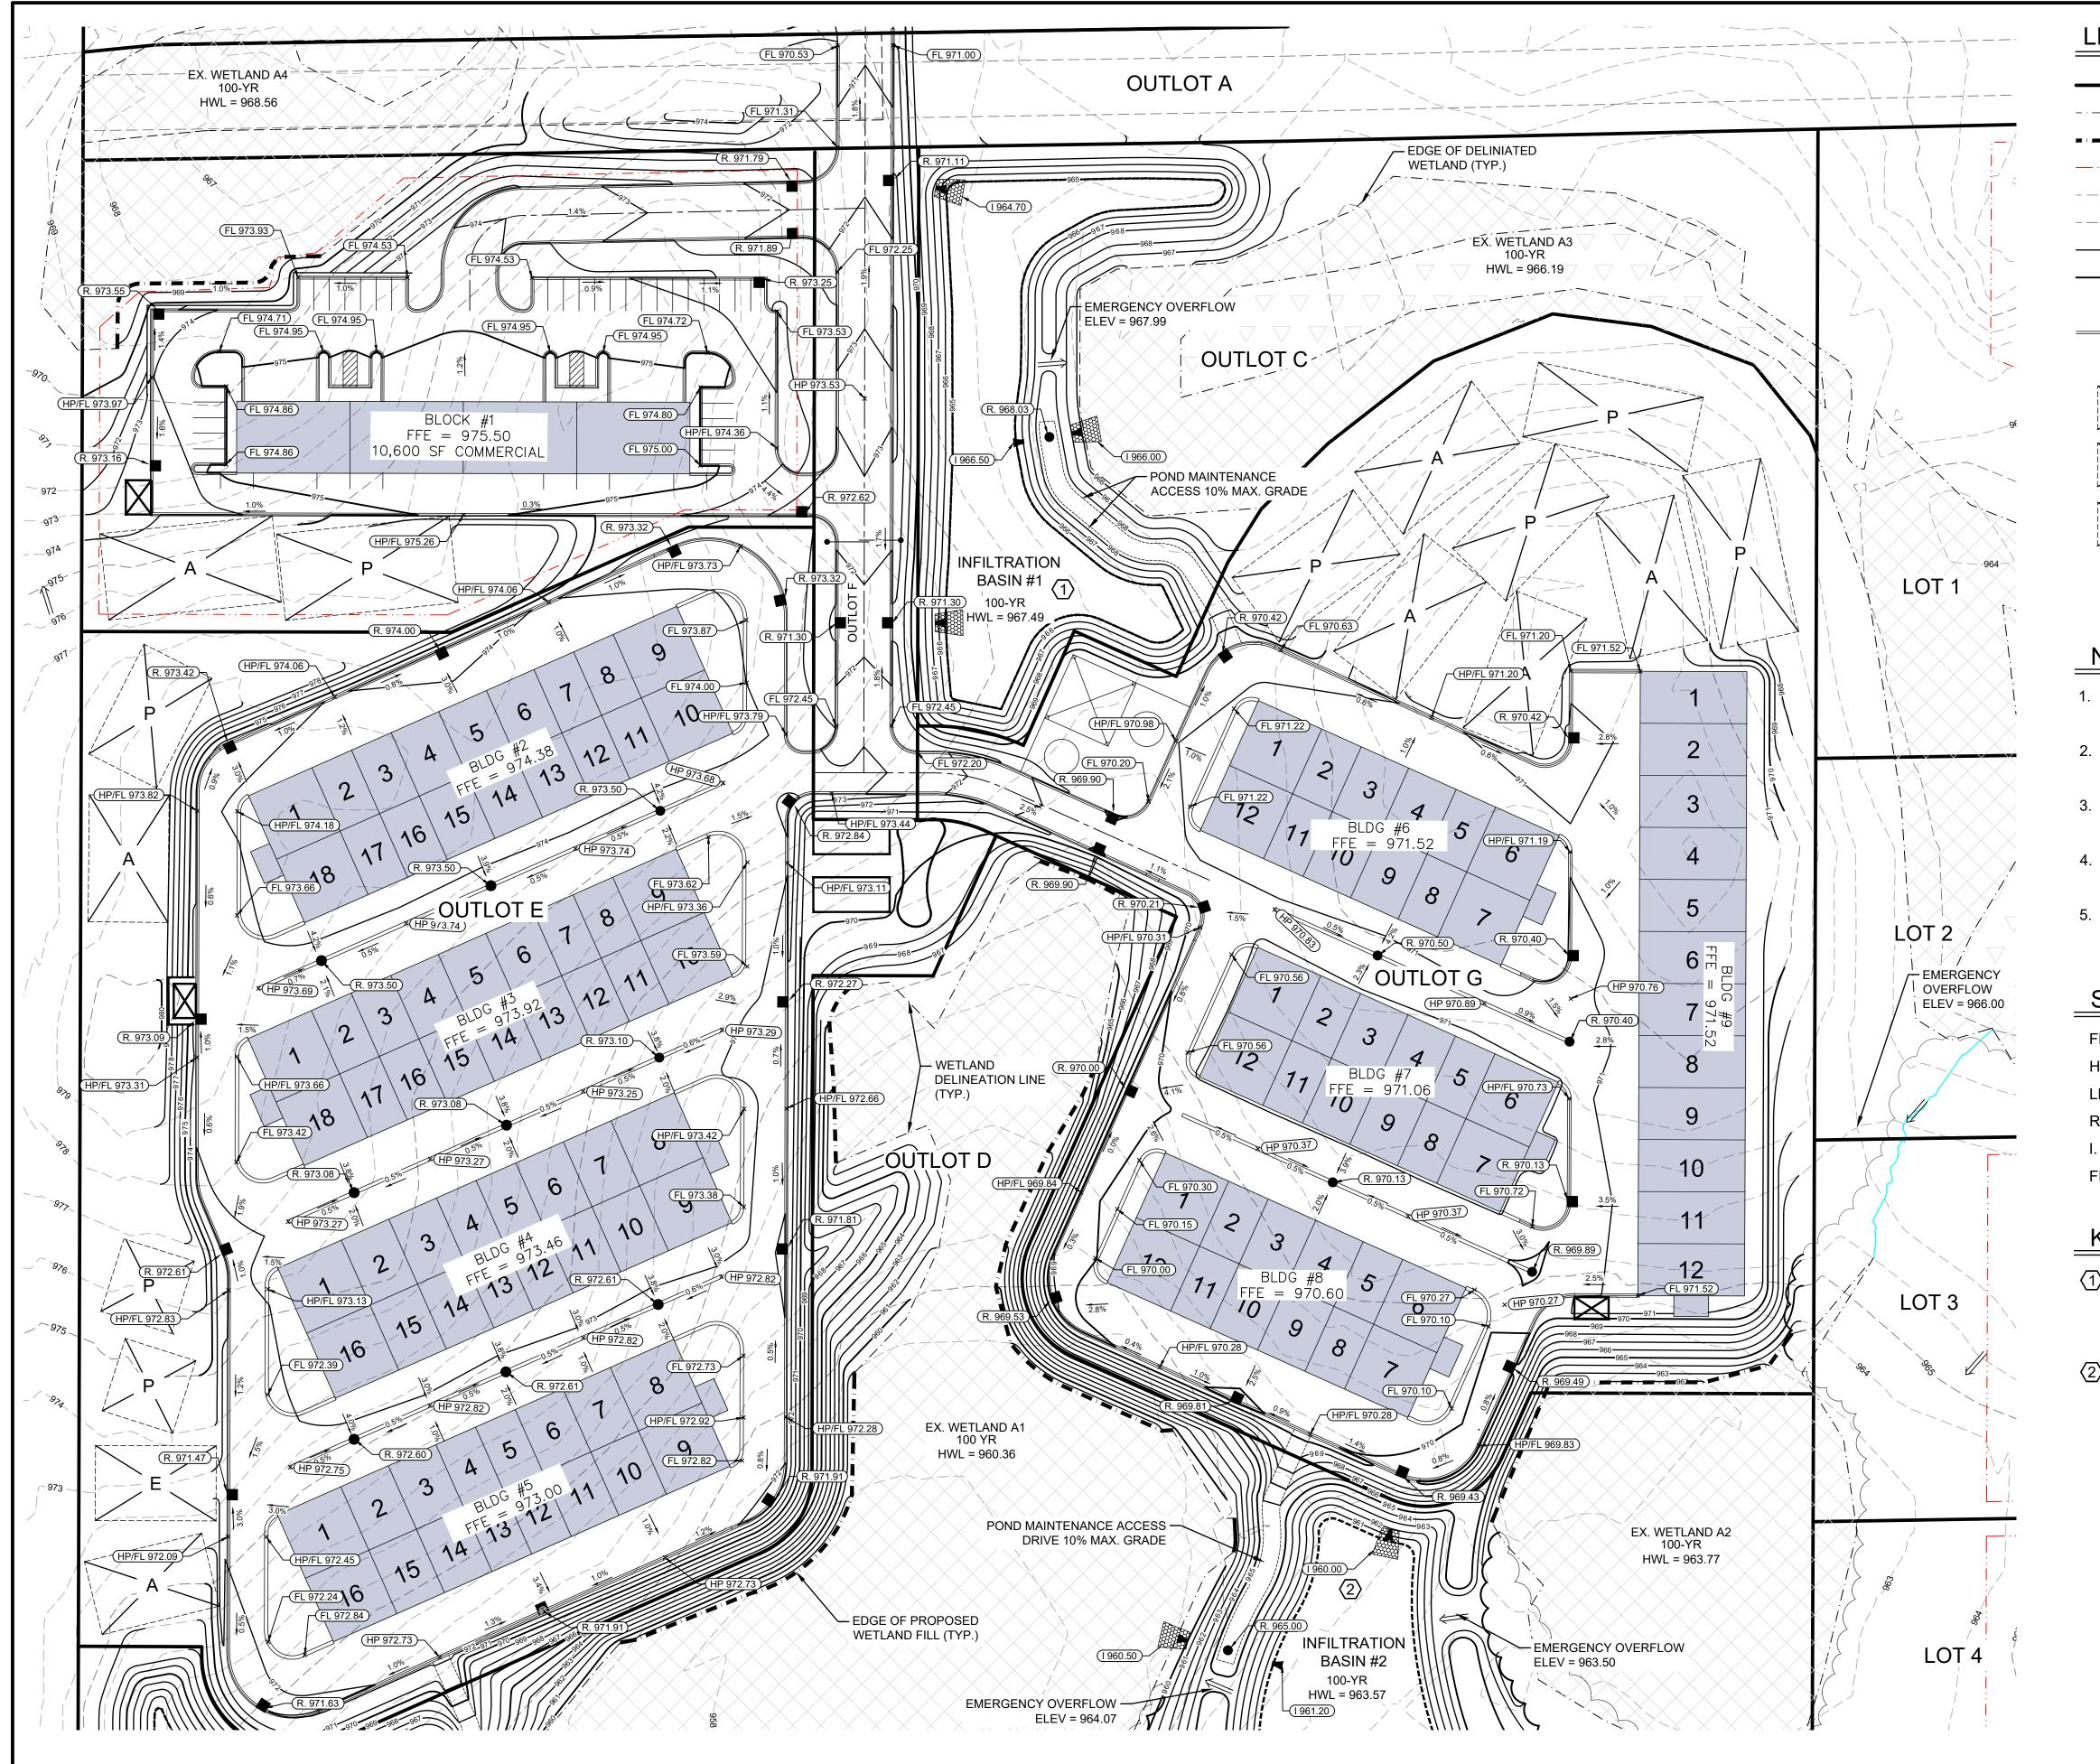PRIMARY SEPTIC DRAIN FIELD

ALTERNATE SEPTIC DRAIN FIELD

EXTRA SEPTIC DRAIN FIELD

NOTES


- ALL DISTURBED AREAS TO BE SEEDED OR SODDED PER LANDSCAPE PLAN.
- PROPOSED CONTOURS AND SPOT ELEVATIONS ARE TO FINISHED GRADE.
- NO GRADED SLOPES SHALL EXCEED 2.5:1 (HOR:VER)
- FINISHED PAVEMENT SHALL BE FLUSH WITH EXISTING ADJACENT PAVEMENT.
- SEE WETLAND MITIGATION PLAN C500 FOR WETLAND IMPACTS, AND SHEETS C501 - C505 FOR WETLAND BUFFER DESIGNATIONS.

SPOT ELEVATION KEY

FL	GUTTER FLOW LINE
HP	HIGH POINT ELEVATION
LP	LOW POINT ELEVATION
R.	RIM ELEVATION
Ι.	INVERT ELEVATION
FFE	FINISHED FLOOR ELEVATION

KEY NOTES

INFILTRATION BASIN #1 BOTTOM ELEVATION = 965.00 EMERGENCY OVERFLOW = 967.99 100 YR HWL = 967.49 INFILTRATION BASIN #2 BOTTOM ELEVATION = 960.20 EMERGENCY OVERFLOW = 964.07 100 YR HWL = 963.57

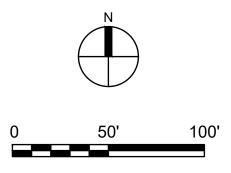



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BRECKENRIDGE FARM

INDEPENDENCE, MINNESOTA

STODDARD COMPANIES

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RINT NAME:	LEE KOPPY, PE

SIGNATURE:

DATE: 02/12/2024 LICENSE NO. 41267


REVISION LOG

NO. DATE DESCRIPTION OF REVISIONS

FINAL PLAT

DESIGNED:	DRAWN:	CHECKED BY:	
LRK	MAM	LRK	
RAWING TI	TLE		
GRADING PLAN NORTH (COMMERCIAL)			
RAWING NO	Э.		
C401			

PLOTTED:	COMM. NO.
02/12/2024	16915

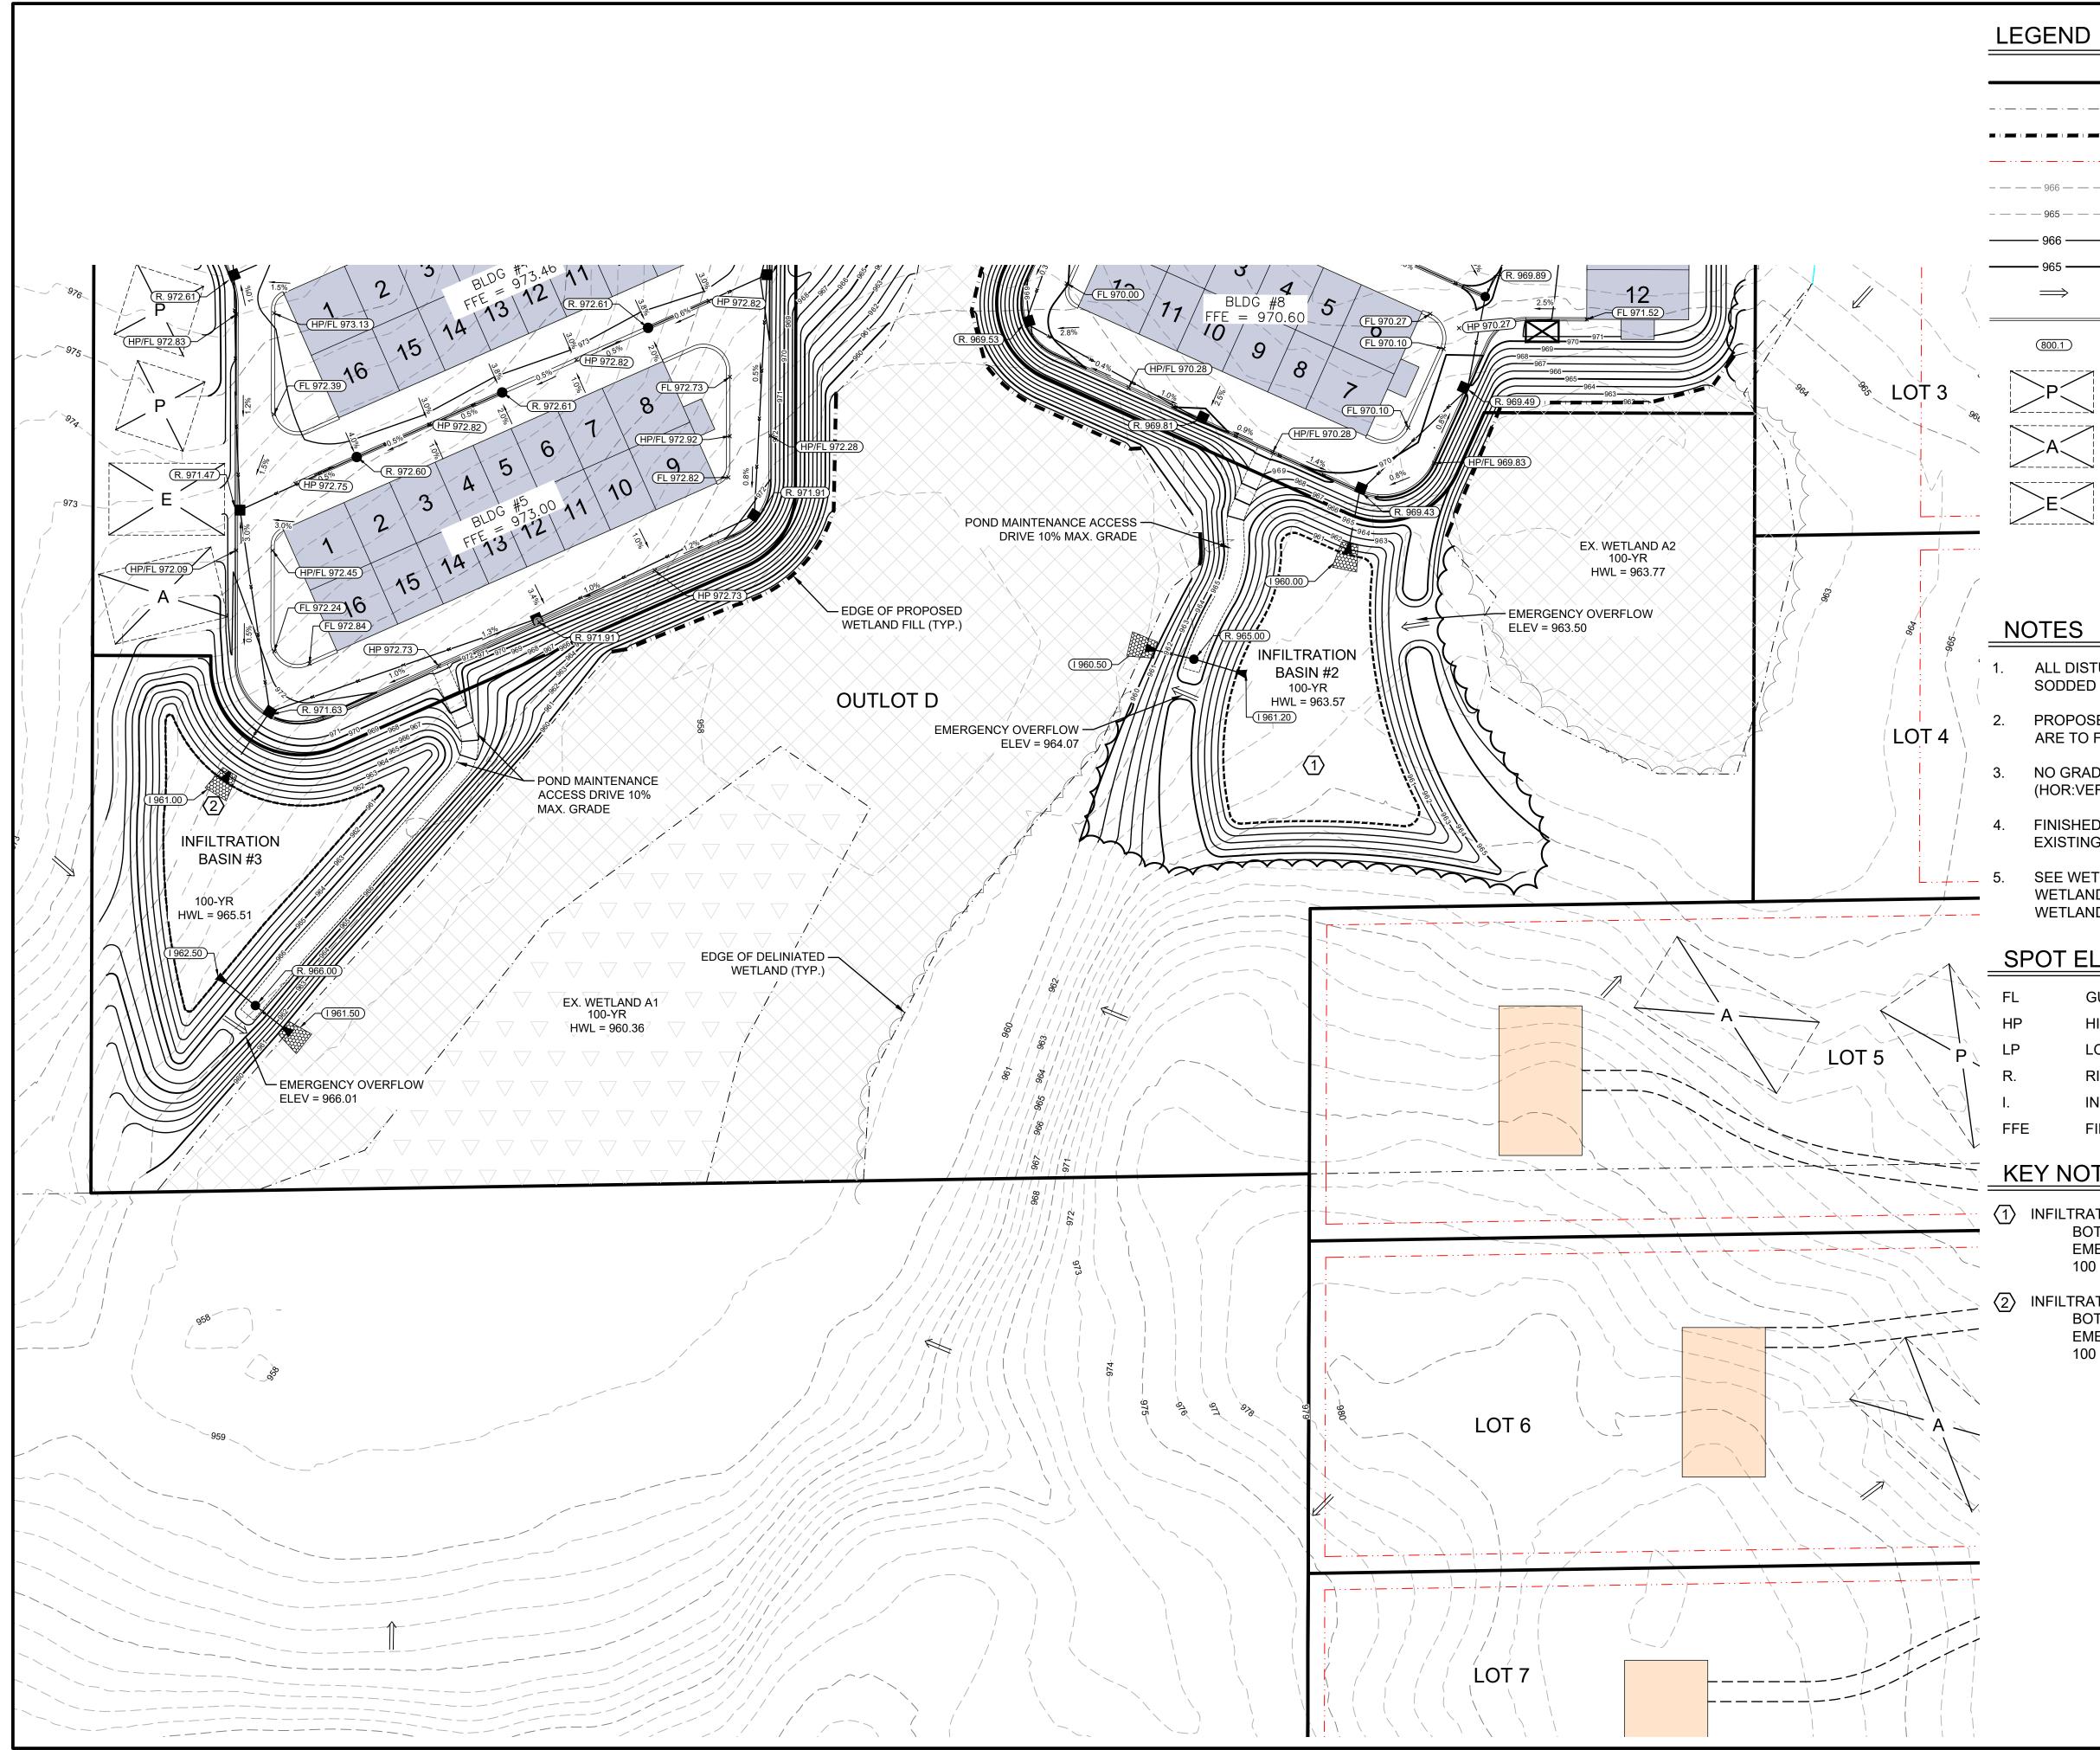

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PROPERTY LIMITS WETLAND DELINEATION LINE EDGE OF PROPOSED WETLAND FILL DRAINAGE AND UTILITY EASEMENT EXISTING MINOR CONTOUR EXISTING MAJOR CONTOUR PROPOSED MINOR CONTOUR PROPOSED MAJOR CONTOUR DRAINAGE ARROW PROPOSED CONCRETE C&G SPOT ELEVATION

PRIMARY SEPTIC DRAIN FIELD

ALTERNATE SEPTIC DRAIN FIELD

EXTRA SEPTIC DRAIN FIELD

- ALL DISTURBED AREAS TO BE SEEDED OR SODDED PER LANDSCAPE PLAN.
- PROPOSED CONTOURS AND SPOT ELEVATIONS ARE TO FINISHED GRADE.
- NO GRADED SLOPES SHALL EXCEED 2.5:1 (HOR:VER)
- FINISHED PAVEMENT SHALL BE FLUSH WITH EXISTING ADJACENT PAVEMENT.
- SEE WETLAND MITIGATION PLAN C500 FOR WETLAND IMPACTS, AND SHEETS C501 - C505 FOR WETLAND BUFFER DESIGNATIONS.


SPOT ELEVATION KEY

FL	GUTTER FLOW LINE
HP	HIGH POINT ELEVATION
LP	LOW POINT ELEVATION
R.	RIM ELEVATION
l.	INVERT ELEVATION
FFE	FINISHED FLOOR ELEVATION

KEY NOTES

1>	INFILTRATION BASIN #2
	BOTTOM ELEVATION = 960.20
	EMERGENCY OVERFLOW = 964.07
	100 YR HWL = 963.57

 $\langle 2 \rangle$ INFILTRATION BASIN #3 BOTTOM ELEVATION = 961.00 EMERGENCY OVERFLOW = 966.01 100 YR HWL = 965.51

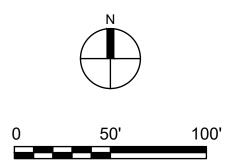



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BRECKENRIDGE FARM

INDEPENDENCE, MINNESOTA

STODDARD COMPANIES

HEREBY CERTIFY THAT THIS PLAN, SPECIFICATION, O REPORT WAS PREPARED BY ME OR UNDER MY DIRECT SUPERVISION AND THAT I AM A DULY LICENSED PROFESSIONAL ENGINEER UNDER THE LAWS OF THE STATE OF MINNESOTA.

	LEE KOPPY,	
PRINT NAME:	$\underline{\text{LEE KUPP1}}$	

SIGNATURE:

DATE: <u>02/12/2024</u> LICENSE NO. <u>41267</u>

REVISION LOG

DESCRIPTION OF REVISIONS NO. DATE

FINAL PLAT


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LRK	MAM	LRK		
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GR	ADING PI	_AN		
SOUTH				
(COMMERCIAL)				
RAWING NO.				
	C402			

COMM. NO.

16915

PLOTTED:

02/12/2024

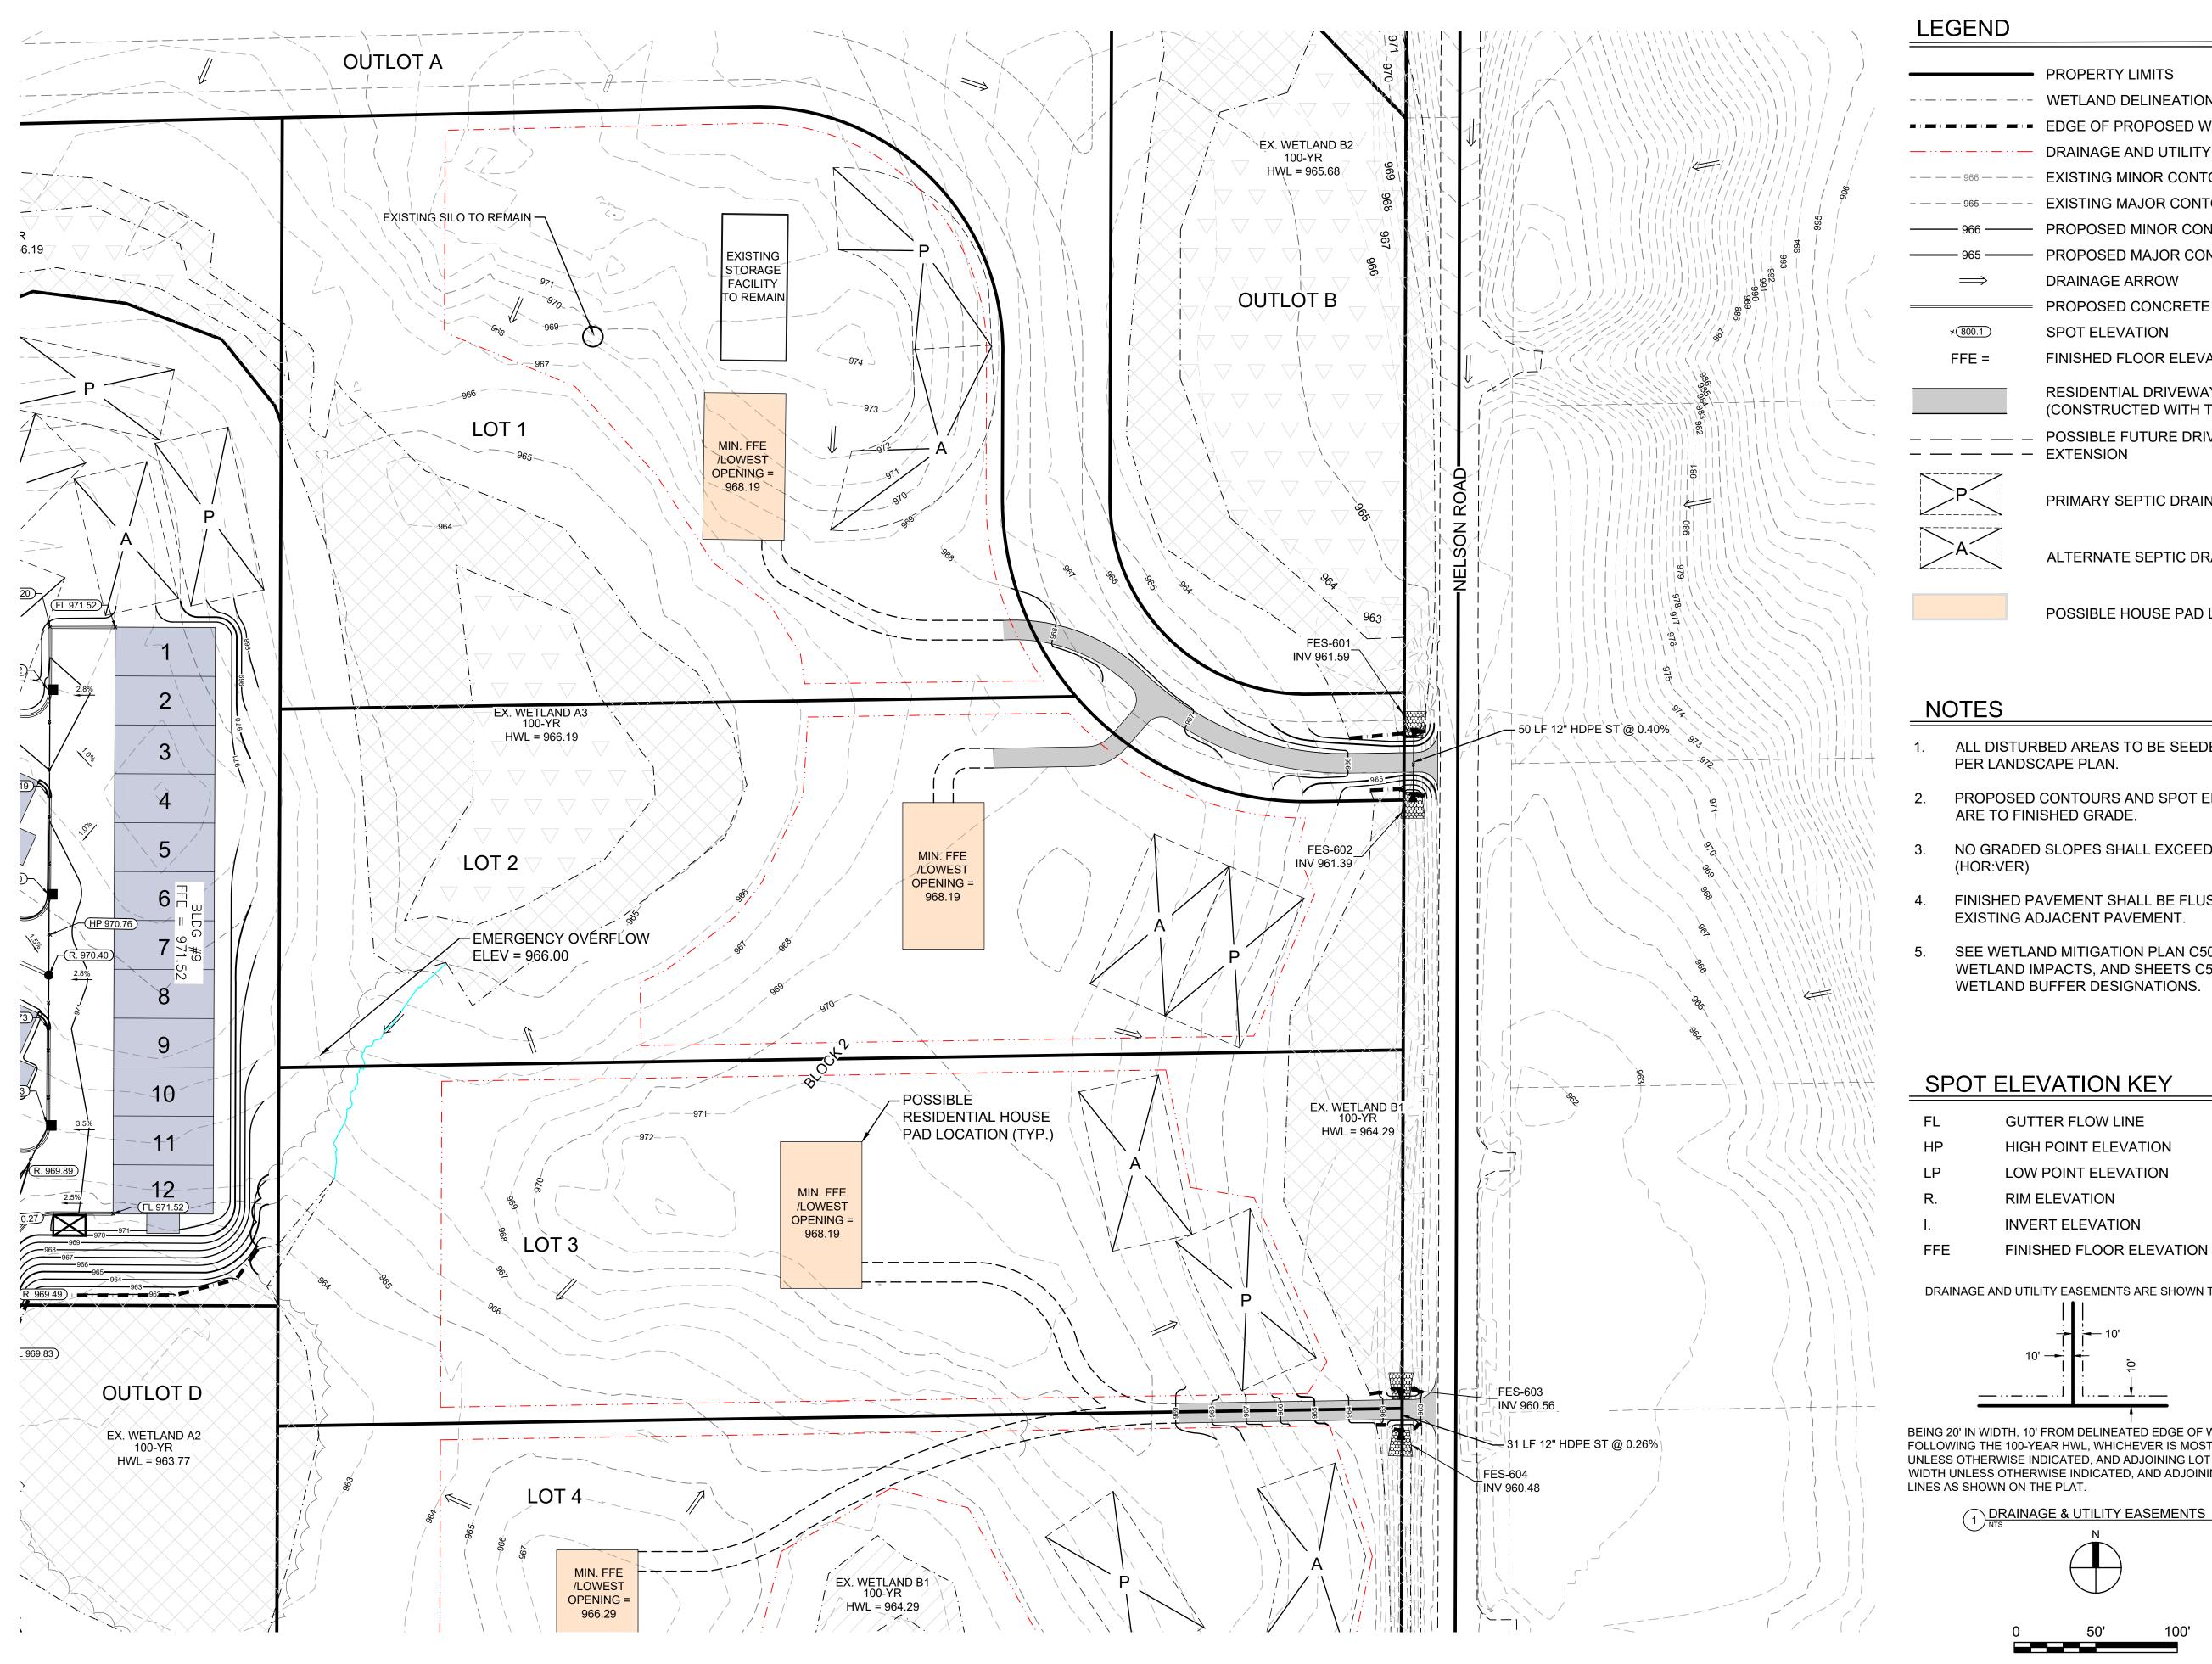

PROPERTY LIMITS WETLAND DELINEATION LINE EDGE OF PROPOSED WETLAND FILL DRAINAGE AND UTILITY EASEMENT **EXISTING MINOR CONTOUR EXISTING MAJOR CONTOUR** — PROPOSED MINOR CONTOUR PROPOSED MAJOR CONTOUR DRAINAGE ARROW PROPOSED CONCRETE C&G SPOT ELEVATION FINISHED FLOOR ELEVATION RESIDENTIAL DRIVEWAY (CONSTRUCTED WITH THIS PROJECT)

POSSIBLE FUTURE DRIVEWAY

PRIMARY SEPTIC DRAIN FIELD

ALTERNATE SEPTIC DRAIN FIELD


POSSIBLE HOUSE PAD LOCATION

- ALL DISTURBED AREAS TO BE SEEDED OR SODDED
- PROPOSED CONTOURS AND SPOT ELEVATIONS
- NO GRADED SLOPES SHALL EXCEED 2.5:1
- 4. FINISHED PAVEMENT SHALL BE FLUSH WITH EXISTING ADJACENT PAVEMENT.
 - SEE WETLAND MITIGATION PLAN C500 FOR WETLAND IMPACTS, AND SHEETS C501 - C505 FOR WETLAND BUFFER DESIGNATIONS.

HIGH POINT ELEVATION LOW POINT ELEVATION FINISHED FLOOR ELEVATION

DRAINAGE AND UTILITY EASEMENTS ARE SHOWN THUS:

BEING 20' IN WIDTH, 10' FROM DELINEATED EDGE OF WETLAND, OR FOLLOWING THE 100-YEAR HWL, WHICHEVER IS MOST RESTRICTIVE, UNLESS OTHERWISE INDICATED, AND ADJOINING LOT LINES, AND 10' IN WIDTH UNLESS OTHERWISE INDICATED, AND ADJOINING RIGHT-OF-WAY

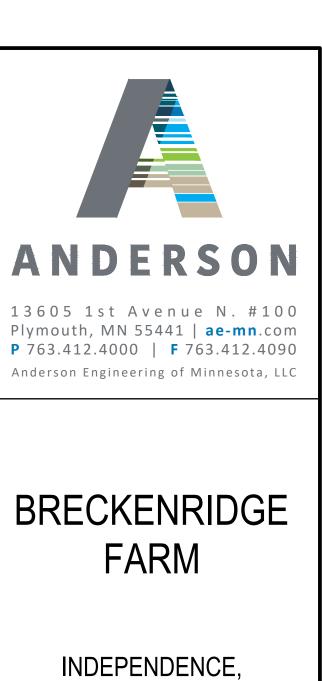

MINNESOTA	
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STODDARD COMPANIES

HEREBY CERTIFY THAT THIS PLAN, SPECIFICATION, C REPORT WAS PREPARED BY ME OR UNDER MY DIRECT SUPERVISION AND THAT I AM A DULY LICENSED PROFESSIONAL ENGINEER UNDER THE LAWS OF THE STATE OF MINNESOTA.

LEE KOPPY,	PF
$_$ LLL KOFF I,	

may SIGNATURE:

DATE: <u>02/12/2024</u> LICENSE NO. <u>41267</u>

REVISION LOG

DESCRIPTION OF REVISIONS NO. DATE


FINAL PLAT

DESIGNED:	DRAWN:	CHECKED BY:		
LRK	MAM	LRK		
DRAWING TITLE				
GRADING PLAN NORTH (RESIDENTIAL)				
DRAWING NO.				

C403

PLOTTED: 02/12/2024

COMM. NO.
16915

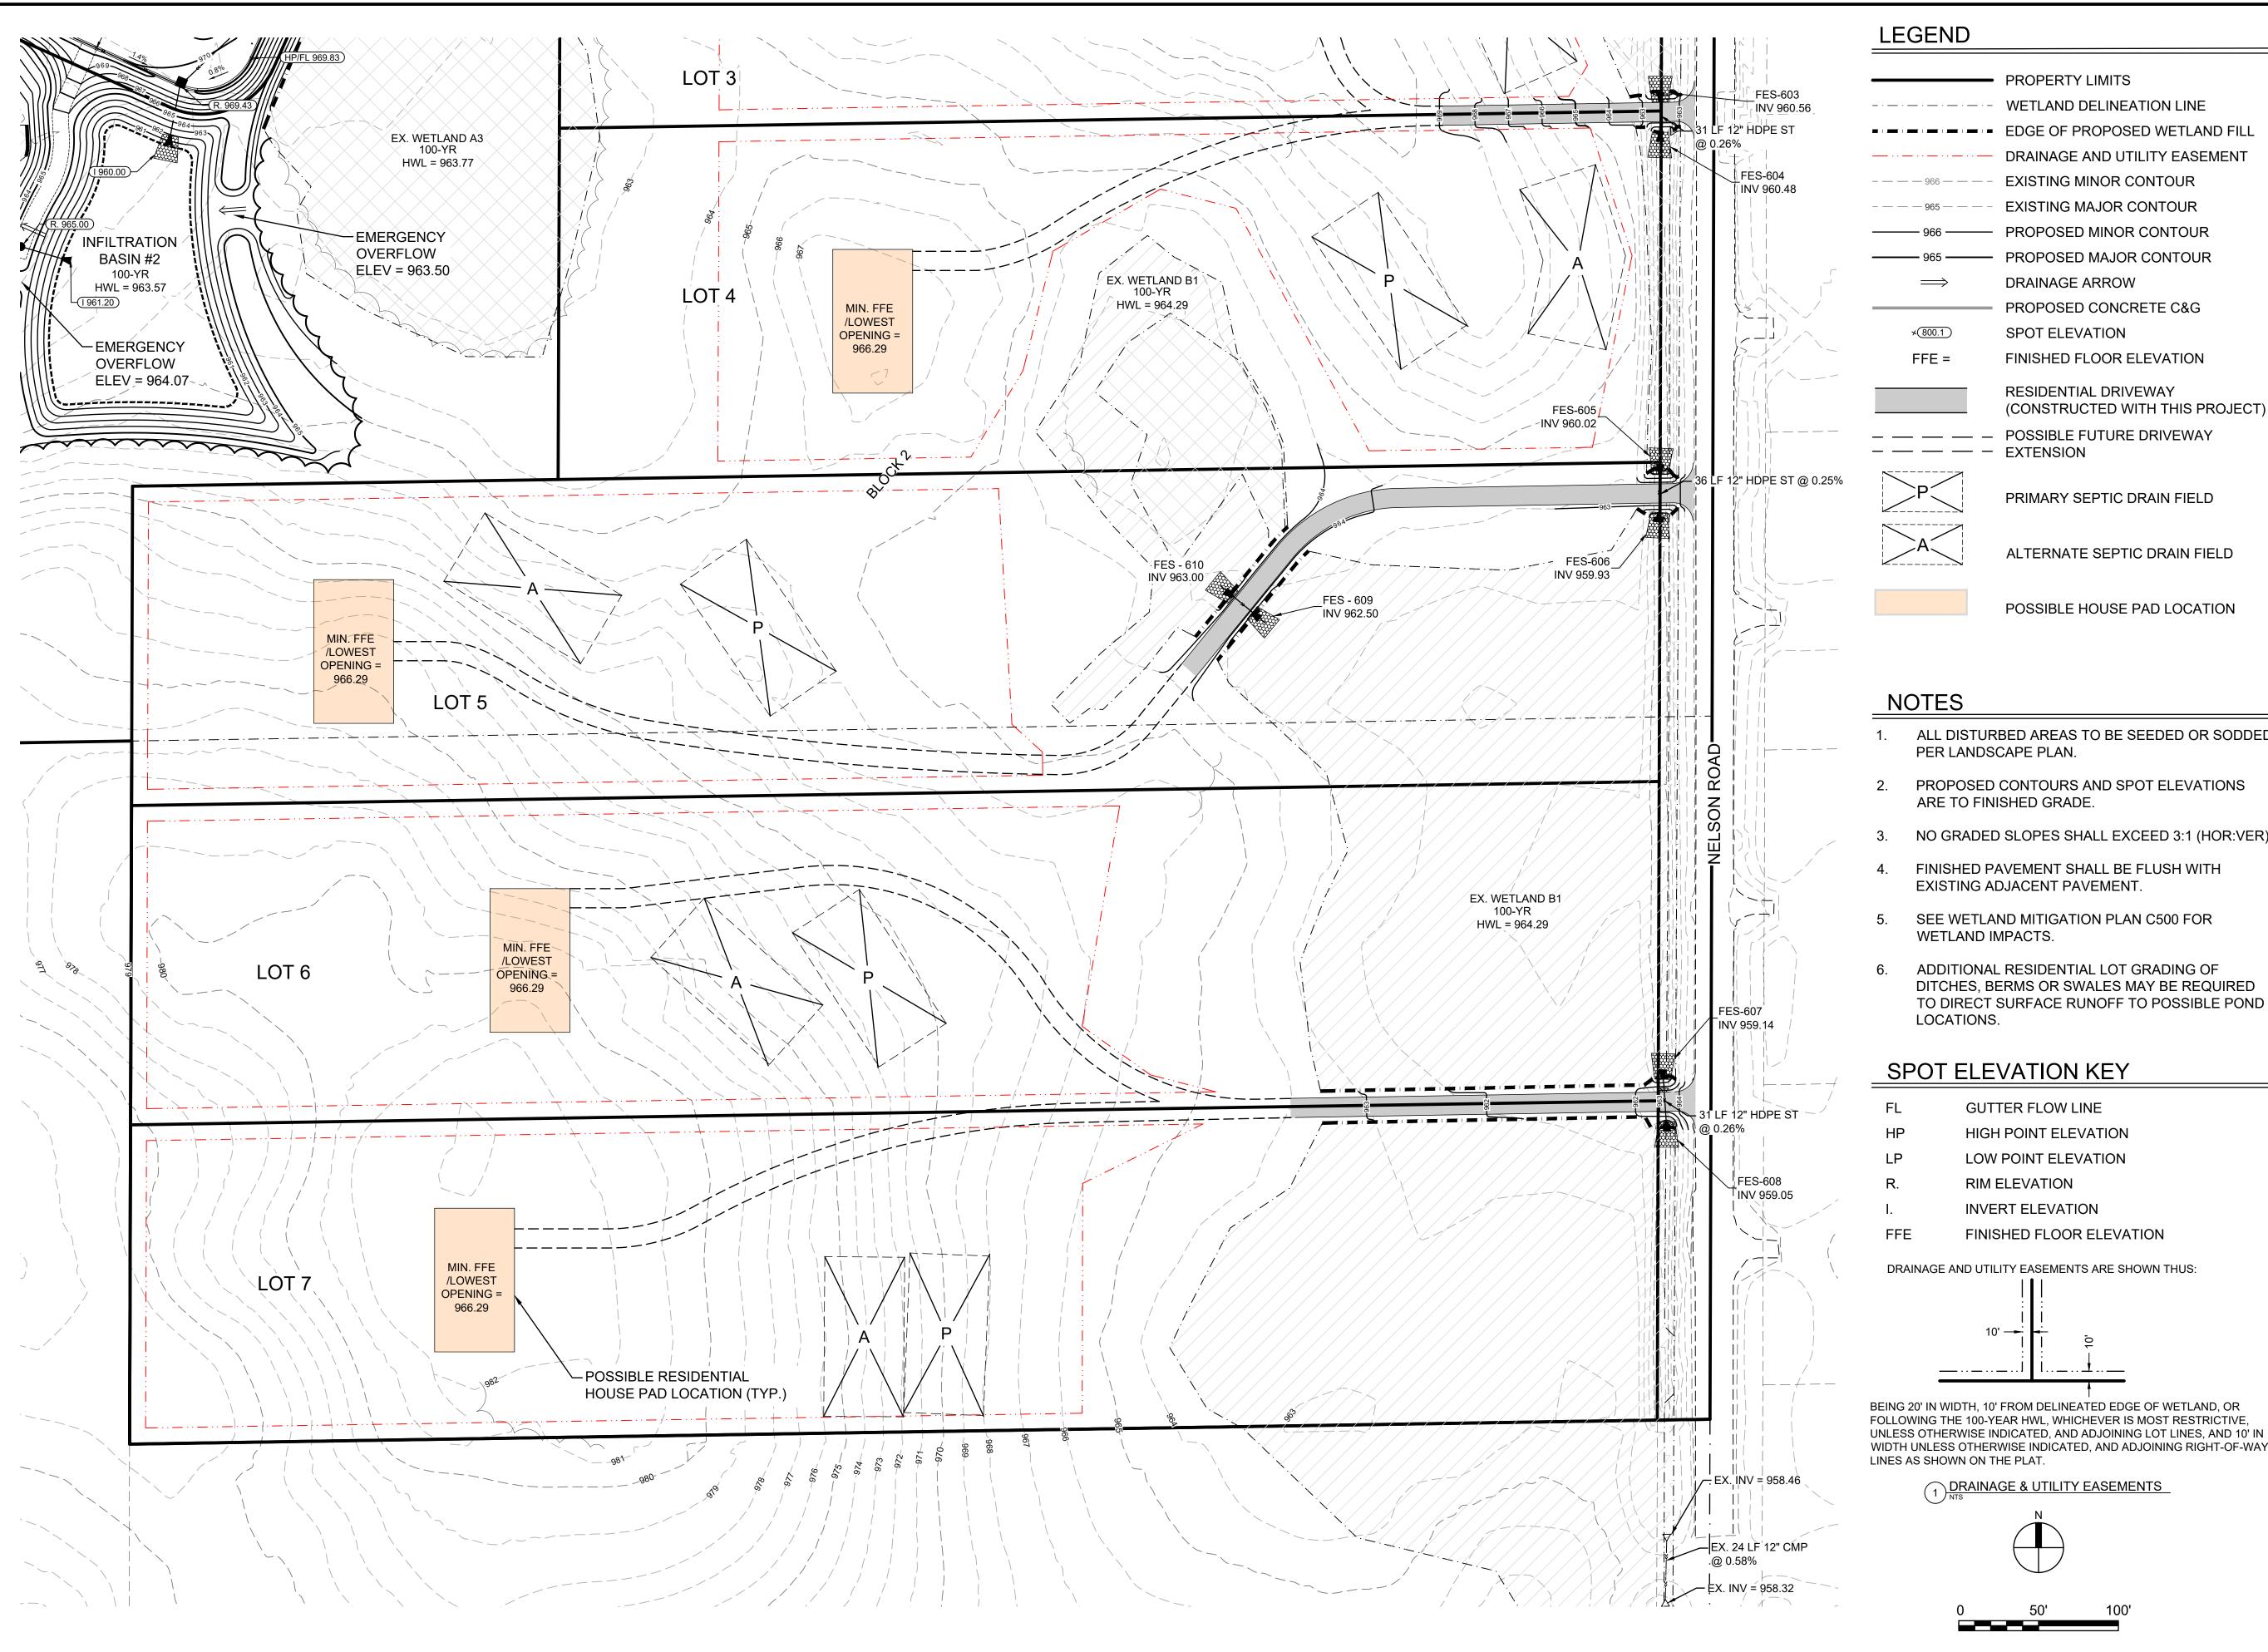

PROPERTY LIMITS WETLAND DELINEATION LINE EDGE OF PROPOSED WETLAND FILL DRAINAGE AND UTILITY EASEMENT **EXISTING MINOR CONTOUR EXISTING MAJOR CONTOUR** – PROPOSED MINOR CONTOUR PROPOSED MAJOR CONTOUR DRAINAGE ARROW PROPOSED CONCRETE C&G SPOT ELEVATION FINISHED FLOOR ELEVATION RESIDENTIAL DRIVEWAY

POSSIBLE FUTURE DRIVEWAY

PRIMARY SEPTIC DRAIN FIELD

ALTERNATE SEPTIC DRAIN FIELD

POSSIBLE HOUSE PAD LOCATION

- ALL DISTURBED AREAS TO BE SEEDED OR SODDED
- 2. PROPOSED CONTOURS AND SPOT ELEVATIONS
 - NO GRADED SLOPES SHALL EXCEED 3:1 (HOR:VER)
- 4. FINISHED PAVEMENT SHALL BE FLUSH WITH EXISTING ADJACENT PAVEMENT.
 - SEE WETLAND MITIGATION PLAN C500 FOR
 - ADDITIONAL RESIDENTIAL LOT GRADING OF DITCHES, BERMS OR SWALES MAY BE REQUIRED TO DIRECT SURFACE RUNOFF TO POSSIBLE POND

HIGH POINT ELEVATION

- FINISHED FLOOR ELEVATION

DRAINAGE AND UTILITY EASEMENTS ARE SHOWN THUS:

BEING 20' IN WIDTH, 10' FROM DELINEATED EDGE OF WETLAND, OR FOLLOWING THE 100-YEAR HWL, WHICHEVER IS MOST RESTRICTIVE, UNLESS OTHERWISE INDICATED, AND ADJOINING LOT LINES, AND 10' IN WIDTH UNLESS OTHERWISE INDICATED, AND ADJOINING RIGHT-OF-WAY

ANDERSON

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BRECKENRIDGE FARM

INDEPENDENCE, MINNESOTA

STODDARD COMPANIES

HEREBY CERTIFY THAT THIS PLAN, SPECIFICATION, C REPORT WAS PREPARED BY ME OR UNDER MY DIREC SUPERVISION AND THAT I AM A DULY LICENSEI PROFESSIONAL ENGINEER UNDER THE LAWS OF THE STATE OF MINNESOTA.

LEE KOPPY,	PF
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SIGNATURE:

DATE: <u>02/12/2024</u> LICENSE NO. <u>41267</u>

REVISION LOG

NO. DATE DESCRIPTION OF REVISIONS


FINAL PLAT


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LRK	MAM	LRK	
DRAWING TITLE			
GRADING PLAN SOUTH (RESIDENTIAL)			
DRAWING NO	Э.		

C404

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02/12/2024



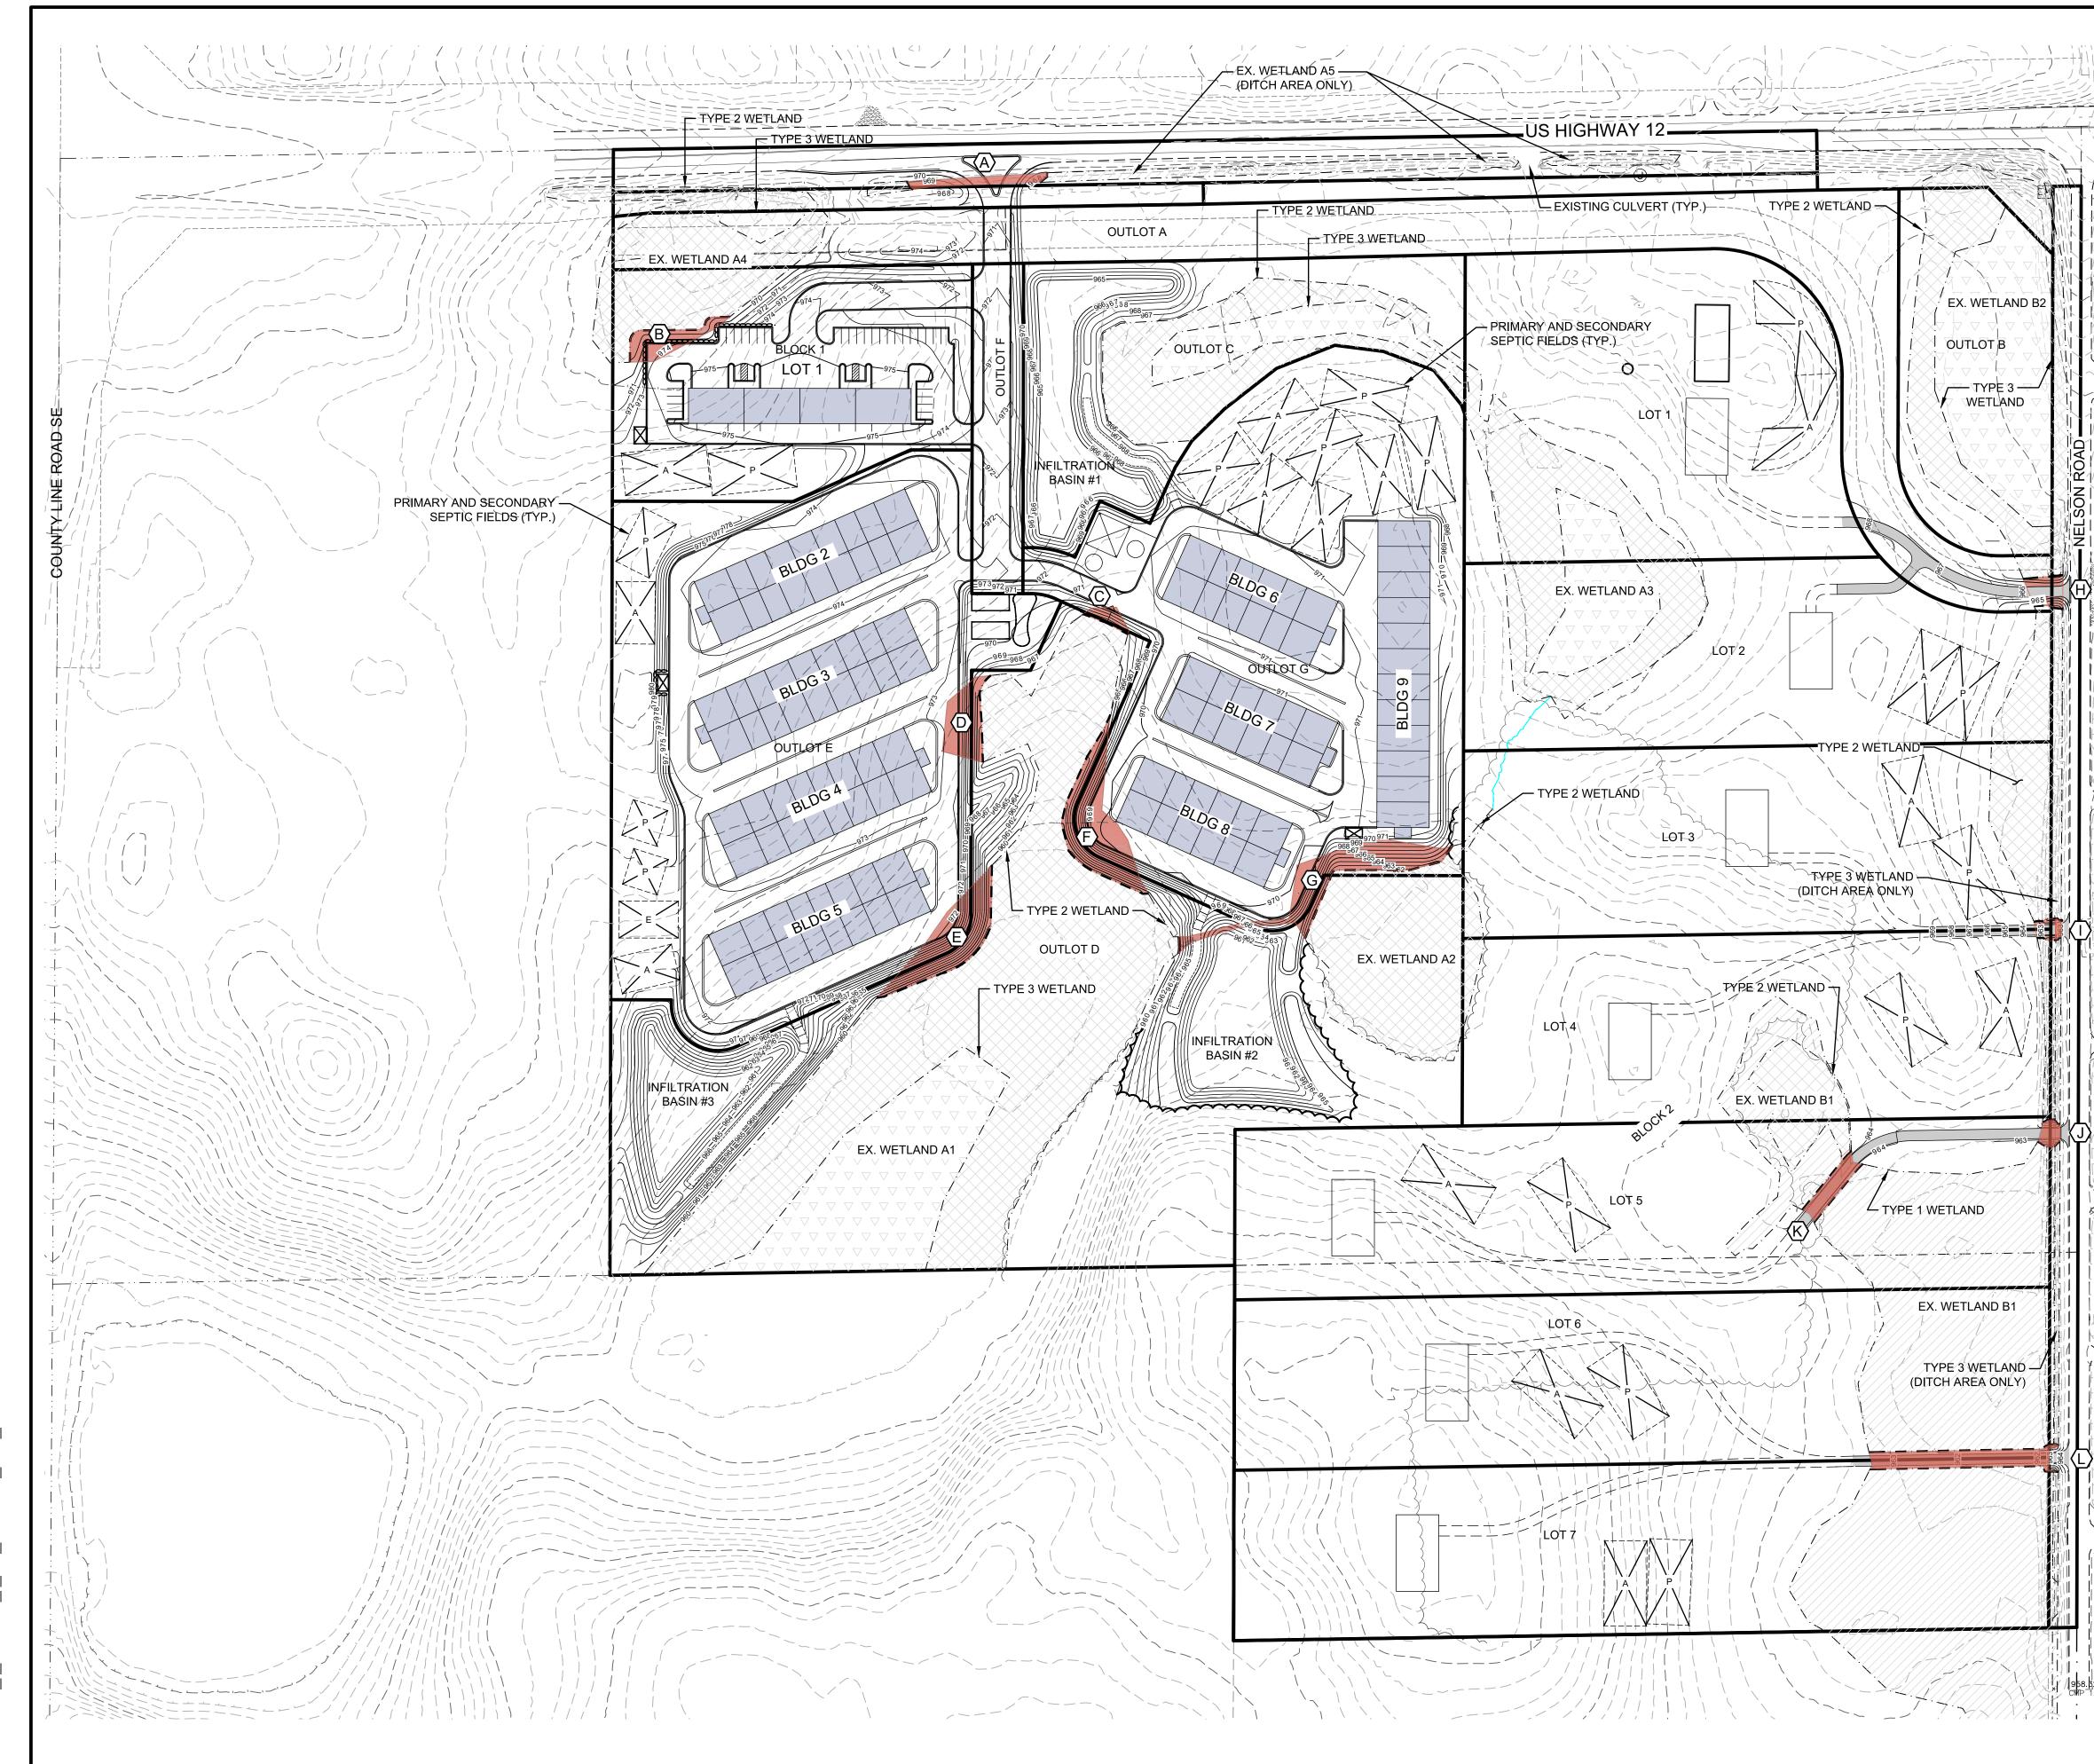

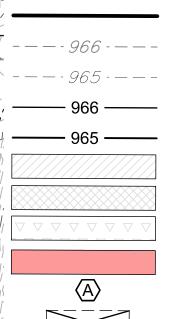PROPERTY LIMITS **EXISTING MINOR CONTOUR** 965 - - - EXISTING MAJOR CONTOUR PROPOSED MINOR CONTOUR PROPOSED MAJOR CONTOUR TYPE 1 WETLAND TYPE 2 WETLAND TYPE 3 WETLAND WETLAND IMPACT AREA WETLAND IMPACT PROPOSED SEPTIC DRAINFIELD

EXISTING WETLAND AREAS


TYPE 1 = 185,968 SF. (4.27 AC.) TYPE 2 = 377,277 SF. (8.66 AC.) TYPE 3 = 121,173 SF. (2.78 AC.) TOTAL = 684,418 SF. (15.71 AC.)


PROPOSED WETLAND IMPACT

ID	TYPE 1	TYPE 2	TYPE 3	TOTAL
А	1,545 SF	0 SF	0 SF	1,545 SF
В	0 SF	2,548 SF	0 SF	2,548 SF
С	0 SF	767 SF	0 SF	767 SF
D	0 SF	3,492 SF	0 SF	3,492 SF
Е	0 SF	6,748 SF	0 SF	6,748 SF
F	0 SF	8,043 SF	0 SF	8,043 SF
G	0 SF	7,558 SF	0 SF	7,558 SF
Н	0 SF	1,400 SF	0 SF	1,400 SF
I	0 SF	531 SF	150 SF	681 SF
J	512 SF	0 SF	141 SF	653 SF
K	1,495 SF	189 SF	0 SF	1,684 SF
L	4,292 SF	0 SF	18 SF	4,310 SF
TOT	ALS			
	7,844 SF	31,276 SF	309 SF	39,429 SF

0.90 AC

NOTE: WETLAND QUALITY OF ALL EX. WETLANDS WITHIN PROJECT AREA IS "LOW".

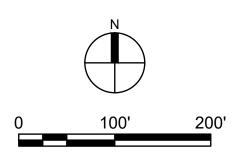

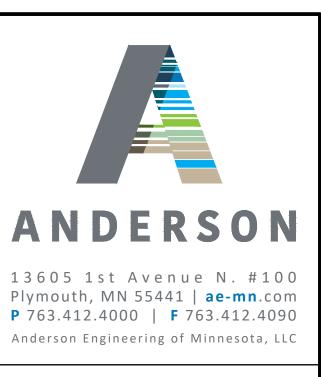

BRECKENRIDGE FARM

INDEPENDENCE, MINNESOTA

STODDARD COMPANIES

I HEREBY CERTIFY THAT THIS PLAN, SPECIFICATION, C REPORT WAS PREPARED BY ME OR UNDER MY DIRECT SUPERVISION AND THAT I AM A CERTIFIED PROFESSIONAL WETLAND SCIENTIST UNDER THE LAWS OF THE STATE OF MINNESOTA.

PRINT NAME:	BEN HODAPF

SIGNATURE:

DATE: <u>02/12/2024</u> LICENSE NO. <u>001832</u>

NO. DATE

REVISION LOG


DESCRIPTION OF REVISIONS

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FINAL PLAT


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LRK	MAM	LRK					
RAWING TI	TLE						
WETLAND IMPACT							
RAWING NO.							
	C500						


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)ARD - 58 ACRE - IN Block FINAL PLAT\ 6915 ST 22x34 ':\16900\' \ 16915 15 15 2024 - 11:41am ename: \ 16915 12, 12, Feb Xref

LEGEND	
PROPERTY LIMITS PROPERTY LIMITS PROPERTY LIMITS PROPOSED MINOR CONTOUR PROPOSED MINOR CONTOUR PROPOSED MAJOR CONTOUR TYPE 1 WETLAND TYPE 2 WETLAND TYPE 3 WETLAND WETLAND BUFFER ZONE	A N D E R S O N 13605 1st Avenue N. #100 Plymouth, MN 55441 ae-mn.com P 763.412.4000 F 763.412.4090 Anderson Engineering of Minnesota, LLC
EXPANDED WETLAND BUFFER FOREST PRESERVATION SEPTIC DRAIN FIELD	BRECKENRIDGE FARM
POTENTIAL HOUSE PAD LOCATION	INDEPENDENCE, MINNESOTA STODDARD COMPANIES
WETLAND BUFFER SHALL MEET AVERAGE BUFFER WIDTHS IN TABLE BELOW AND MUST BE A MINIMUM OF 10 FEET WIDE. A MONUMENT SHALL BE REQUIRED AT EACH PARCEL LINE WHERE IT CROSSES A WETLAND BUFFER AND SHALL HAVE A MAXIMUM SPACING OF 200 FEET ALONG THE EDGE OF THE WETLAND BUFFER. A MONUMENT SHALL CONSIST OF A POST AND A WETLAND BUFFER SIGN MEETING COMMISSION STANDARDS. THE SIGNS SHALL INCLUDE WARNINGS ABOUT MOWING, DISTRIBUTING OR DEVELOPING THE WETLAND BUFFER ZONE	I HEREBY CERTIFY THAT THIS PLAN, SPECIFICATION, OR REPORT WAS PREPARED BY ME OR UNDER MY DIRECT SUPERVISION AND THAT I AM A CERTIFIED PROFESSIONAL WETLAND SCIENTIST UNDER THE LAWS OF THE STATE OF MINNESOTA. PRINT NAME: LEE KOPPY SIGNATURE: DATE: 02/12/2024 LICENSE NO. 41267 REVISION LOG NO. DATE DESCRIPTION OF REVISIONS
DESIGN CRITERIABUFFER AREAS DISTURBED BY GRADING OPERATIONS MUST BE FINISH GRADE TO A SLOPE OF 6:1 OR LESS OR AN INCREASE IN WIDTH OF FIVE (5) FEET FOR EACH ONE (1) FOOT DECREASE IN HORIZONTAL WIDTHEXAMPLE $2.5:1 = 42.5'$ $3:1 = 40'$ $4:1 = 35'$ $5:1 = 30'$ $6:1 = 25'$ MIN = 10'SEE SHEET C502 FOR WETLAND BUFFER SLOPE DESIGNATIONS.SEE SHEET C503-C506 FOR WETLAND BUFFER AVERAGING CALCULATIONS.	FINAL PLAT DESIGNED: LRK MAM CHECKED BY: LRK DRAWING TITLE WETLAND BUFFER DRAWING NO.
	DRAWING NO. C501 PLOTTED: COMM. NO. 02/12/2024 16915

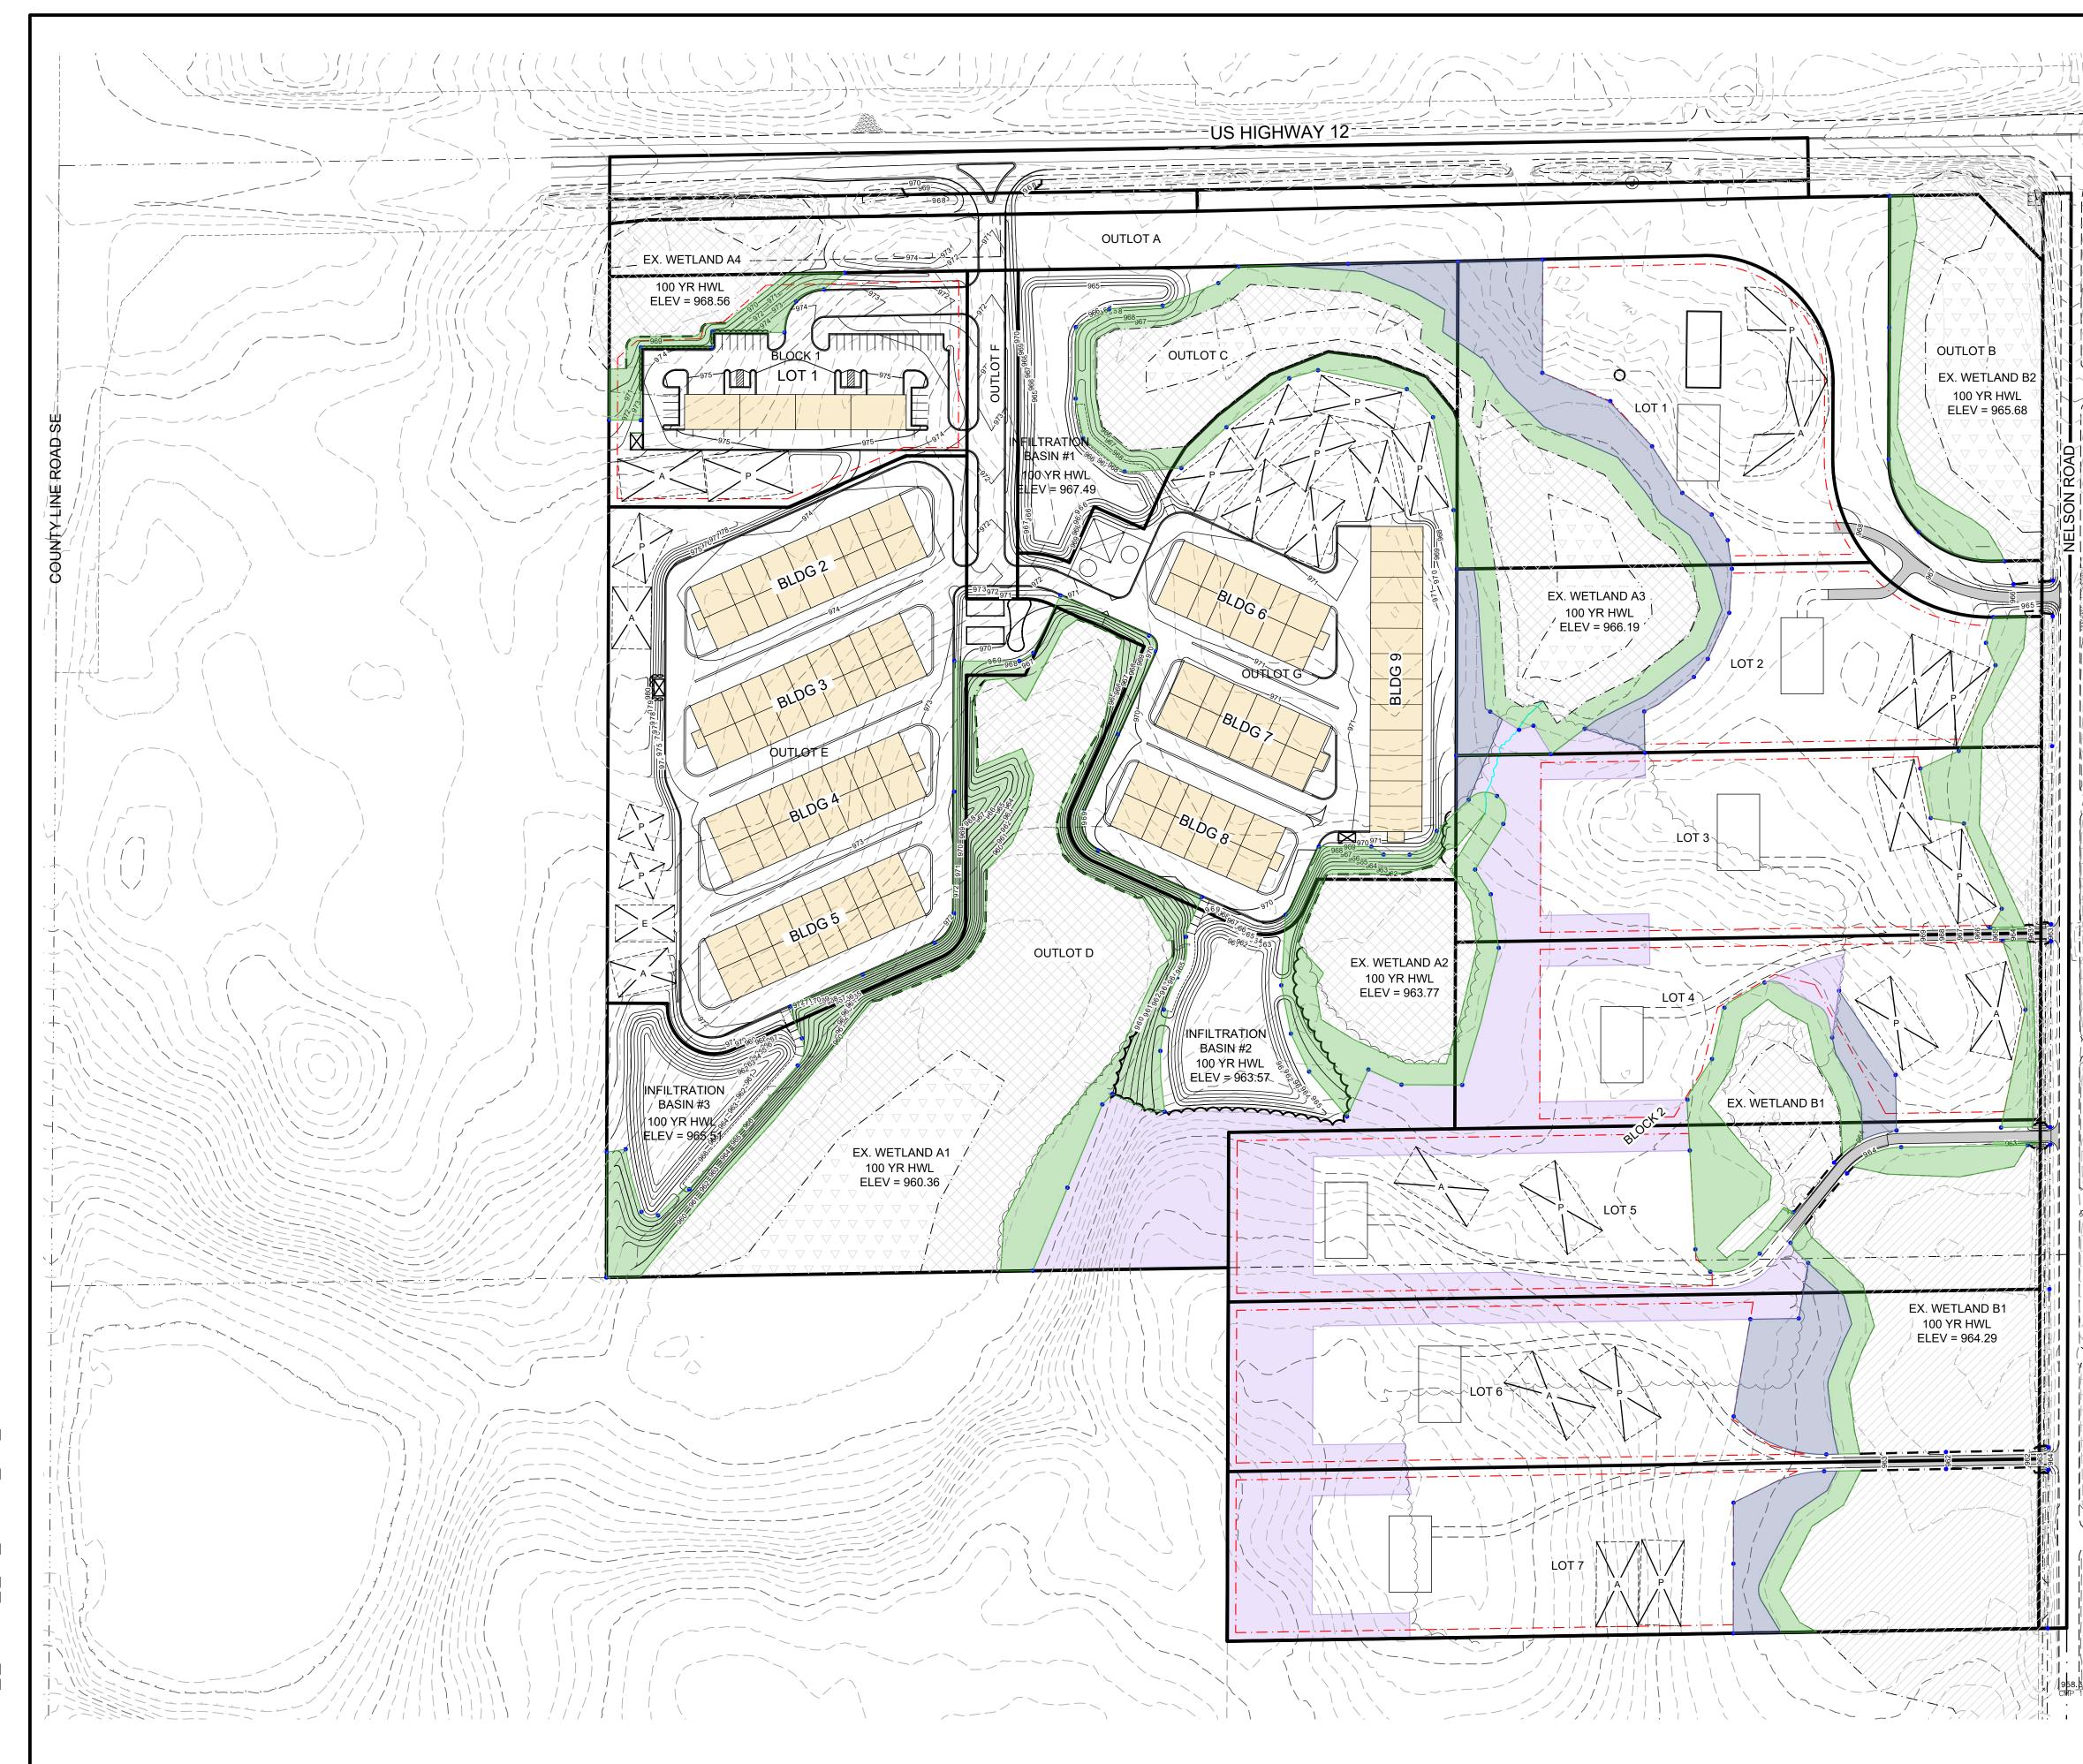

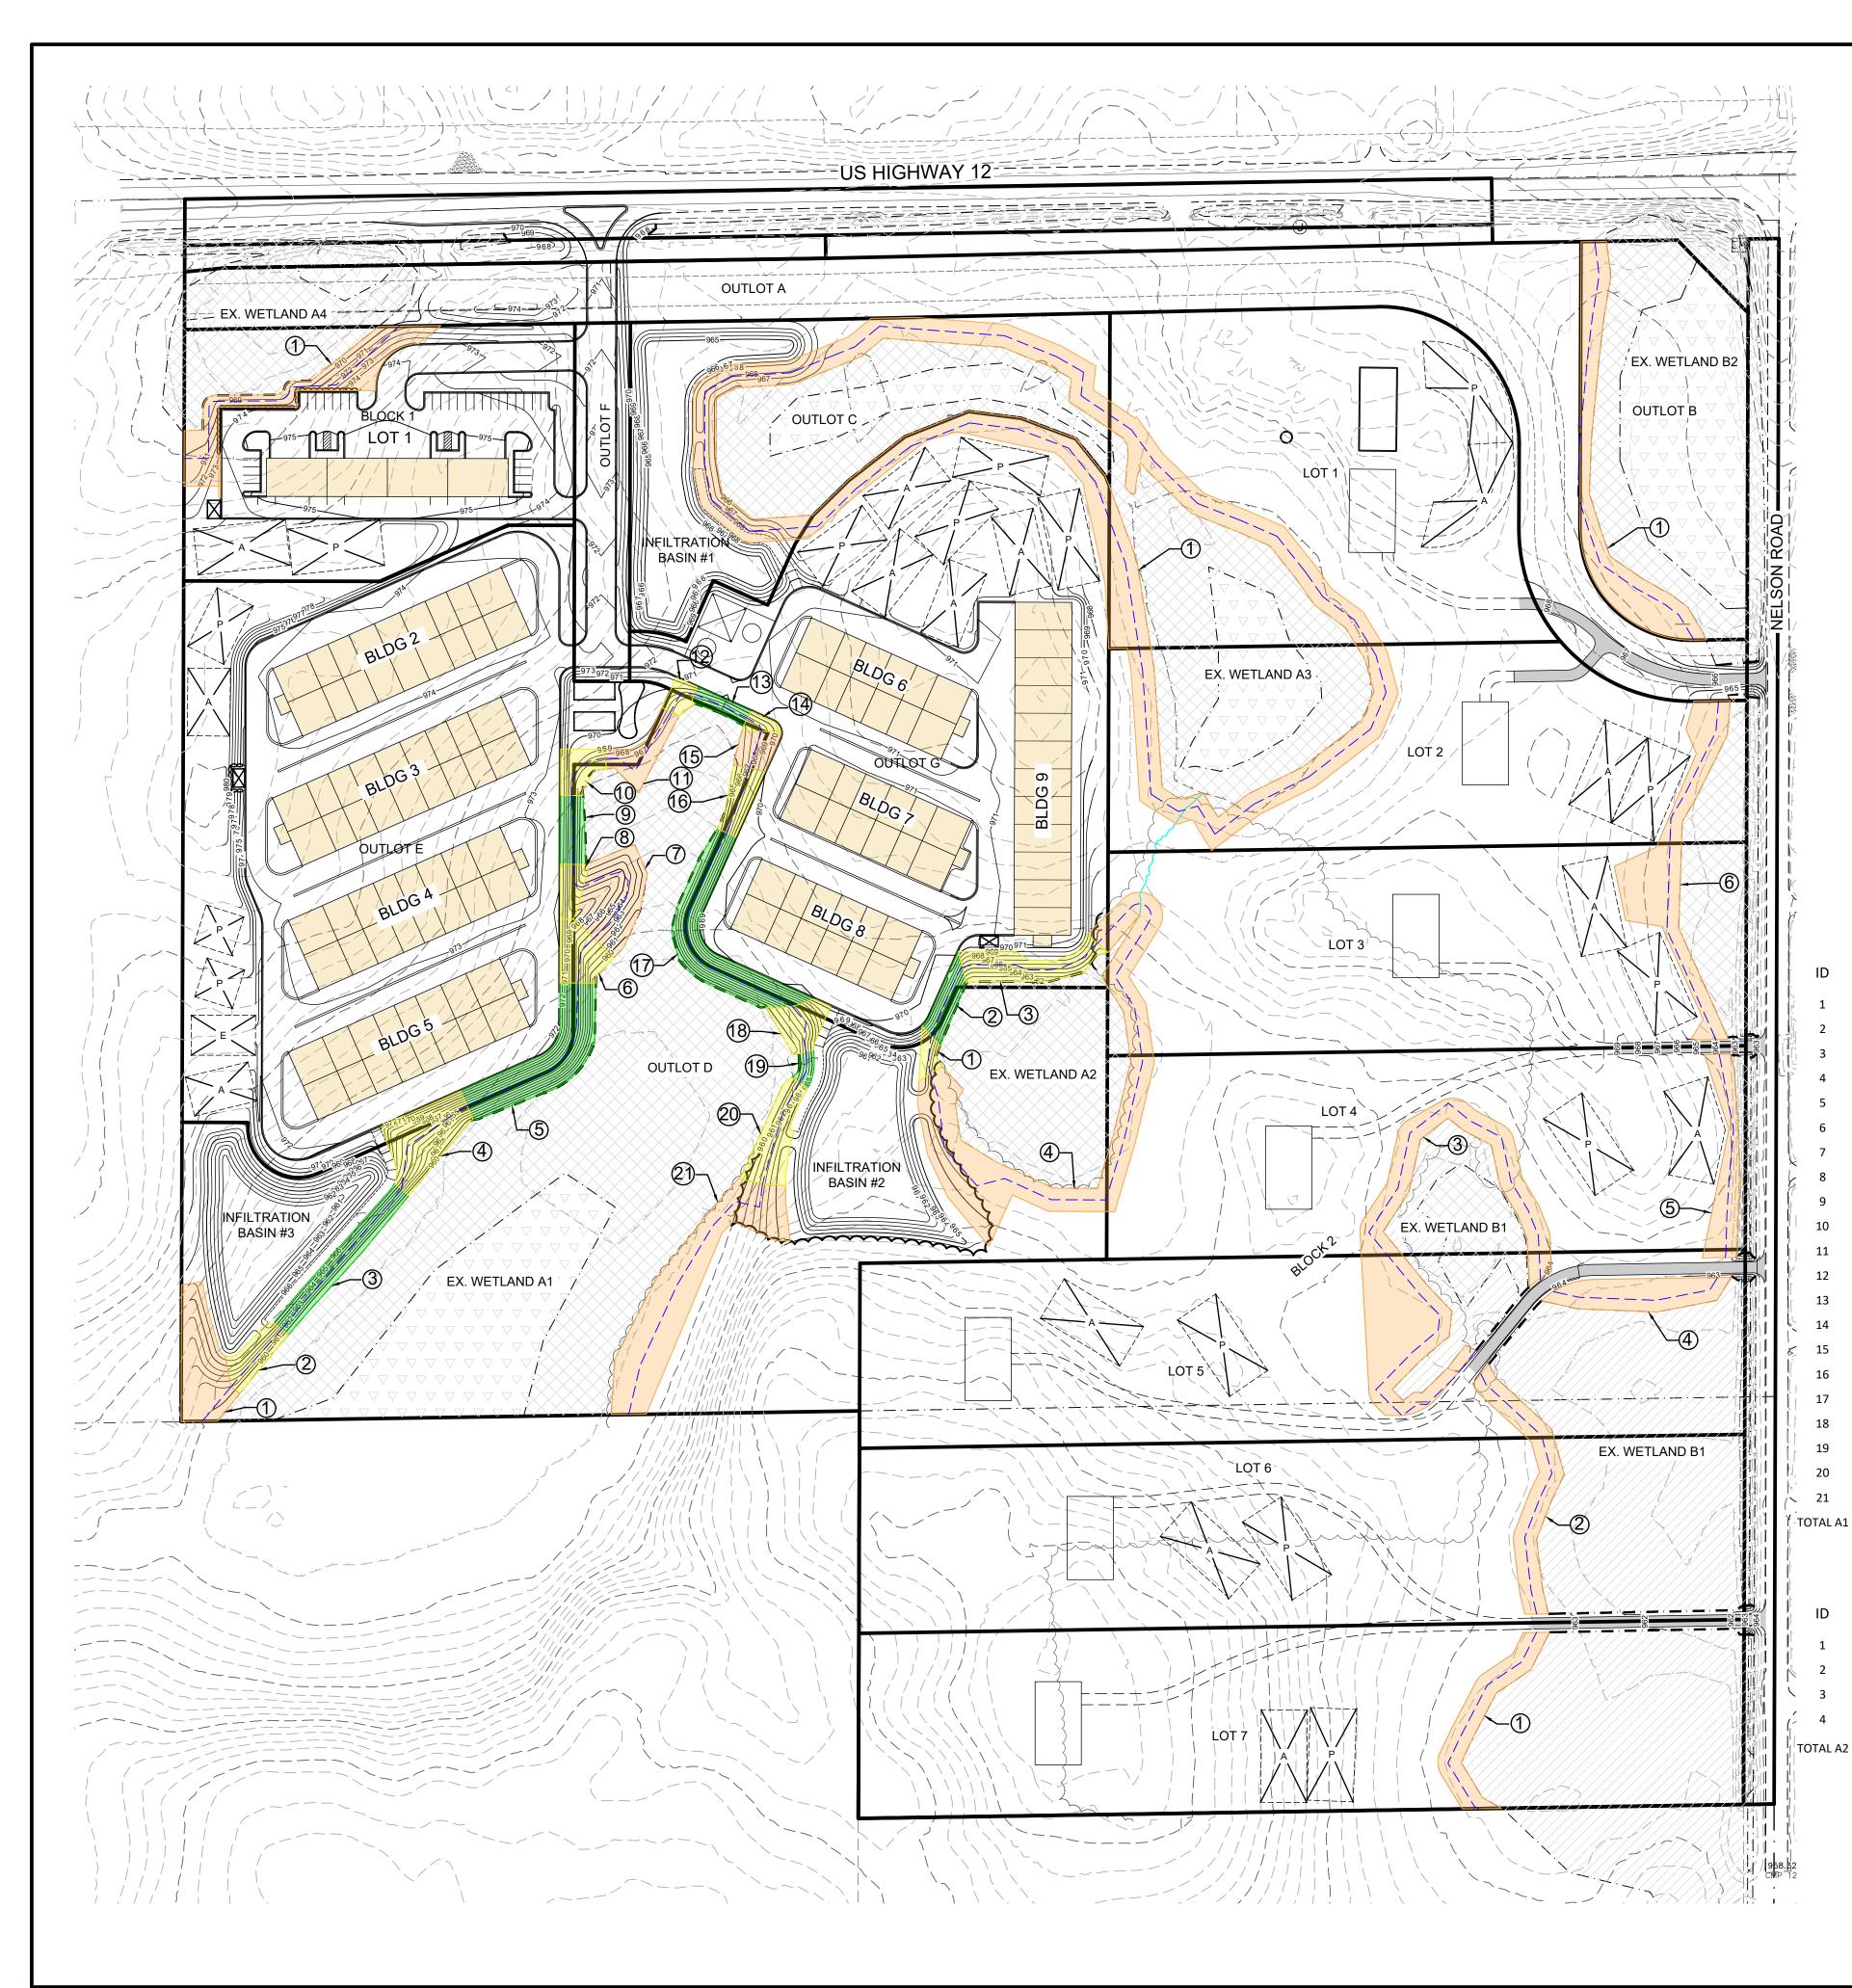

WETLAND A1 BUFFER SUMMARY

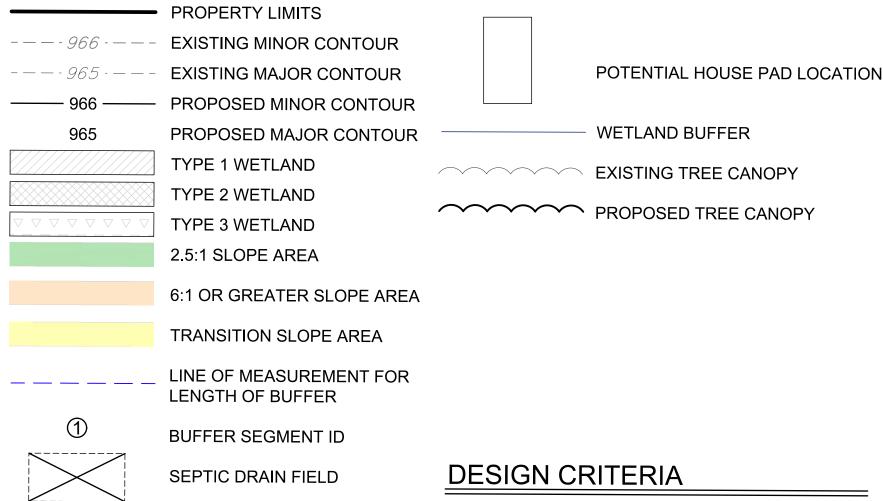	SLOPE	LENGTH	AREA	AVG. W	REQ. AVG. W
	6:1 or greater	49	6172	127.2	25.00
	Trans. (4.25:1)	83	2222	26.9	33.75
	2.5:1	199	4336	21.7	42.50
	Trans. (4.25:1)	125	5479	43.8	33.75
	2.5:1	202	7668	38.0	42.50
	Trans. (4.25:1)	55	2770	50.8	33.75
	6:1 or greater	132	6071	46.0	42.50
	Trans. (4.25:1)	31	1372	43.8	33.75
	2.5:1	74	1935	26.0	25.00
	Trans. (4.25:1)	62	1876	30.3	33.75
	6:1 or greater	112	2608	23.3	25.00
	Trans. (4.25:1)	38	917	24.4	33.75
	2.5:1	63	1037	16.5	42.50
	Trans. (4.25:1)	22	565	25.8	33.75
	6:1 or greater	42	1605	38.4	25.00
	Trans. (4.25:1)	74	1962	26.4	33.75
	2.5:1	263	7612	28.9	42.50
	Trans. (4.25:1)	56	2393	42.9	33.75
	2.5:1	35	599	17.0	42.50
	Trans. (4.25:1)	118	3817	32.4	33.75
	6:1 or greater	313	13941	44.6	25.00
1		2148	75457	35.9*	33.90*

WETLAND A2 BUFFER SUMMARY

	SLOPE	LENGTH	AREA	AVG. W	REQ. AVG. W
	Trans. (4.25:1)	54	848	15.7	33.75
	2.5:1	82	1863	22.9	42.50
	Trans. (4.25:1)	157	4120	26.2	33.75
	6:1 or greater	695	22012	31.7	25.00
A2		988	28843	29.2*	28.30*

*WEIGHTED AVERAGE OVER CALCULATED WETLAND PERIMETER

SEE SHEETS C503 TO C505 FOR DETAILED DIMENSIONS OF EACH BUFFER SEGMENT.



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BRECKENRIDGE FARM

INDEPENDENCE, MINNESOTA

STODDARD COMPANIES

I HEREBY CERTIFY THAT THIS PLAN, SPECIFICATION, C REPORT WAS PREPARED BY ME OR UNDER MY DIRECT SUPERVISION AND THAT I AM A CERTIFIED PROFESSIONAL WETLAND SCIENTIST UNDER THE LAWS OF THE STATE OF MINNESOTA.

PRINT NAME: LEE KOPPY		
	PRINT NAME:	LEE KOPPY

	Anther
SIGNATURE:	Chines -

DATE: <u>02/12/2024</u> LICENSE NO. <u>41267</u>

REVISION LOG

DESCRIPTION OF REVISIONS NO. DATE

FINAL PLAT

DESIGNED:	DRAWN:	CHECKED BY:			
LRK	MAM	LRK			
DRAWING TITLE					
	/ETLAN ER SL(

DRAWING NO.

C502

BUFFER AREAS DISTURBED BY GRADING **OPERATIONS MUST BE FINISH GRADE TO A** SLOPE OF 6:1 OR LESS OR AN INCREASE IN WIDTH OF FIVE (5) FEET FOR EACH ONE (1) FOOT DECREASE IN HORIZONTAL WIDTH

EXAN	/IPLE		EXTRAPOLATED AVERAGE
3:1	=	40'	WIDTH FOR 2.5 :1 = 42.5'
4:1	=	35'	
5:1	=	30'	
6:1	=	25'	
MIN	=	10'	

WETLAND A3 BUFFER SUMMARY

ID	SLOPE	LENGTH	AREA	AVG. W	REQ. AVG. W
1	6:1 or greater	2227	56616	25.4	25.00
TOTAL A3		2227	56616	25.4	25.00

WETLAND A4 BUFFER SUMMARY

ID	SLOPE	LENGTH	AREA	AVG. W	REQ. AVG. W
1	6:1 or greater	323	8593	27.0	25.00
TOTAL A4		323	8593	27.0	25.00

WETLAND B1 BUFFER SUMMARY

ID	SLOPE	LENGTH	AREA	AVG. W	REQ. AVG. W
1	6:1 or greater	235	5863	25.0	25.00
2	6:1 or greater	296	7391	25.0	25.00
3	6:1 or greater	780	22627	29.0	25.00
4	6:1 or greater	187	5276	30.6	25.00
5	6:1 or greater	221	5122	23.2	25.00
6	6:1 or greater	389	11768	30.2	25.00
TOTAL B1		2107	58499	27.8*	25.00*

WETLAND B2 BUFFER SUMMARY


ID	SLOPE	LENGTH	AREA	AVG. W	REQ. AVG. W
1	6:1 or greater	487	12262	25.0	25.00
TOTAL B2		487	12262	25.0	25.00

200'

PLOTTED: 02/12/2024


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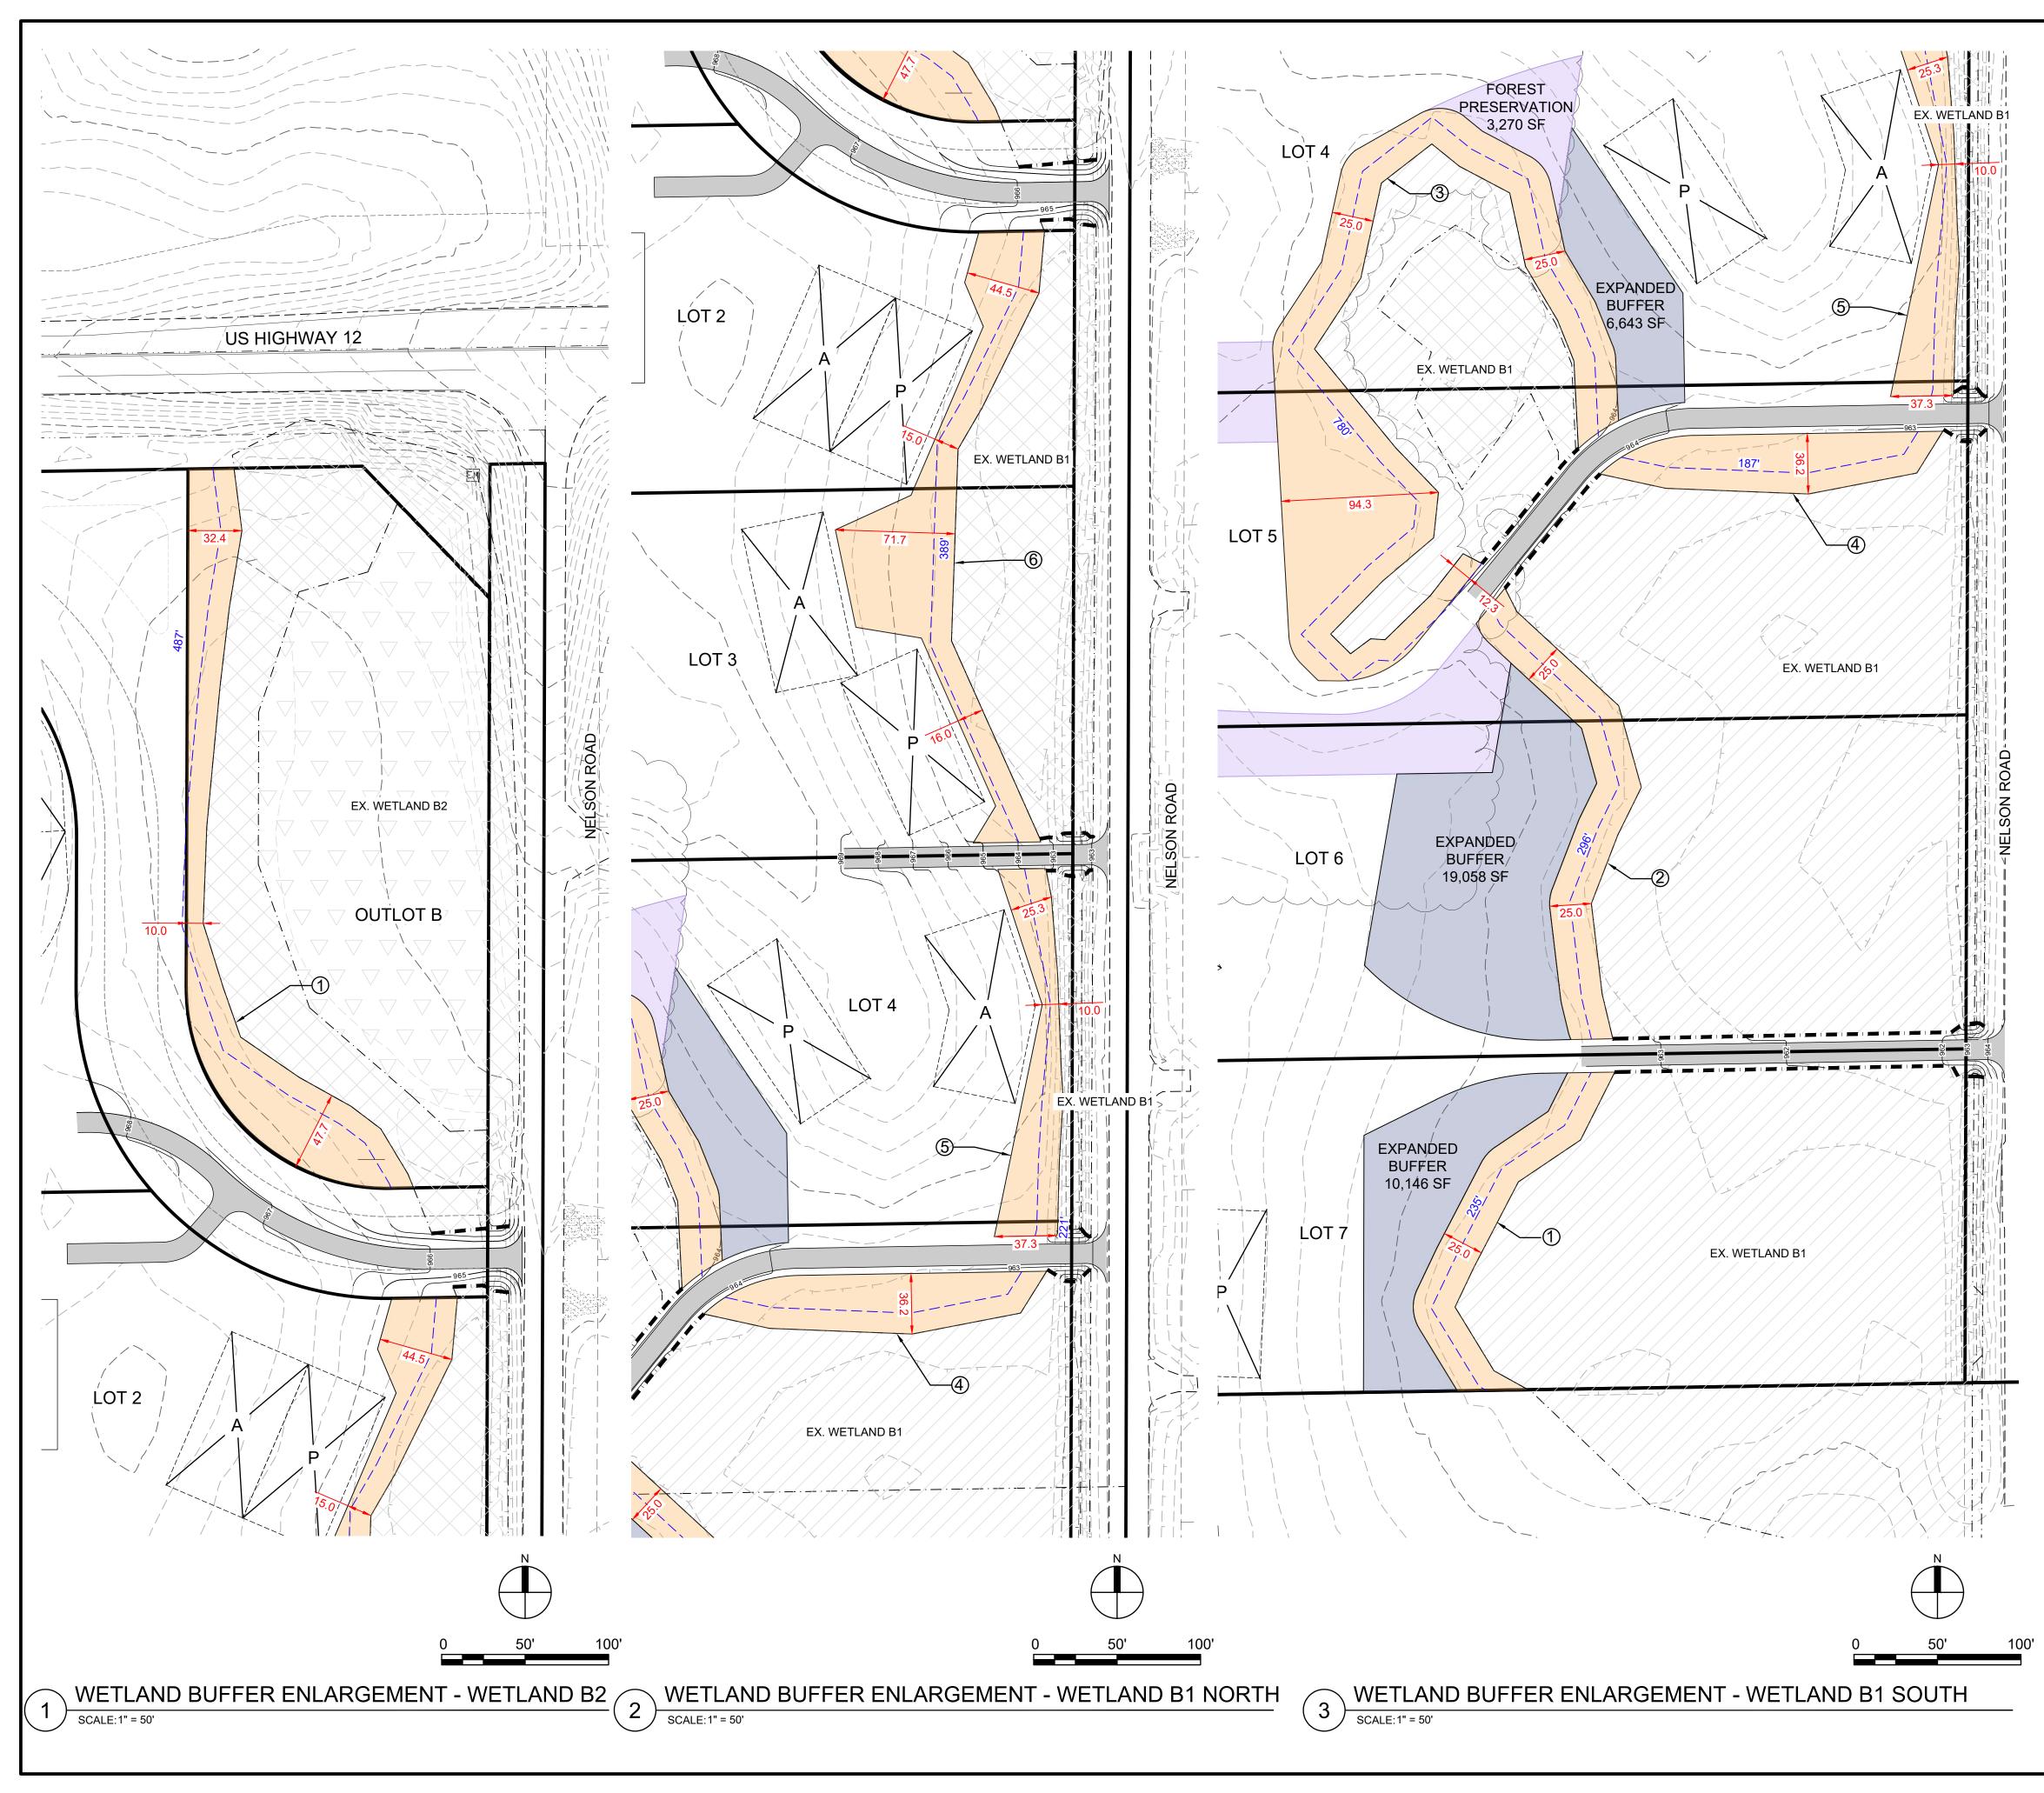


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LEGEND		
PROPERTY LIMITS PROPERTY LIMITS PROPERTY LIMITS PROPOSED MINOR CONTOUR P66 PROPOSED MAJOR CONTOUR P65 PROPOSED MAJOR CONTOUR TYPE 1 WETLAND TYPE 2 WETLAND TYPE 3 WETLAND WETLAND BUFFER ZONE - TRANSITION SLOPE AREA WETLAND BUFFER ZONE - 2.5:1	A D D E R S O N A N D E R S O N 13605 1st Avenue N. #100 Plymouth, MN 55441 ae-mn.com P 763.412.4000 F 763.412.4090 Anderson Engineering of Minnesota, LLC	
SLOPE AREA WETLAND BUFFER ZONE - 6:1 SLOPE AREA XXX' BUFFER ZONE LENGTH BUFFER WIDTH AT SPECIFIC	BRECKENRIDGE FARM	
LOCATION Image: Description of the segment of the segment id LINE OF MEASUREMENT FOR LINE OF MEASUREMENT FOR LENGTH OF BUFFER EXPANDED WETLAND BUFFER	INDEPENDENCE, MINNESOTA	
EXPANDED WEITLAND BOFFER FOREST PRESERVATION SEPTIC DRAIN FIELD	STODDARD COMPANIES	
POTENTIAL HOUSE PAD LOCATION EXISTING TREE CANOPY PROPOSED TREE CANOPY	I HEREBY CERTIFY THAT THIS PLAN, SPECIFICATION, OR REPORT WAS PREPARED BY ME OR UNDER MY DIRECT SUPERVISION AND THAT I AM A CERTIFIED PROFESSIONAL WETLAND SCIENTIST UNDER THE LAWS OF THE STATE OF MINNESOTA. PRINT NAME: <u>LEE KOPPY</u>	
WETLAND BUFFER SHALL MEET AVERAGE BUFFER WIDTHS IN TABLE BELOW AND MUST BE A MINIMUM OF 10 FEET WIDE.	SIGNATURE:	
A MONUMENT SHALL BE REQUIRED AT EACH PARCEL LINE WHERE IT CROSSES A WETLAND BUFFER AND SHALL HAVE A MAXIMUM SPACING OF 200 FEET ALONG THE EDGE OF THE WETLAND BUFFER. A MONUMENT SHALL CONSIST OF A POST AND A WETLAND BUFFER SIGN MEETING COMMISSION STANDARDS. THE SIGNS SHALL INCLUDE WARNINGS ABOUT MOWING, DISTRIBUTING OR DEVELOPING THE WETLAND BUFFER ZONE	FINAL PLAT	
DESIGN CRITERIA BUFFER AREAS DISTURBED BY GRADING OPERATIONS MUST BE FINISH GRADE TO A SLOPE OF 6:1 OR LESS OR AN INCREASE IN WIDTH OF FIVE (5) FEET FOR EACH ONE (1) FOOT DECREASE IN HORIZONTAL WIDTH	DESIGNED: DRAWN: CHECKED BY: LRK MAM LRK DRAWING TITLE WETLAND	
$\frac{EXAMPLE}{2.5:1} = 42.5'$ $3:1 = 40'$ $4:1 = 35'$ $5:1 = 30'$ $6:1 = 25'$	BUFFER ENLARGEMENT - 1 DRAWING NO.	
MIN = 10' SEE SHEET C502 FOR AVERAGE WETLAND BUFFER WIDTH CALCULATIONS.	C503	
0 50' 100'	PLOTTED: COMM. NO. 02/12/2024 16915	

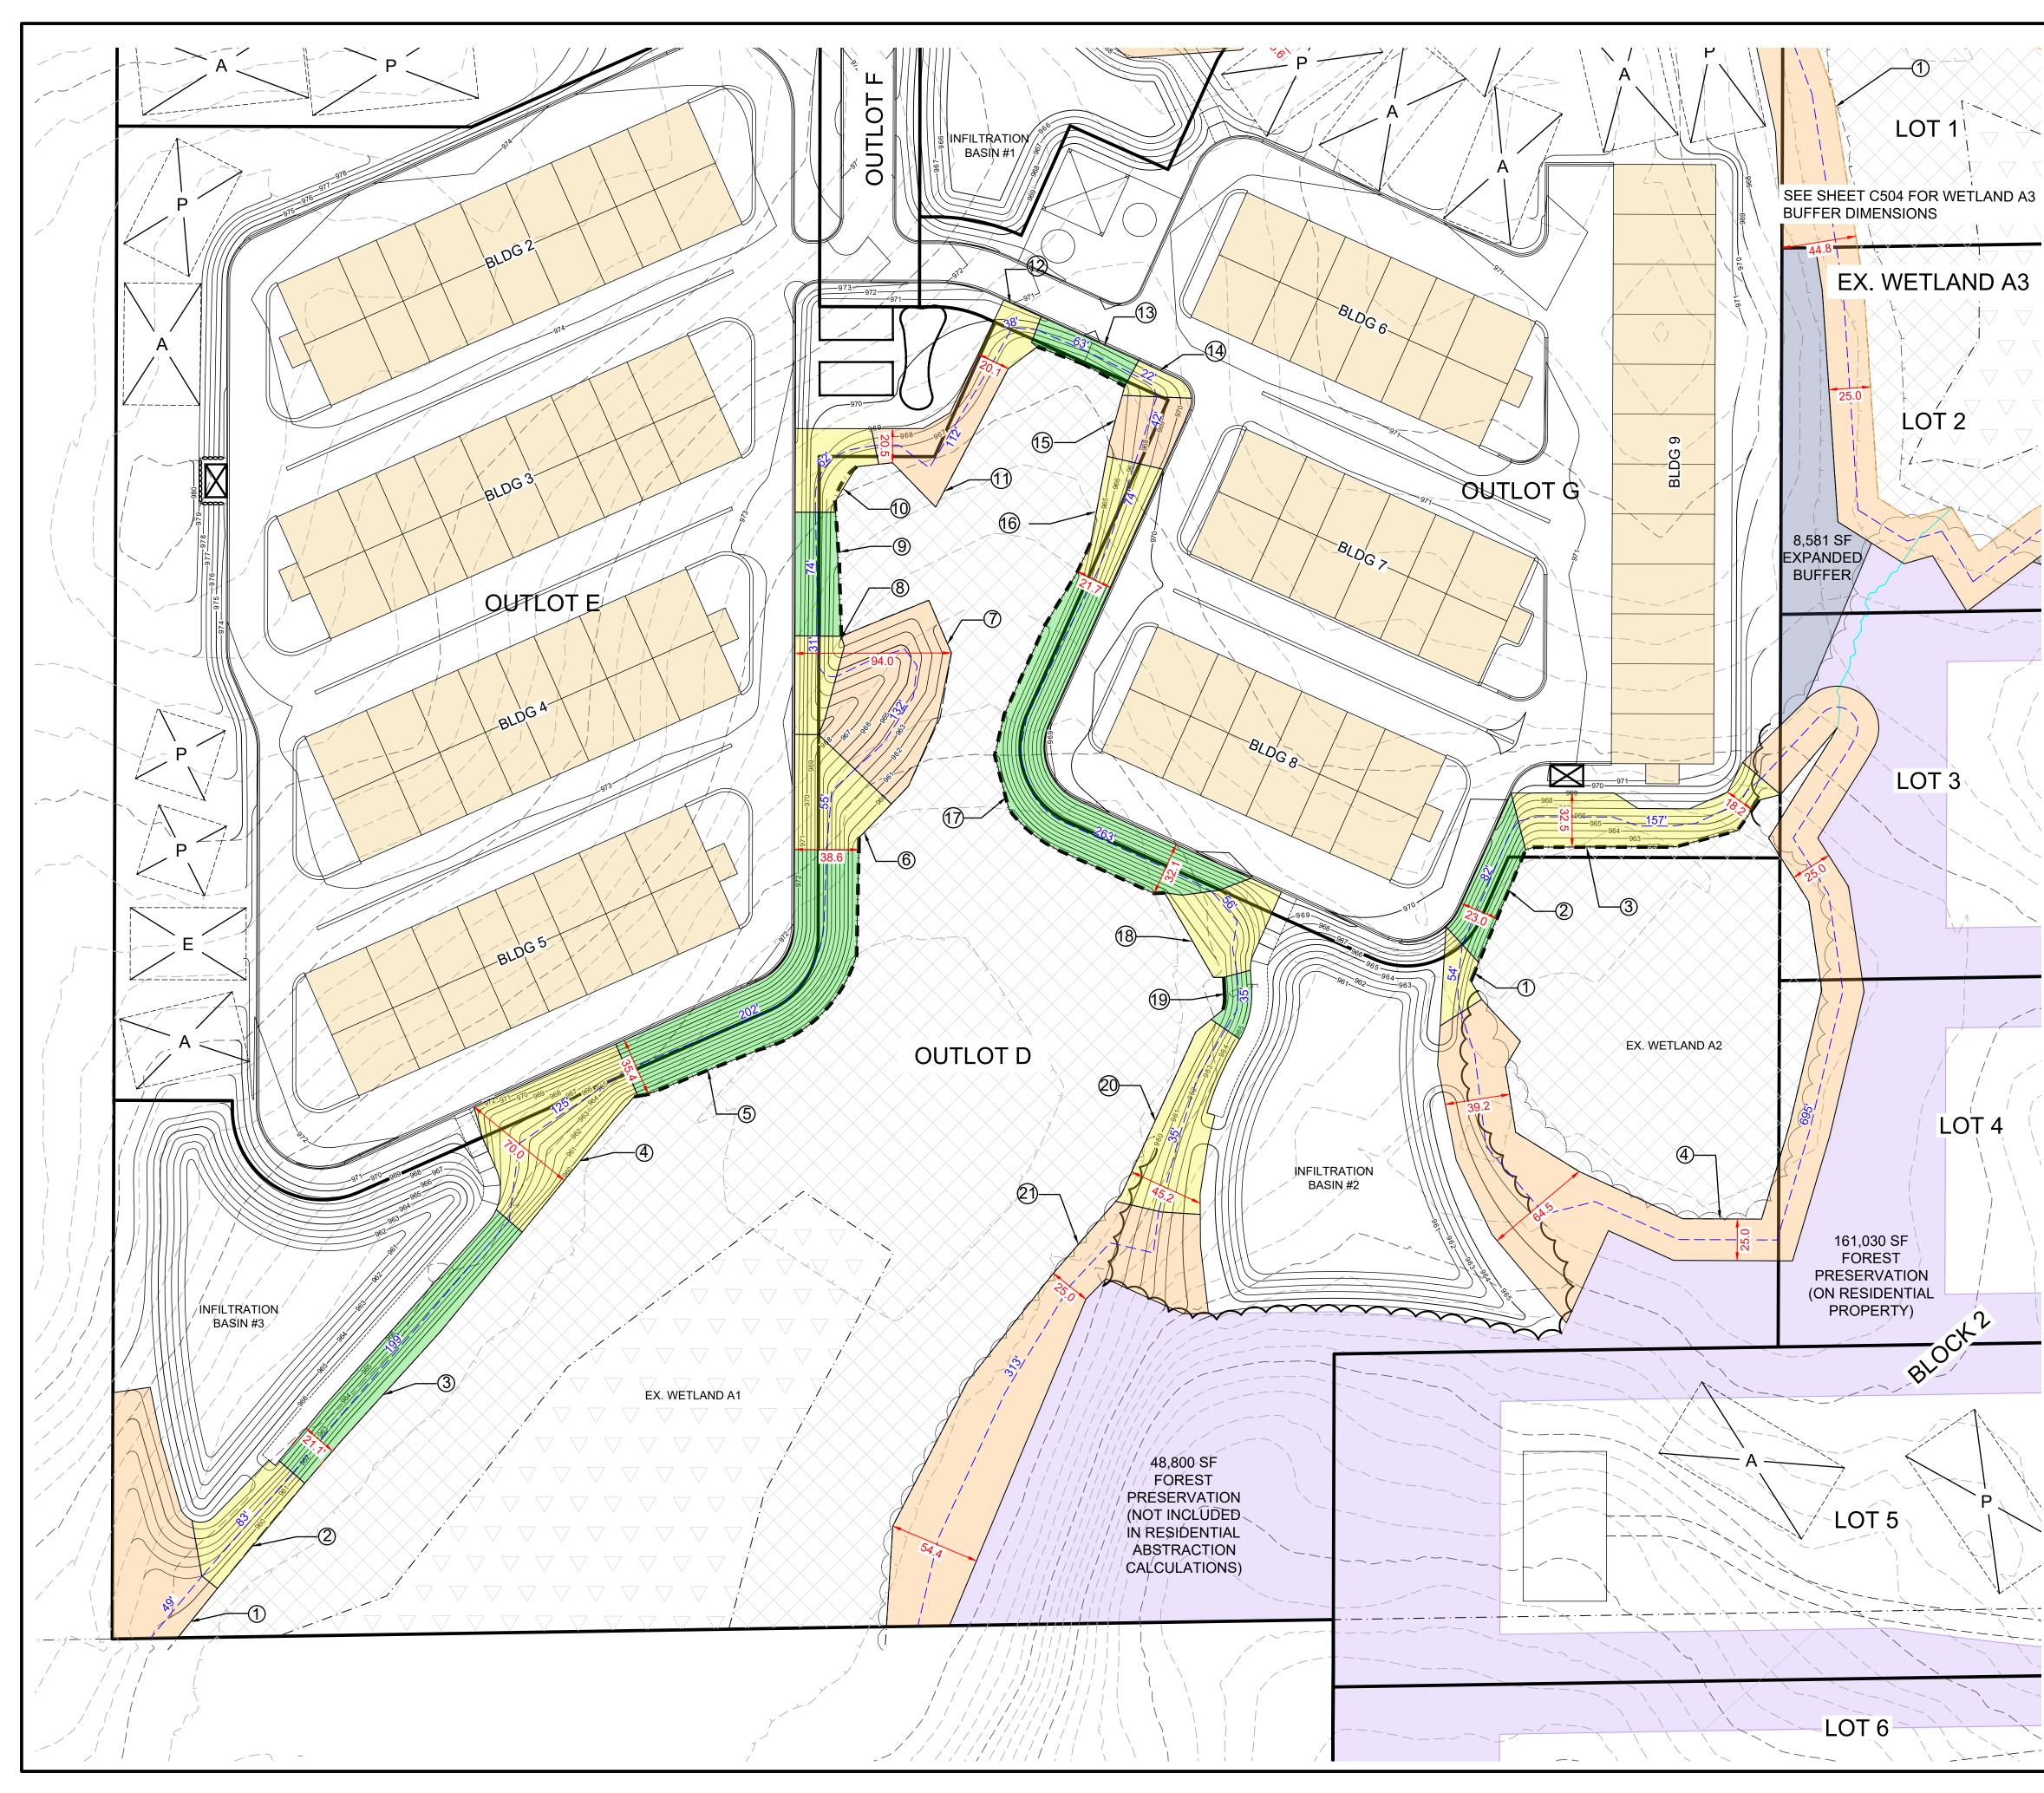


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	WETLAND BUFFER ZONE - 2.5:1 SLOPE AREA		
	WETLAND BUFFER ZONE - 6:1 SLOPE AREA		NRIDGE
XXX'	BUFFER ZONE LENGTH	FA	RM
XX.X'	BUFFER WIDTH AT SPECIFIC LOCATION		
\otimes	BUFFER SEGMENT ID		NDENCE,
	LINE OF MEASUREMENT FOR LENGTH OF BUFFER	MINNE	ESOTA
	EXPANDED WETLAND BUFFER		
	FOREST PRESERVATION	STODDARD	COMPANIES
	SEPTIC DRAIN FIELD		
	POTENTIAL HOUSE PAD LOCATION	REPORT WAS PREPARED BY SUPERVISION AND THAT I AM	IIS PLAN, SPECIFICATION, OR ME OR UNDER MY DIRECT A CERTIFIED PROFESSIONAL THE LAWS OF THE STATE OF
	EXISTING TREE CANOPY	PRINT NAME: <u>LEE KO</u>	РРҮ
~~~~~	PROPOSED TREE CANOPY	SIGNATURE:	LICENSE NO. <u>41267</u>
WFTI AND	BUFFER NOTES	REVISION LOG	
WETLAND BUFFE	ER SHALL MEET AVERAGE BUFFER E BELOW AND MUST BE A MINIMUM	NO. DATE DESCR	IPTION OF REVISIONS
_	HALL BE REQUIRED AT EACH		
BUFFER AND SH	IERE IT CROSSES A WETLAND ALL HAVE A MAXIMUM SPACING OF		
BUFFER. A MONU	THE EDGE OF THE WETLAND JMENT SHALL CONSIST OF A POST		
COMMISSION ST	BUFFER SIGN MEETING ANDARDS. THE SIGNS SHALL NGS ABOUT MOWING, R DEVELOPING THE WETLAND	FINAL	PLAT
BUFFER ZONE			WN: CHECKED BY:
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	DISTURBED BY GRADING JST BE FINISH GRADE TO A		
WIDTH OF FIVE (	R LESS OR AN INCREASE IN 5) FEET FOR EACH ONE (1) FOOT	WETI	LAND
	DRIZONTAL WIDTH		FER
<u>EXAMPLE</u> 2.5:1 = 42.5'			EMENT -
3:1 = 40'			<u>2</u>
4:1 = 35' 5:1 = 30'			
6:1 = 25'		DRAWING NO.	
MIN = 10'			
SEE SHEET C502 FOR AVERAGE WETLAND BUFFER WIDTH CALCULATIONS.		C504	
0	50' 100'	PLOTTED: 02/12/2024	COMM. NO. 16915

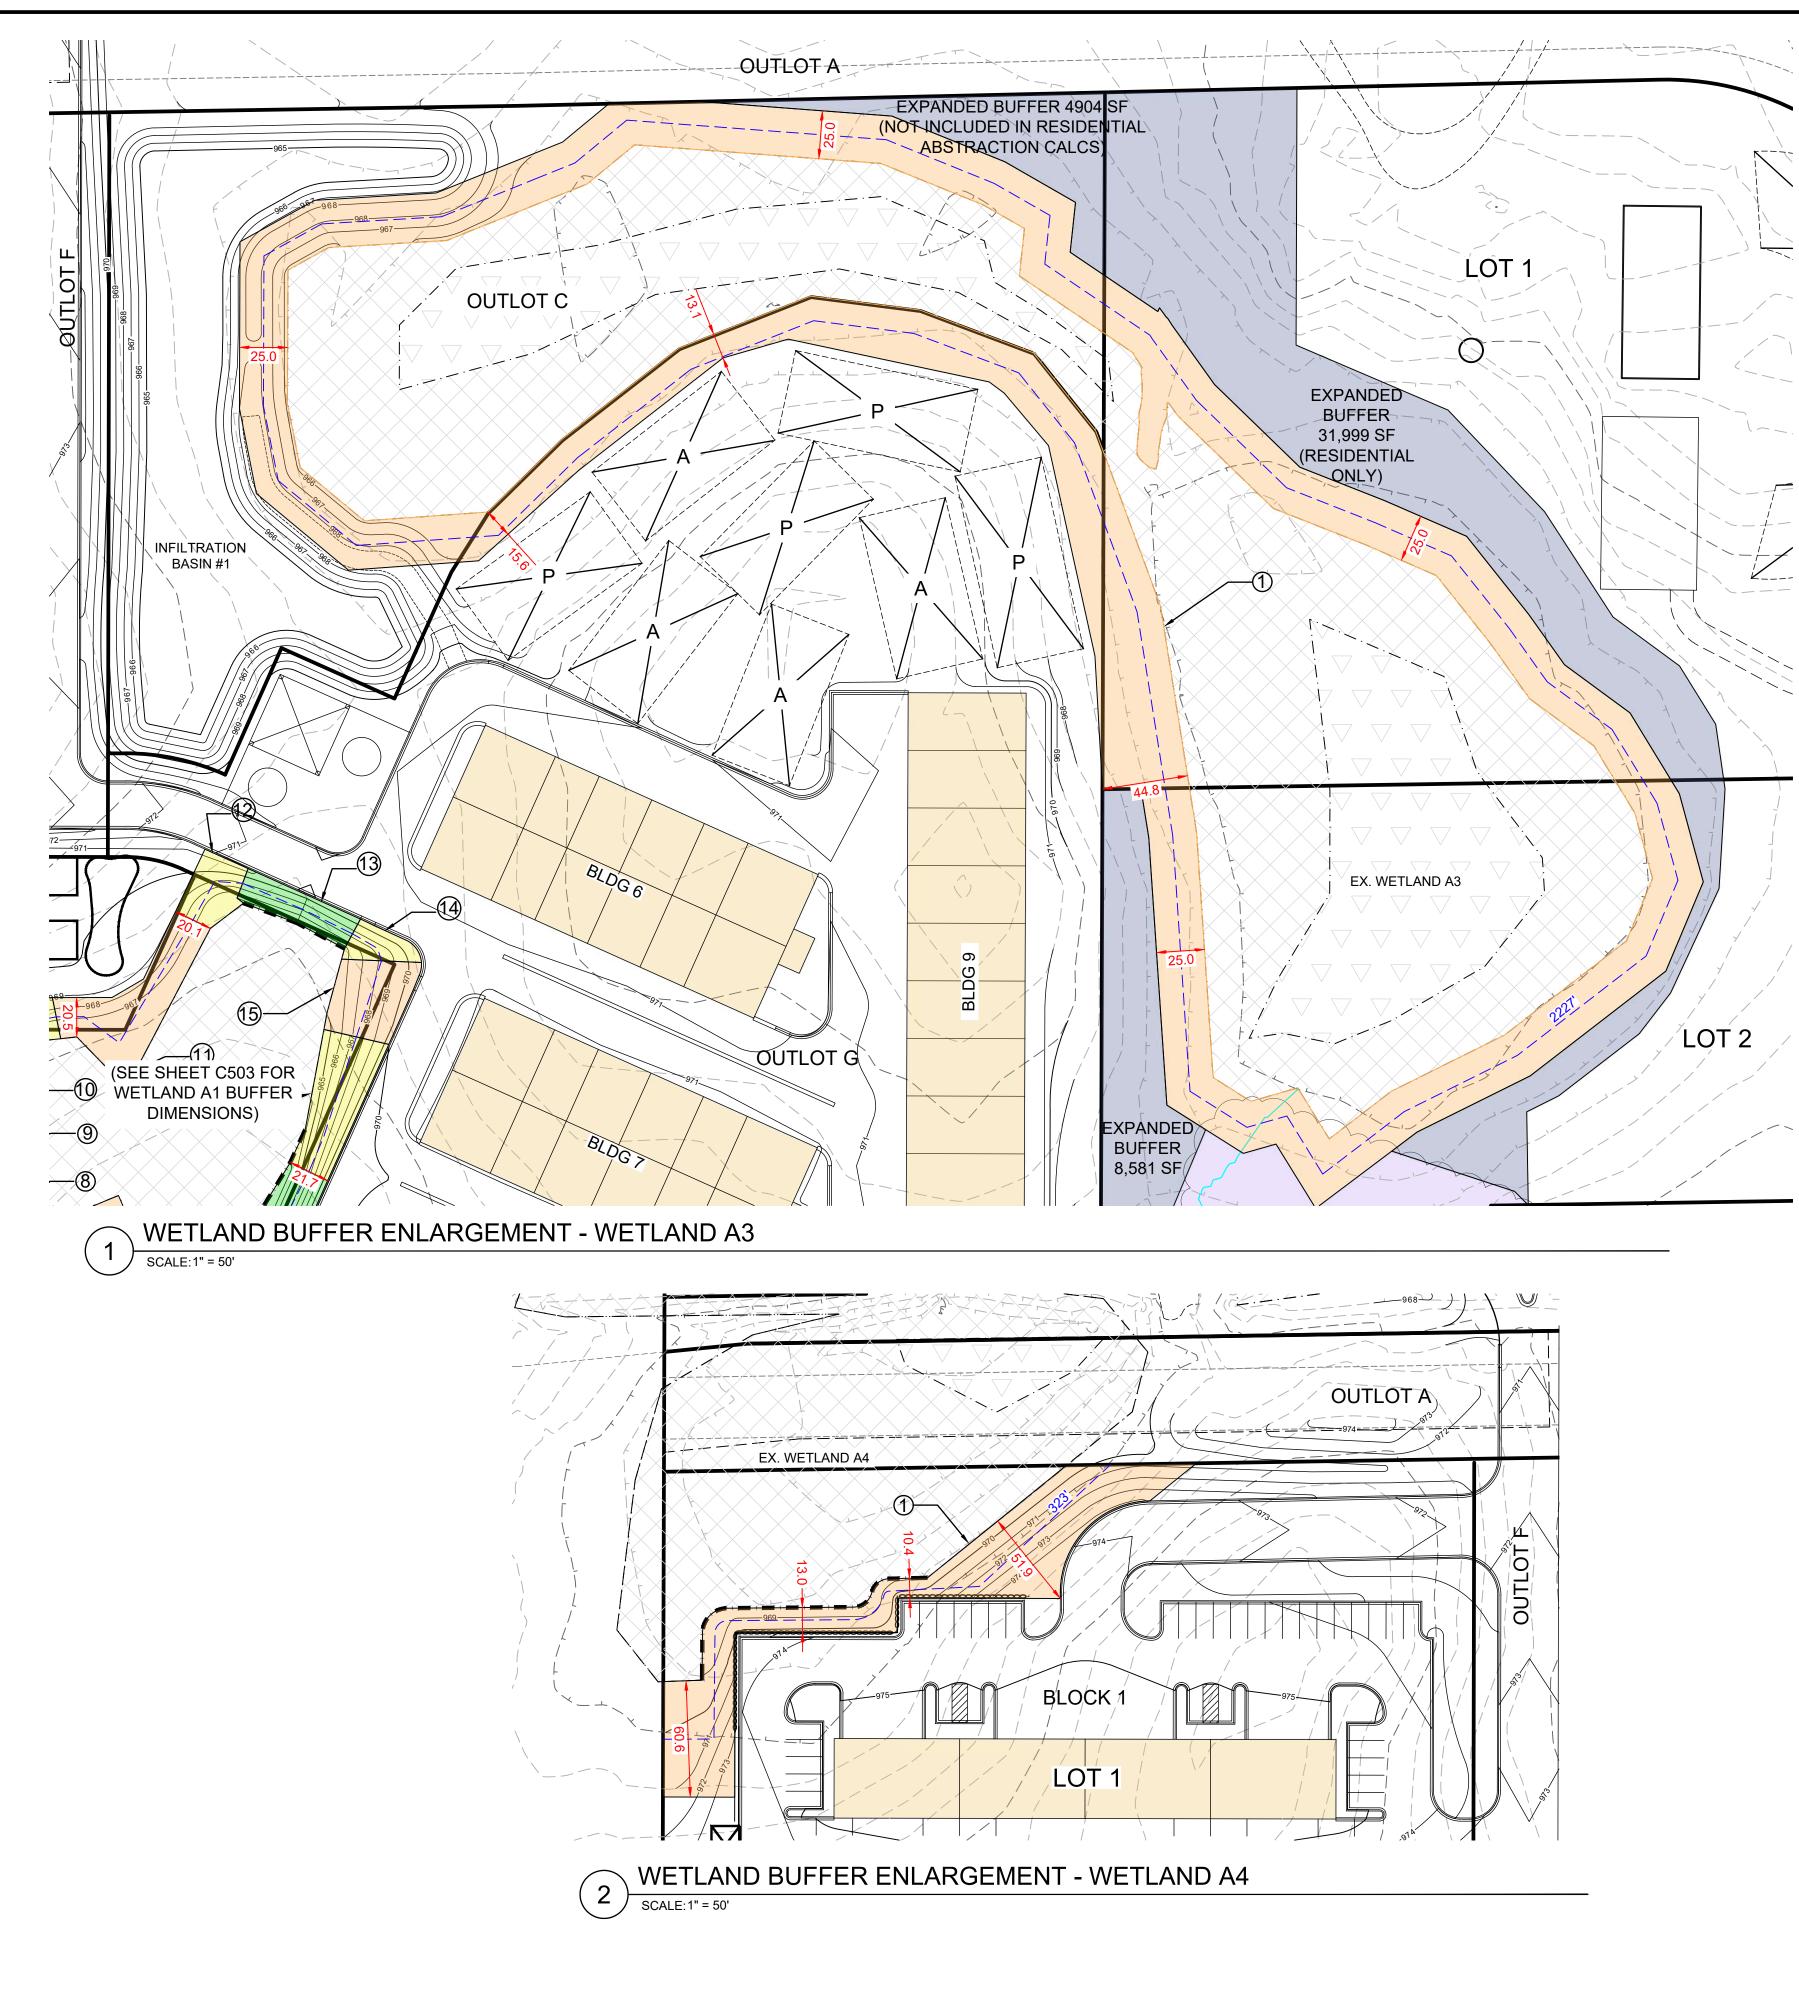

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LEGEND			
966 965 966	PROPERTY LIMITS EXISTING MINOR CONTOUR EXISTING MAJOR CONTOUR PROPOSED MINOR CONTOUR PROPOSED MAJOR CONTOUR	ANDE	RSON
	TYPE 1 WETLAND TYPE 2 WETLAND TYPE 3 WETLAND WETLAND BUFFER ZONE - TRANSITION SLOPE AREA	Plymouth, MN 55 P 763.412.4000	enue N. #100 5441   <b>ae-mn</b> .com   <b>F</b> 763.412.4090 ng of Minnesota, LLC
	WETLAND BUFFER ZONE - 2.5:1 SLOPE AREA		
	WETLAND BUFFER ZONE - 6:1 SLOPE AREA	BRECKE	NRIDGE
XXX'	BUFFER ZONE LENGTH	FA	RM
XX.X'	BUFFER WIDTH AT SPECIFIC LOCATION		
$\otimes$	BUFFER SEGMENT ID		NDENCE,
	LINE OF MEASUREMENT FOR LENGTH OF BUFFER	MINNE	ESOTA
	EXPANDED WETLAND BUFFER		
	FOREST PRESERVATION	STODDARD	COMPANIES
	SEPTIC DRAIN FIELD		
	POTENTIAL HOUSE PAD LOCATION	REPORT WAS PREPARED BY SUPERVISION AND THAT I AM	IIS PLAN, SPECIFICATION, OR ' ME OR UNDER MY DIRECT I A CERTIFIED PROFESSIONAL THE LAWS OF THE STATE OF
	EXISTING TREE CANOPY	PRINT NAME: LEE KO	PPY
~~~~~~	PROPOSED TREE CANOPY	SIGNATURE:	LICENSE NO. <u>41267</u>
WETLAND	BUFFER NOTES	REVISION LOG	
WETLAND BUFFE	ER SHALL MEET AVERAGE BUFFER E BELOW AND MUST BE A MINIMUM	NO. DATE DESCR	IPTION OF REVISIONS
	ALL BE REQUIRED AT EACH		
BUFFER AND SH/	IERE IT CROSSES A WETLAND ALL HAVE A MAXIMUM SPACING OF		
BUFFER. A MONU	THE EDGE OF THE WETLAND JMENT SHALL CONSIST OF A POST		
COMMISSION ST	BUFFER SIGN MEETING ANDARDS. THE SIGNS SHALL NGS ABOUT MOWING,	FINAL	PLAT
DISTRIBUTING OI BUFFER ZONE	R DEVELOPING THE WETLAND	DESIGNED: DRA	WN: CHECKED BY:
DESIGN CF	RITERIA		AM LRK
	DISTURBED BY GRADING	DRAWING TITLE	
SLOPE OF 6:1 OF	R LESS OR AN INCREASE IN 5) FEET FOR EACH ONE (1) FOOT		
	DRIZONTAL WIDTH		
<u>EXAMPLE</u> 2.5:1 = 42.5'		_	FER
3:1 = 40'			EMENT - 3
4:1 = 35'			
5:1 = 30' 6:1 = 25'		DRAWING NO.	
MIN = 10'		Divivino no.	
SEE SHEET C502 BUFFER WIDTH C	FOR AVERAGE WETLAND CALCULATIONS.	C5	505
		PLOTTED: 02/12/2024	COMM. NO. 16915

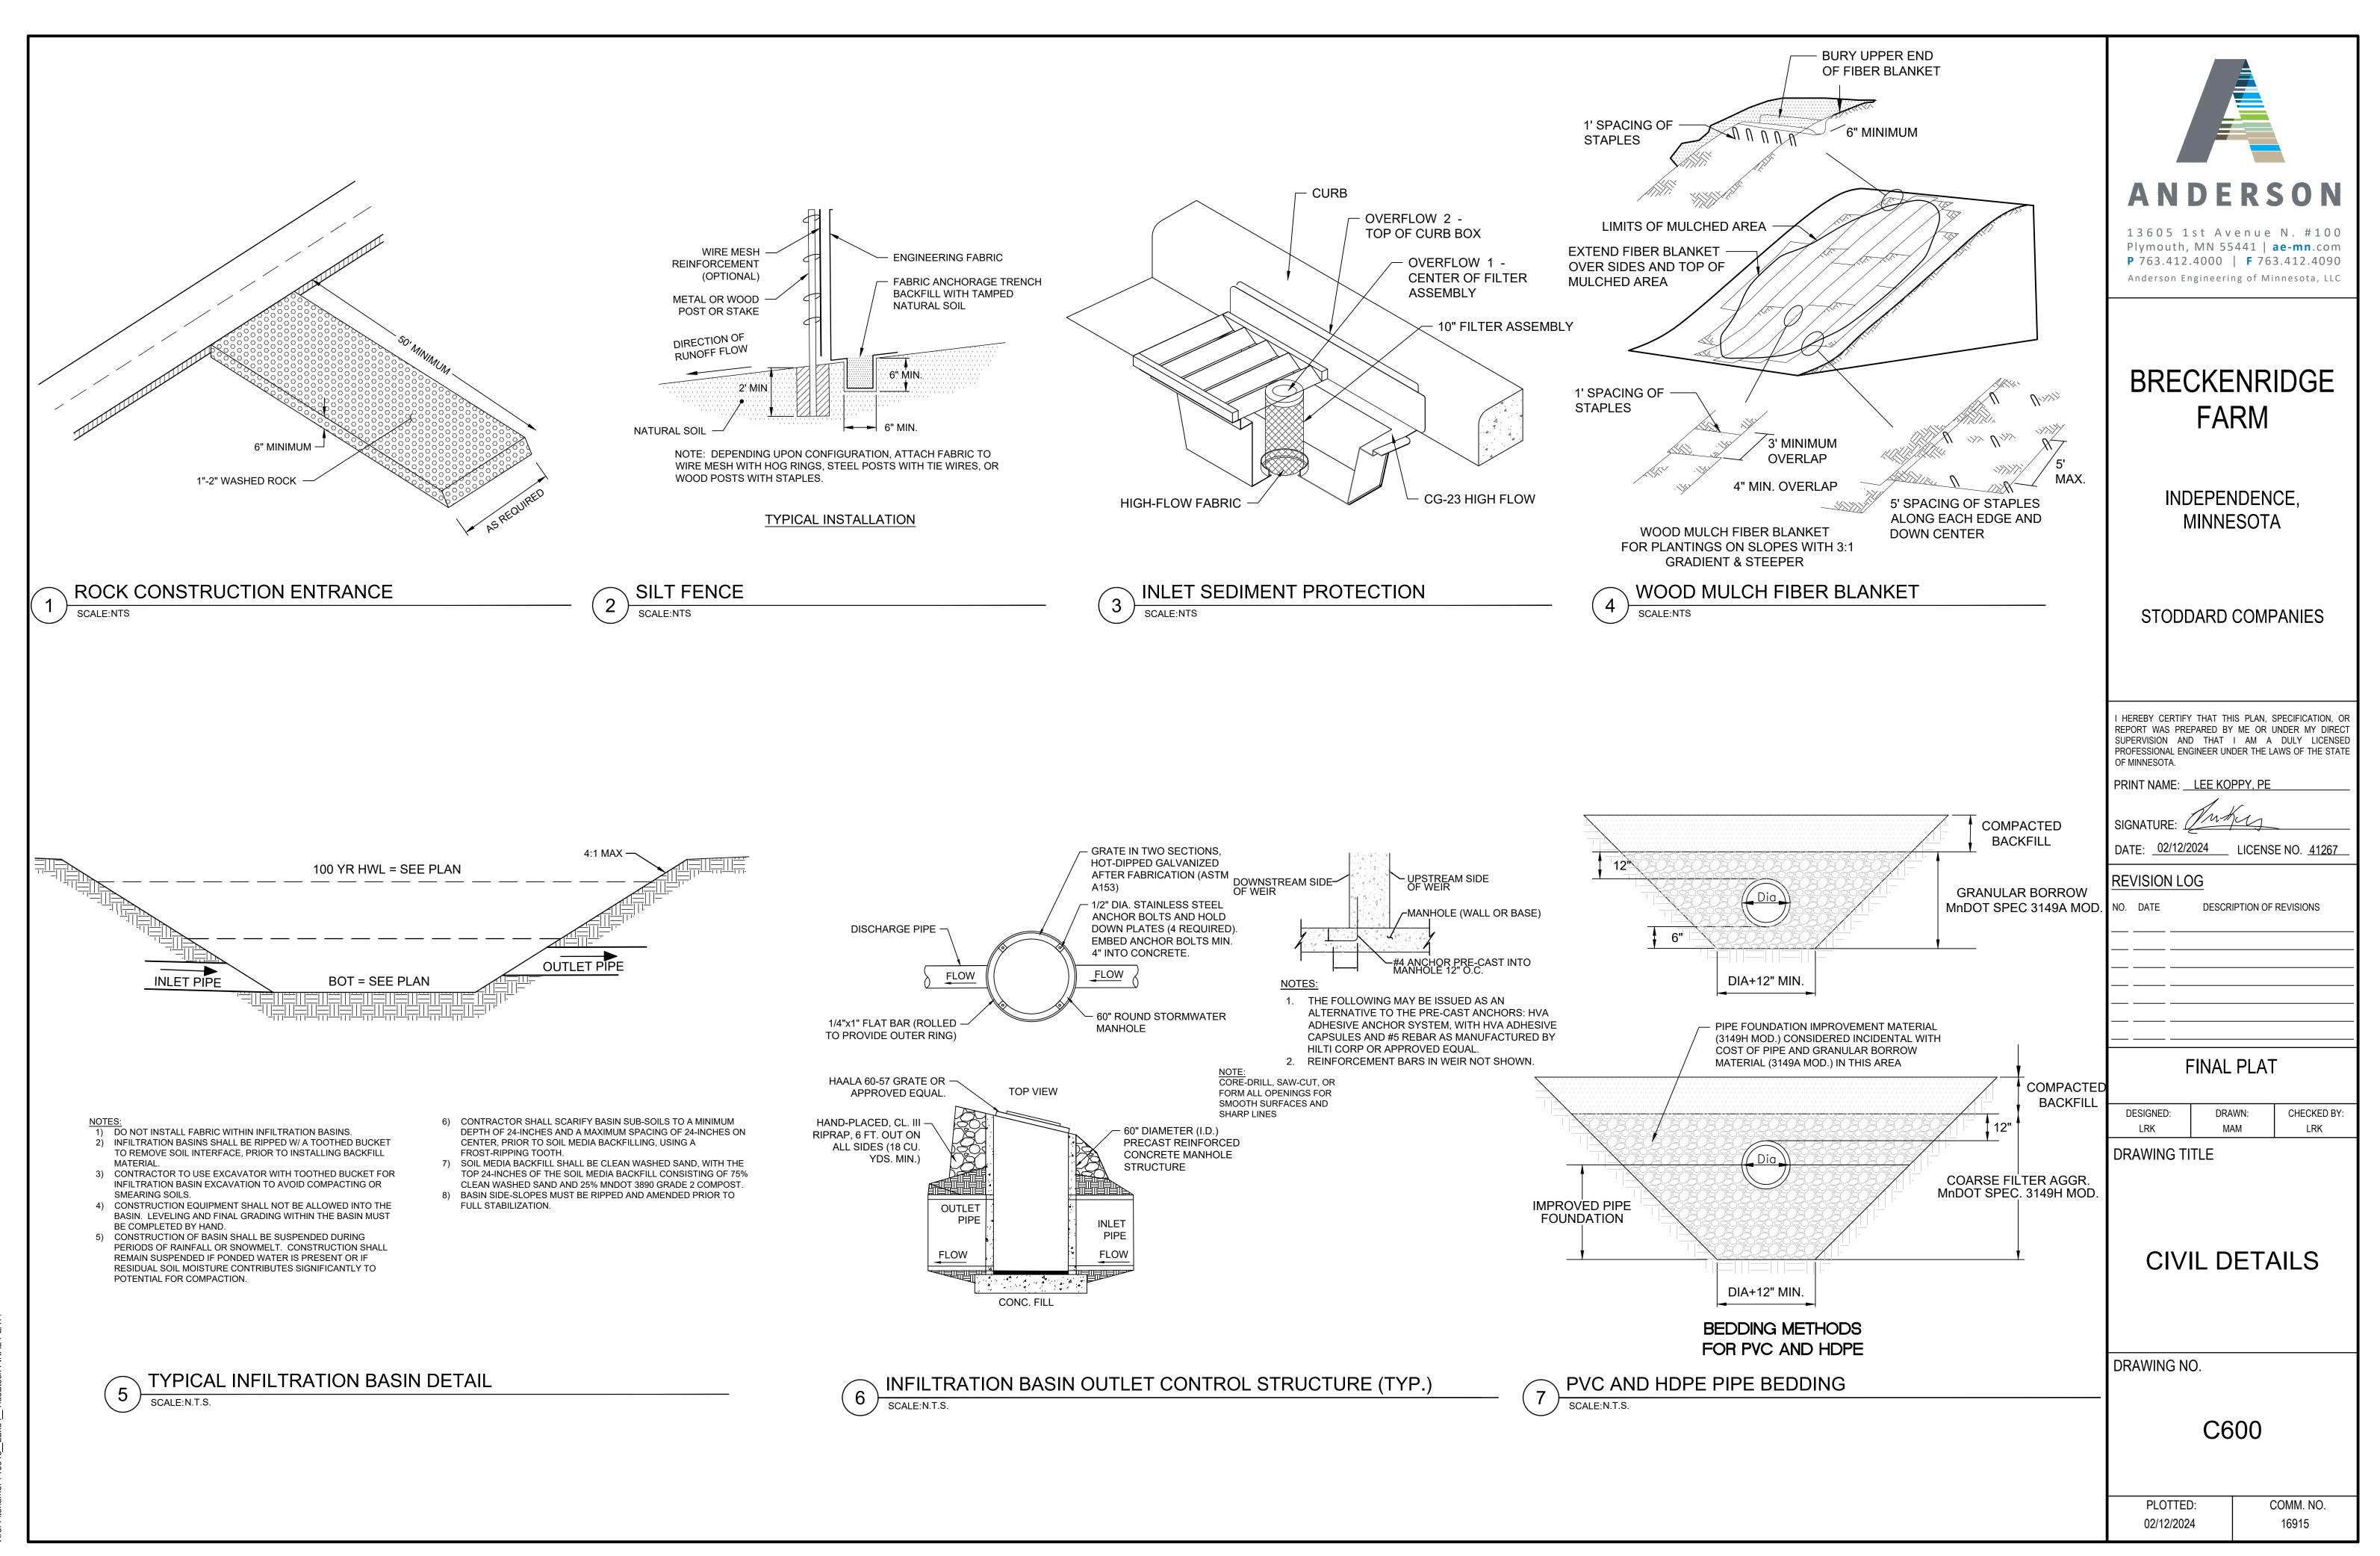

MANHOLE CASTING - NEENAH


TYPE II COVER SLAB (4000 P.S.I.)

MANHOLE MUST MEET ASTM 478

STEPS TO MEET ASTM 478

PRECAST CONCRETE BASE (3000 P.S.I.)



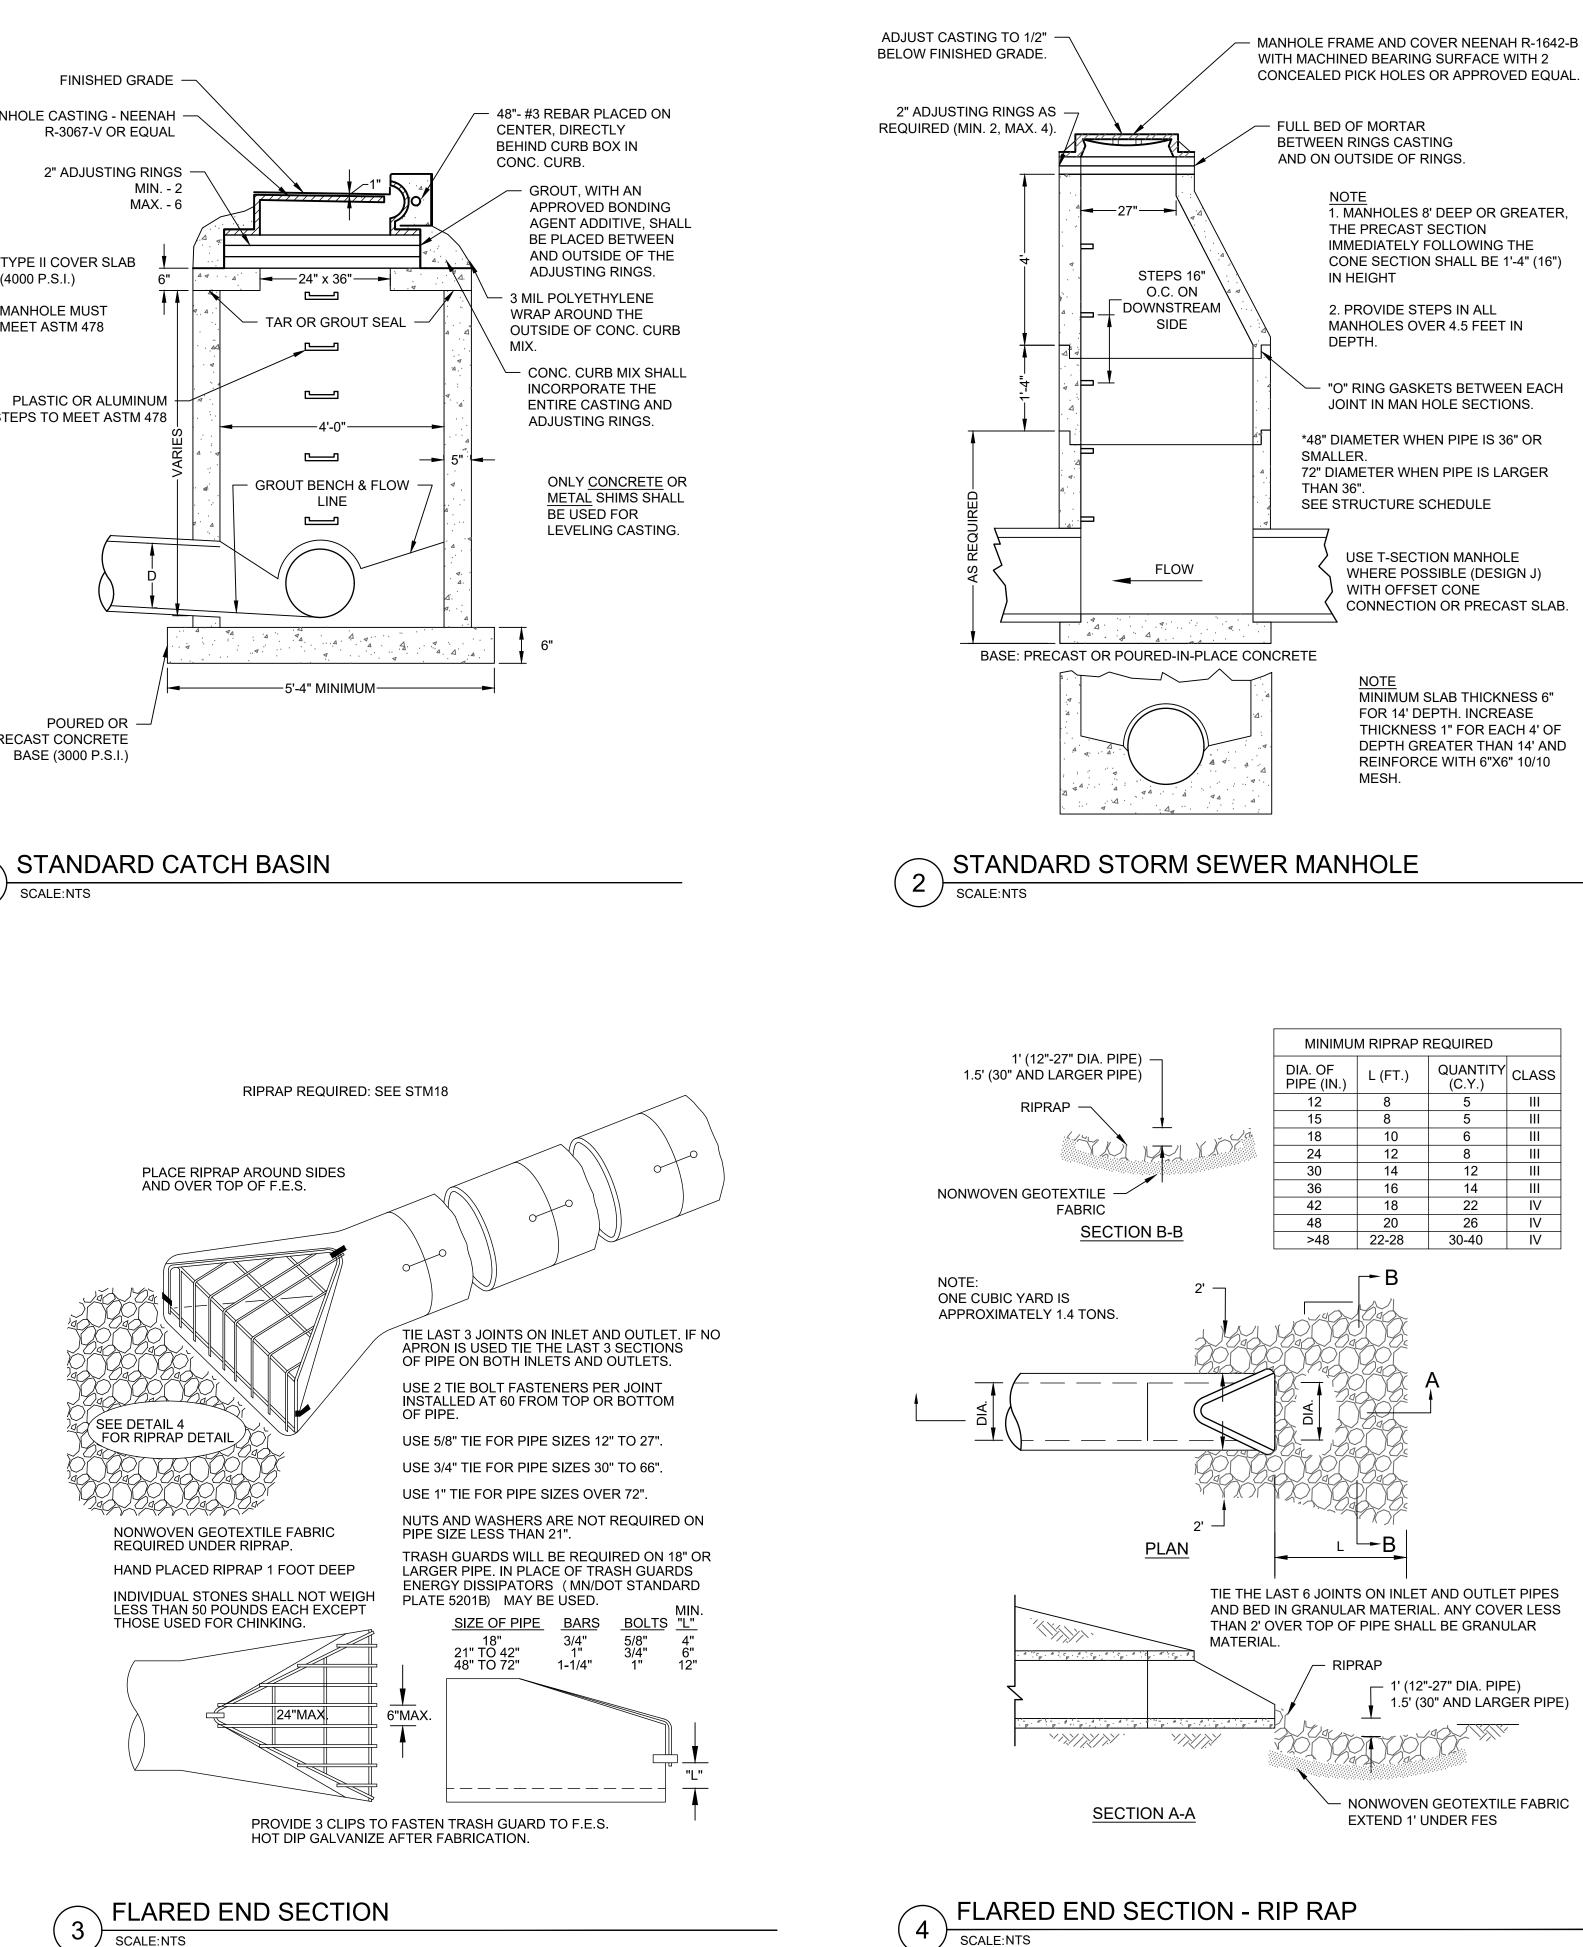



MINIMUM RIPRAP REQUIRED				
DIA. OF PIPE (IN.)	L (FT.)	QUANTITY (C.Y.)	CLASS	
12	8	5		
15	8	5		
18	10	6		
24	12	8		
30	14	12		
36	16	14		
42	18	22	IV	
48	20	26	IV	
>48	22-28	30-40	IV	



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BRECKENRIDGE FARM

INDEPENDENCE, MINNESOTA

STODDARD COMPANIES

PRINT NAME:	LEE KOPPY,	PE

SIGNATURE:

DATE: <u>02/12/2024</u> LICENSE NO. <u>41267</u>

REVISION LOG

NO. DATE DESCRIPTION OF REVISIONS

FINAL PLAT


DESIGNED:	DRAWN:	CHECKED BY:				
LRK	MAM	LRK				
DRAWING TITLE						
CIVIL DETAILS						
DRAWING NO.						
C601						

COMM. NO.


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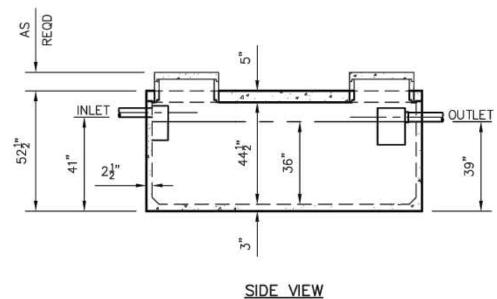
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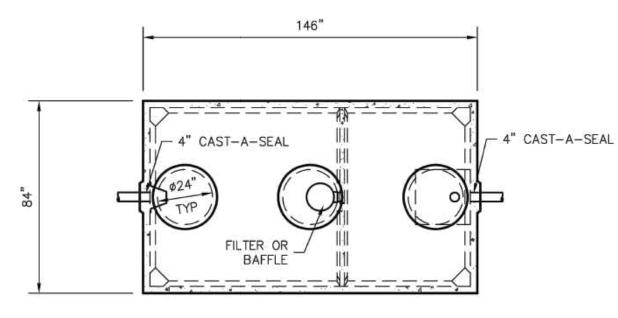







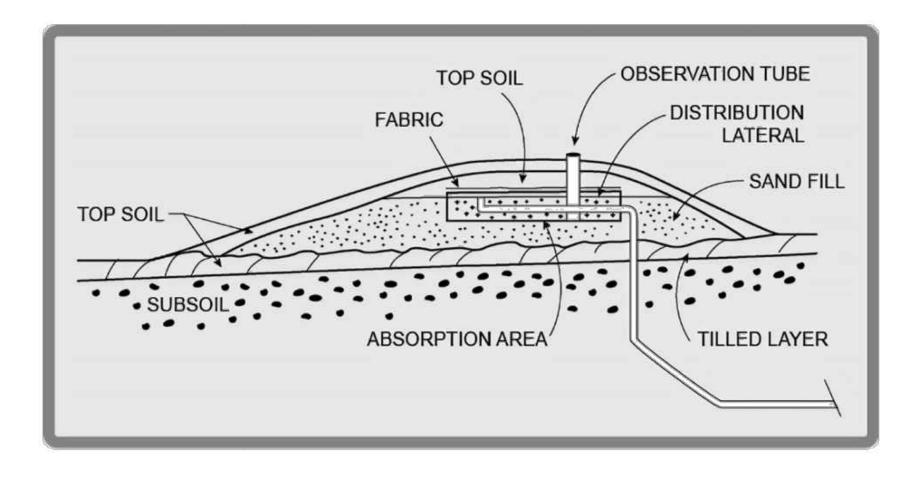


SEPTIC TANK - 1,250 GALLON 3 SCALE:NTS

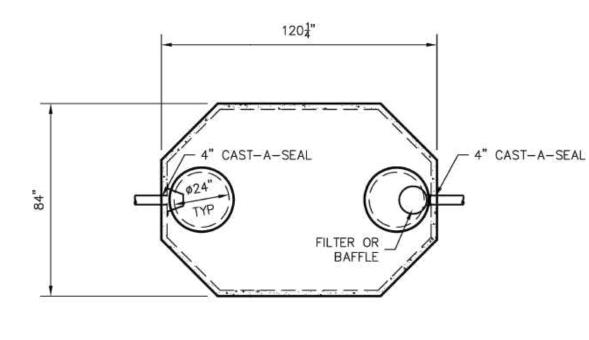


TOP VIEW

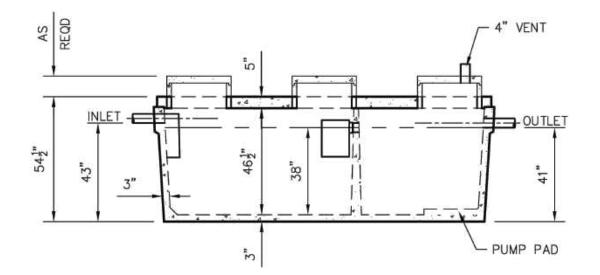

SEPTIC TANK - 1,500 GALLON 2 SCALE:NTS

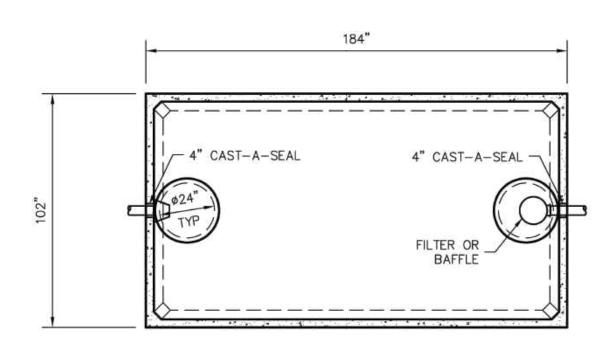

TOP VIEW

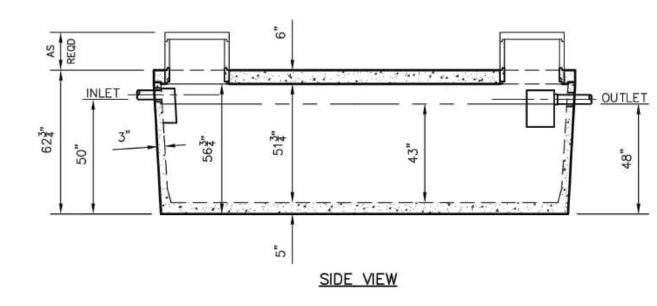

PUMP TANK - 3,000 GALLON 4

SCALE:NTS

TANK SPECIFICATIONS

DIMENSIONS: WALL: 2 1/2" BOTTOM: SEPTIC 3" COVER: 5" MANHOLE: 24" I.D. PRECAST CONCRETE RISER HEIGHT: 52 1/2" O.D. LENGTH: 120 1/4" O.D. WIDTH: 84" O.D. BELOW INLET: 41" O.D. LIQUID LEVEL: 36" WEIGHT: 8,810 LBS.

INLET AND OUTLET: 4" CAST-A-SEAL BOOT OR EQUAL GASKET, CAST-A-SEAL BOOT OR EQUAL

LIQUID CAPACITY: 34.81 GAL/IN HOLDING TANK: OUTLET HOLE PLUGGED ACTUAL CAPACITY: 1,323 GALLONS LOADING DESIGN: 8' 0" UNSATURATED SOIL

TANK CAN BE USED AS: SEPTIC/ HOLDING/ PUMP OR SIPHON COVER: MIX DESIGN #8 (NO FIBER) TANK: MIX DESIGN #10 (STRUCTURAL FIBER)

TANK SPECIFICATIONS

DIMENSIONS: WALL: 3" BOTTOM: 3" COVER: 5" MANHOLE: 24" I.D. PRECAST CONCRETE RISEF HEIGHT: 54 1/2" O.D. LENGTH: 146" O.D. WIDTH: 84" O.D. BELOW INLET: 43" O.D. LIQUID LEVEL: 38" WEIGHT: 14,940 LBS. INLET AND OUTLET: 4" CAST-A-SEAL BOOT OR EQUAL GASKET, CAST-A-SEAL BOOT OR EQUAL

LIQUID CAPACITY: 26.32 GAL/IN (SEPTIC) 17.00 GAL/IN (PUMP)

LOADING DESIGN: 8' O" UNSATURATED SOIL

TANK CAN BE USED AS: SEPTIC/SEPTIC, SEPTIC/ PUMP OR SEPTIC/SIPHON COVER: MIX DESIGN #8 (NO FIBER) TANK: MIX DESIGN #10 (STRUCTURAL FIBER) CUSTOMIZED TANKS:

FOR CUSTOM TANKS CONTACT WESER CONCRETE


TANK SPECIFICATIONS

DIMENSIONS: WALL: 3" BOTTOM: 5" COVER: 6 MANHOLE: 24" I.D. PRECAST CONCRETE RISER HEIGHT: 62-3/4" O.D. LENGTH: 184" O.D. WIDTH: 102" O.D. BELOW INLET: 50" O.D. LIQUID LEVEL: 43" WEIGHT: TANK - BOTTOM 15,980 LBS. COVER 9,300 LBS.


INLET AND OUTLET: 4" CAST-A-SEAL BOOT OR EQUAL


LIQUID CAPACITY: 69.77 GAL/IN HOLDING TANK: OUTLET HOLE PLUGGED ACTUAL CAPACITY: 3,140 GALLONS LOADING DESIGN: 8' 0" UNSATURATED SOIL TANK CAN BE USED AS: SEPTIC/ HOLDING/ PUMP OR SIPHON

COVER: MIX DESIGN #8 (NO FIBER) TANK: MIX DESIGN #9 (SMALL FIBER) CUSTOMIZED TANKS: FOR CUSTOM TANKS CONTACT WESER CONCRETE

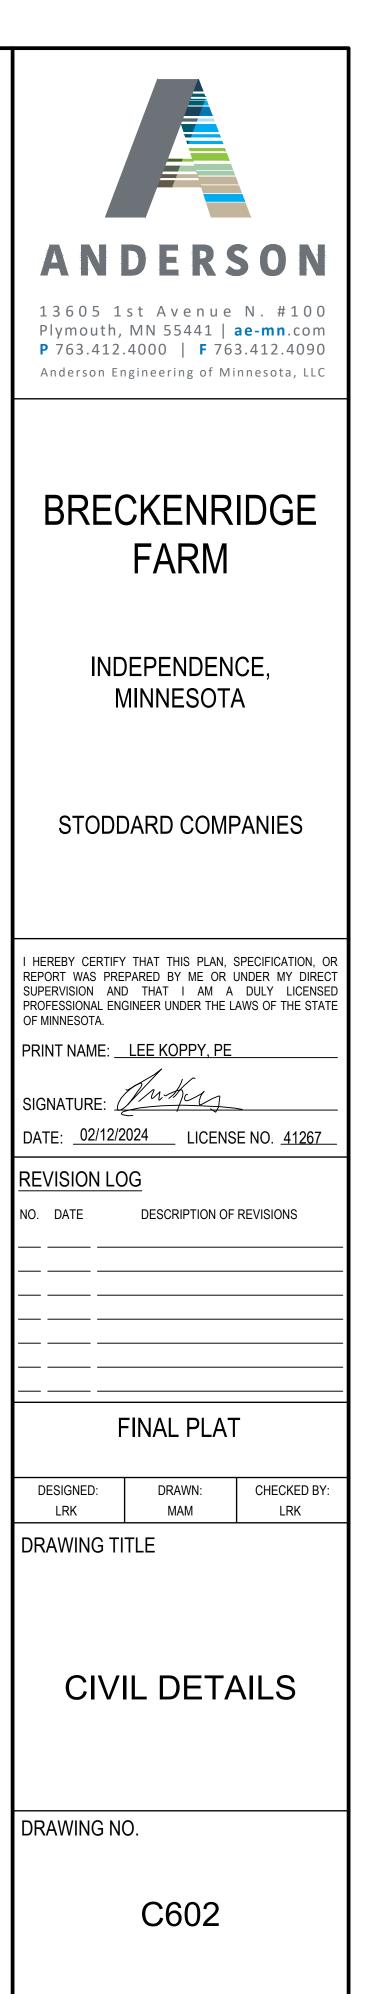


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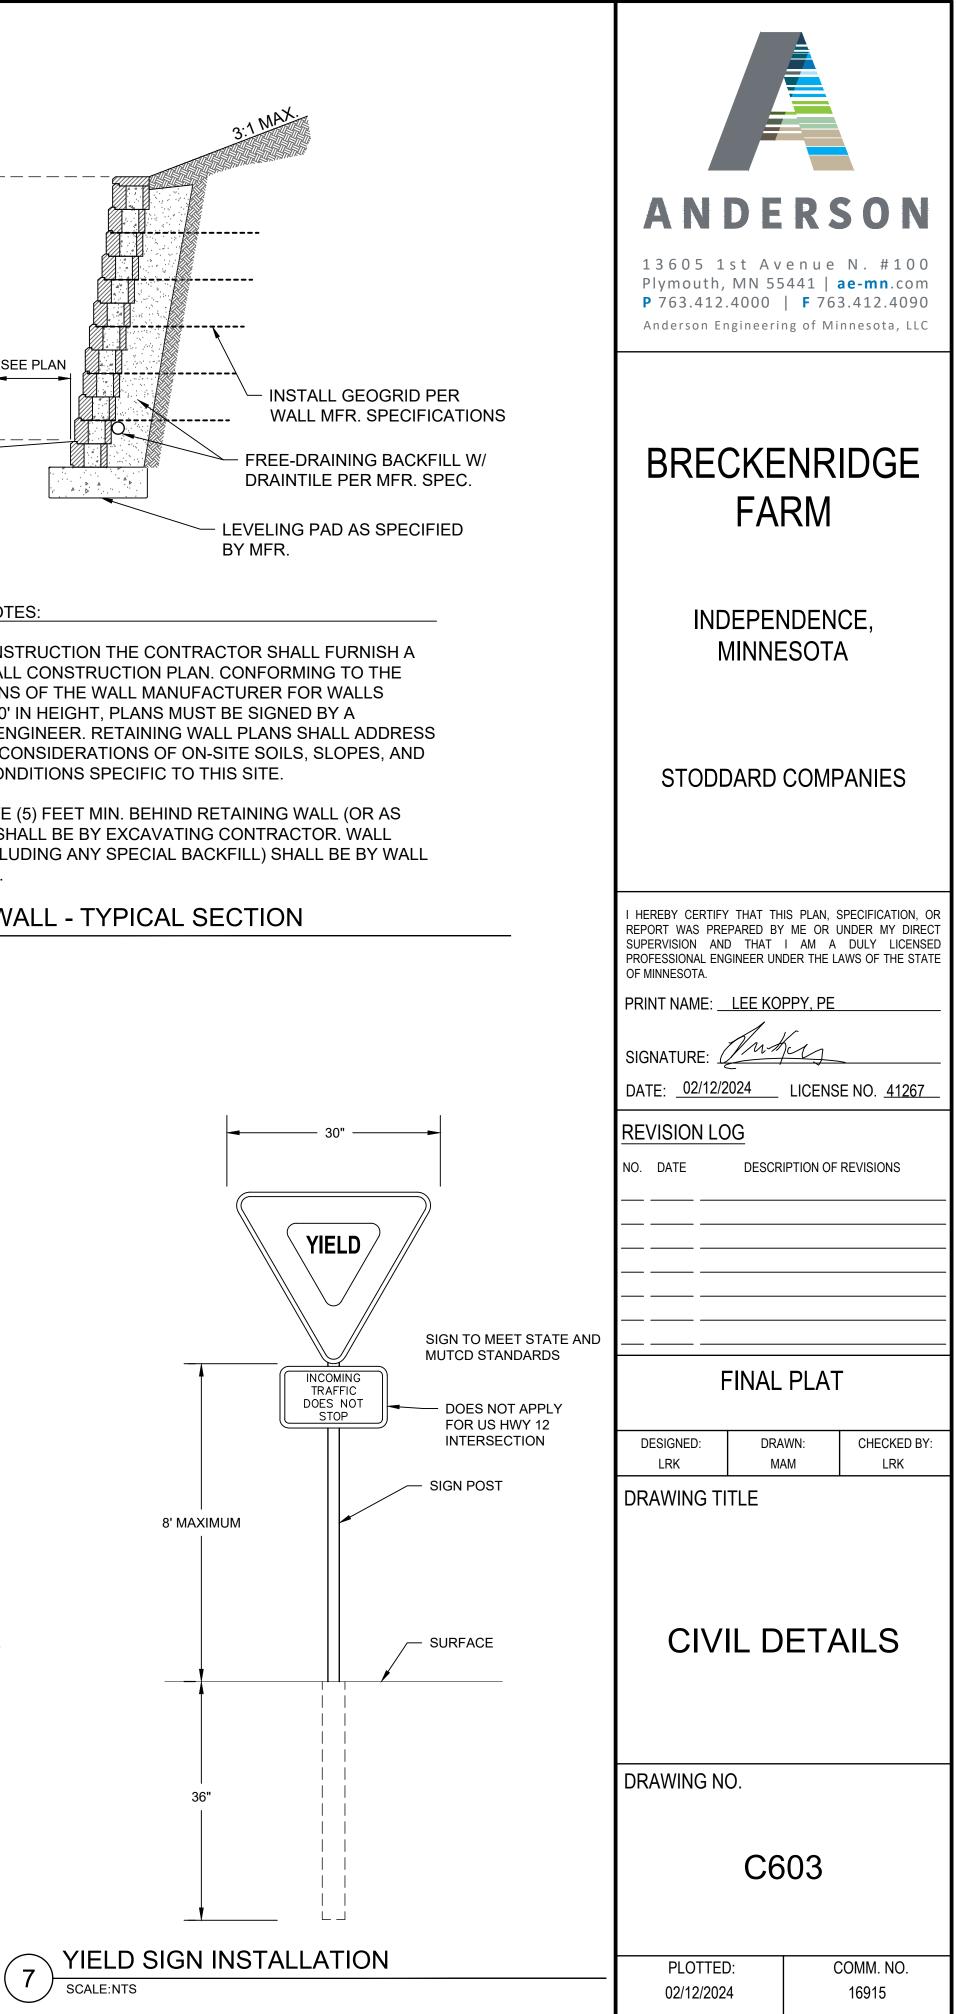


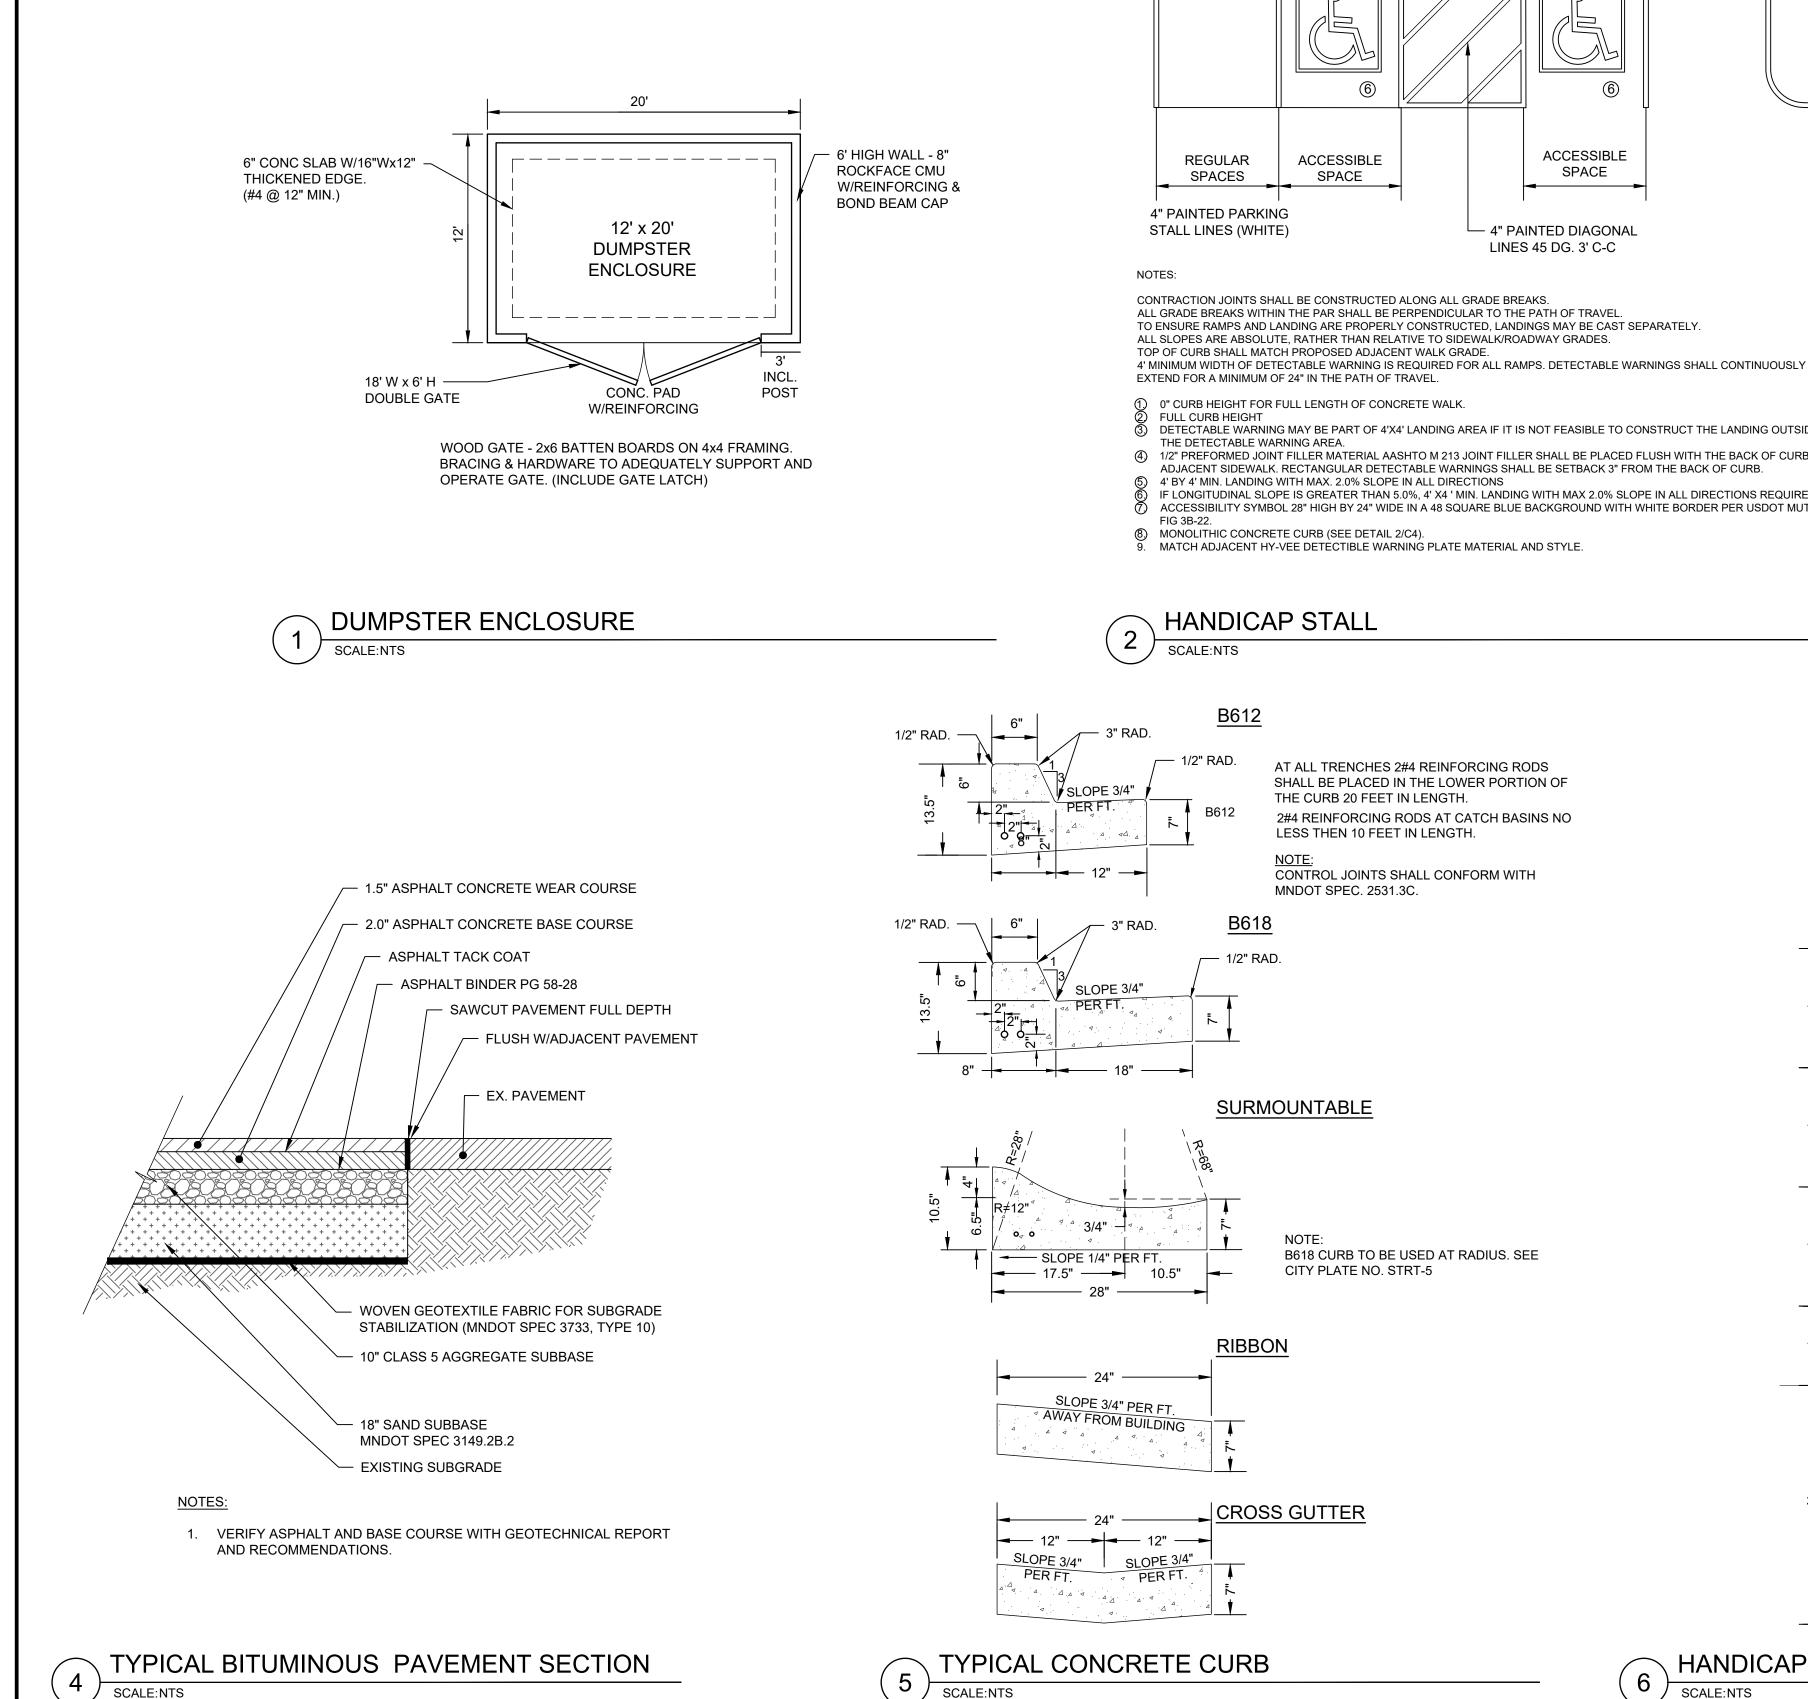
ALL GRADE BREAKS WITHIN THE PAR SHALL BE PERPENDICULAR TO THE PATH OF TRAVEL.

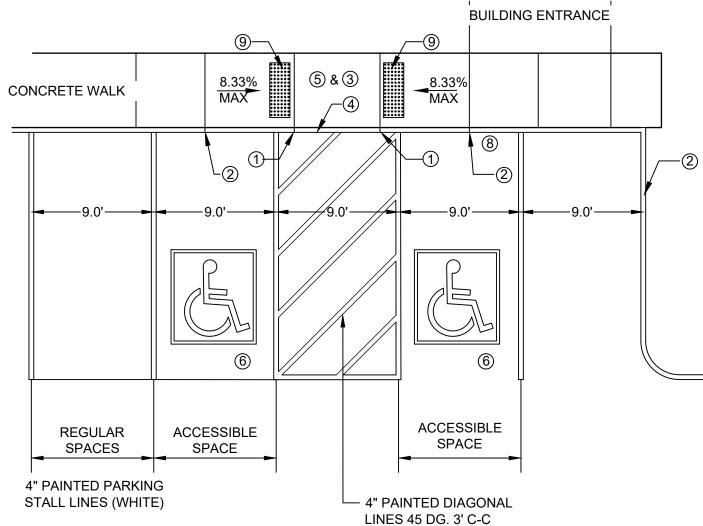
- DETECTABLE WARNING MAY BE PART OF 4'X4' LANDING AREA IF IT IS NOT FEASIBLE TO CONSTRUCT THE LANDING OUTSIDE OF
- 4) 1/2" PREFORMED JOINT FILLER MATERIAL AASHTO M 213 JOINT FILLER SHALL BE PLACED FLUSH WITH THE BACK OF CURB AND ADJACENT SIDEWALK. RECTANGULAR DETECTABLE WARNINGS SHALL BE SETBACK 3" FROM THE BACK OF CURB.
-) IF LONGITUDINAL SLOPE IS GREATER THAN 5.0%, 4' X4 ' MIN. LANDING WITH MAX 2.0% SLOPE IN ALL DIRECTIONS REQUIRED. ACCESSIBILITY SYMBOL 28" HIGH BY 24" WIDE IN A 48 SQUARE BLUE BACKGROUND WITH WHITE BORDER PER USDOT MUTCD





HANDICAPPED SIGN INSTALLATION 6) SCALE:NTS

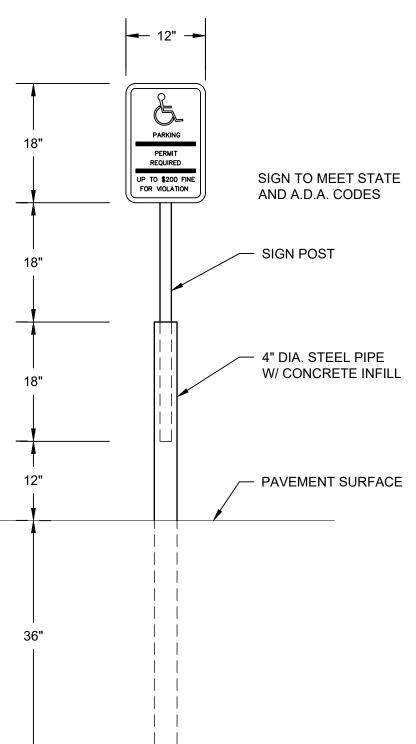

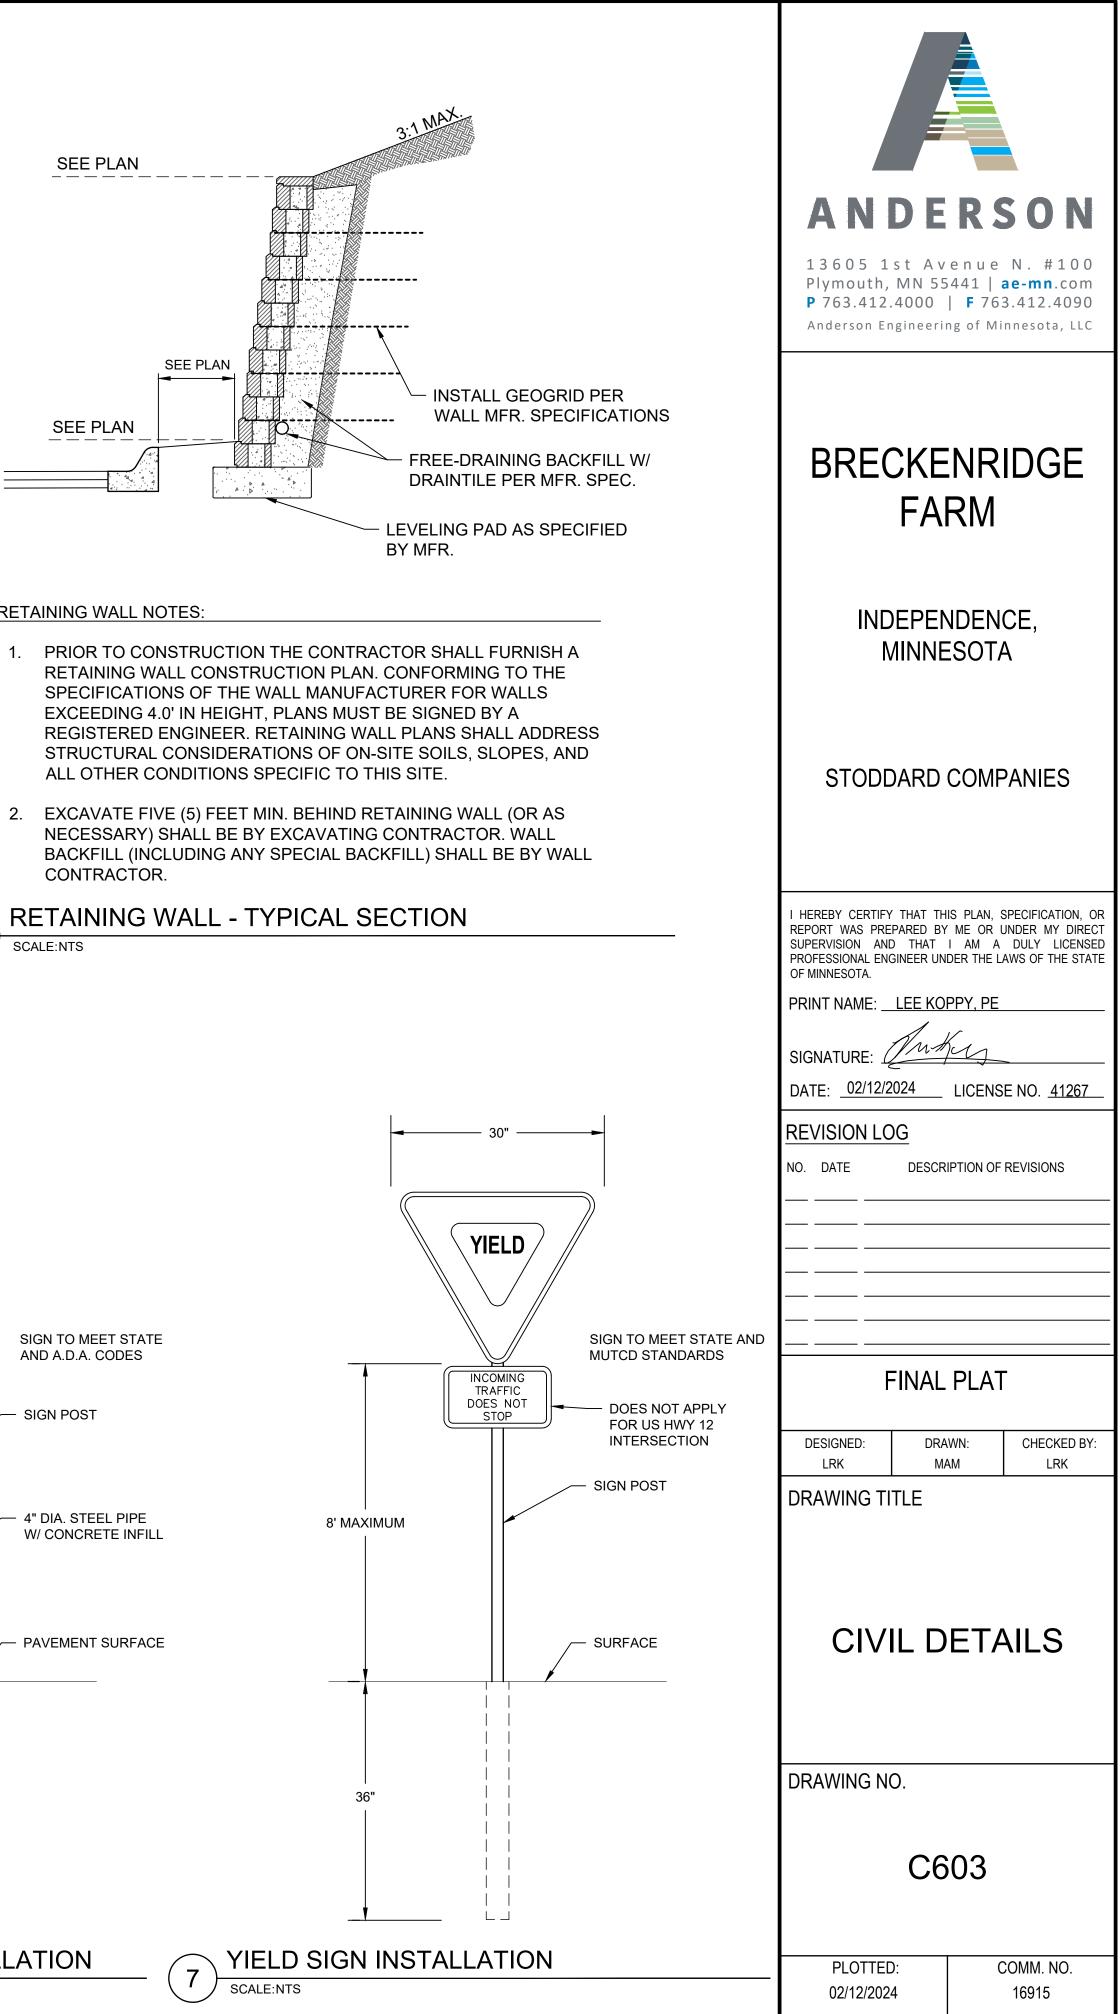

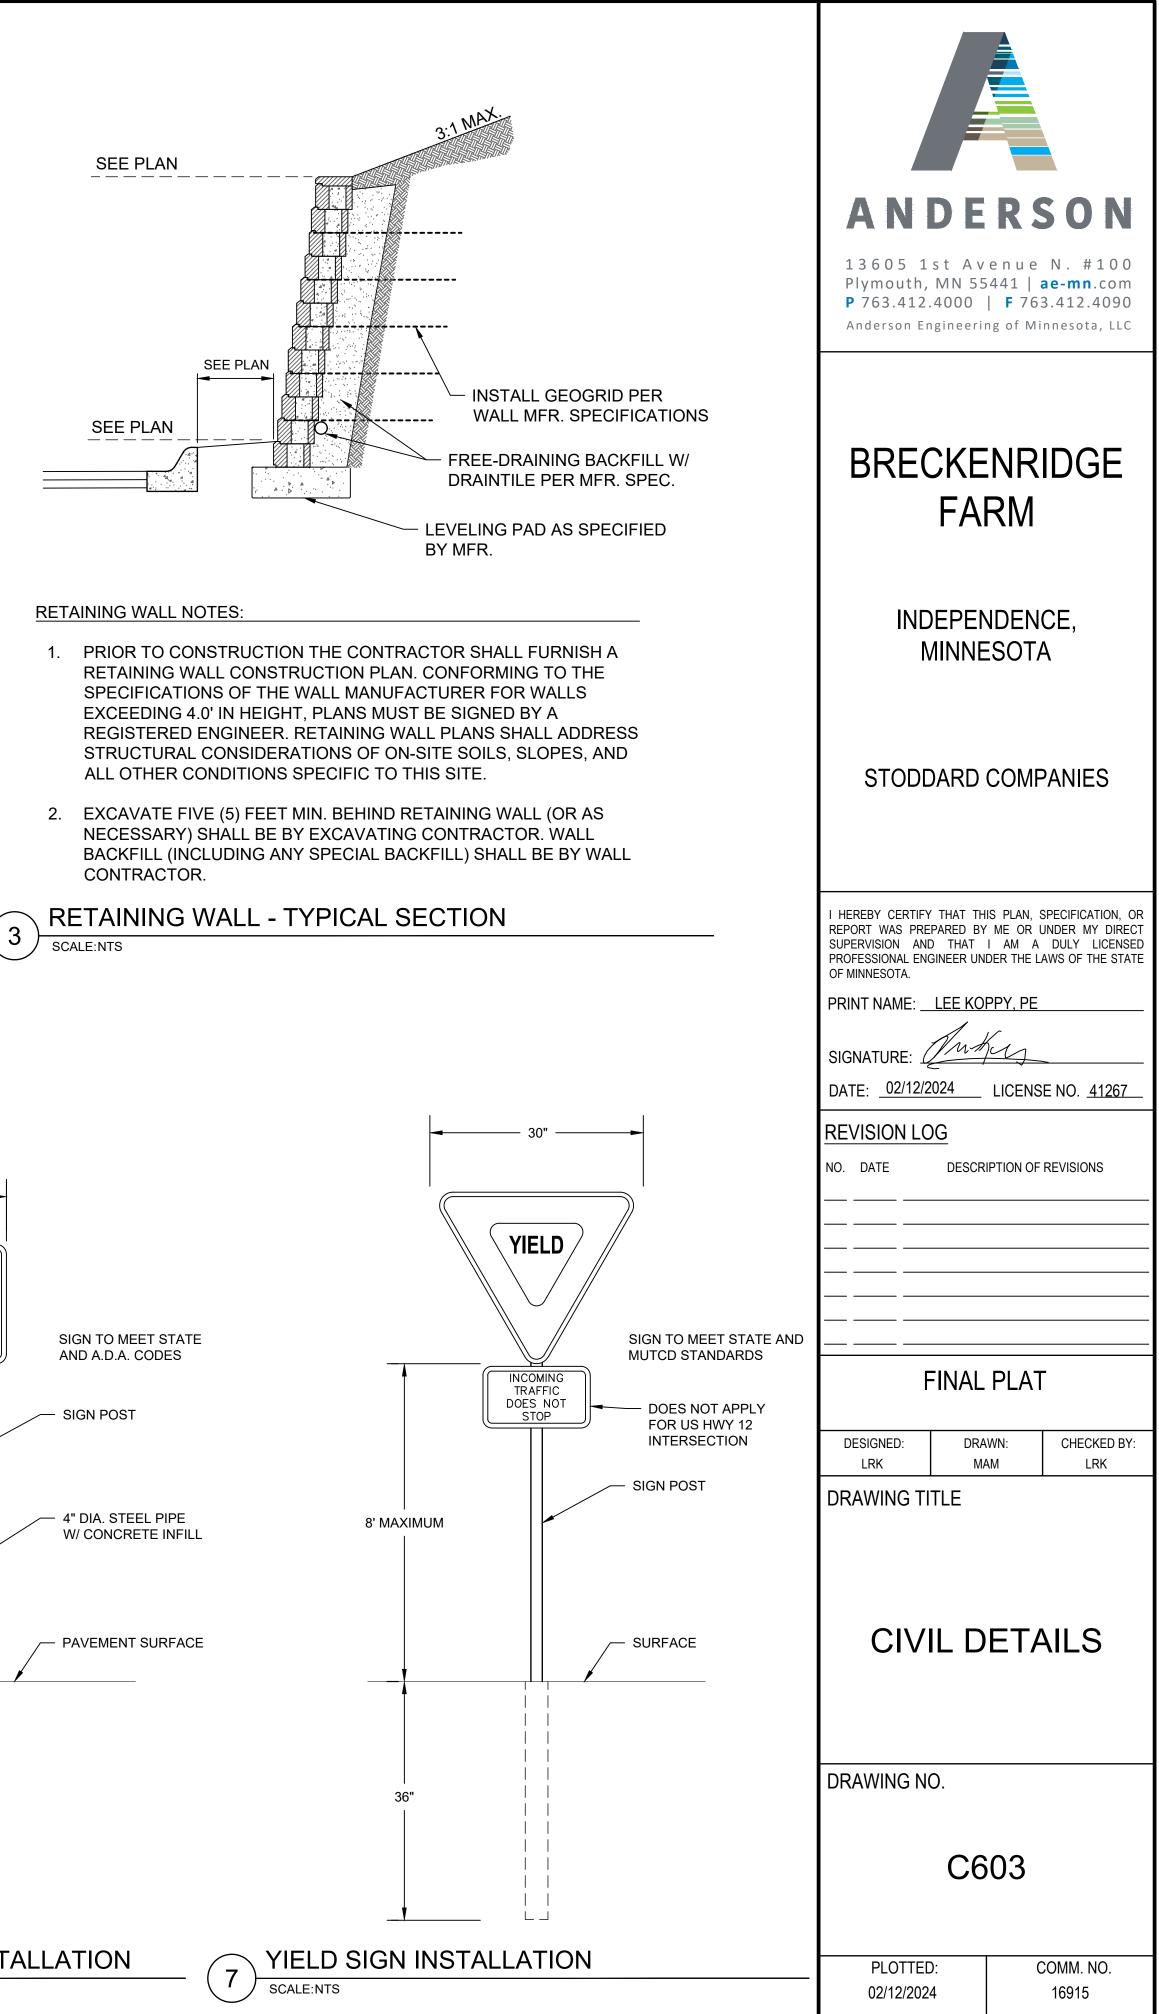

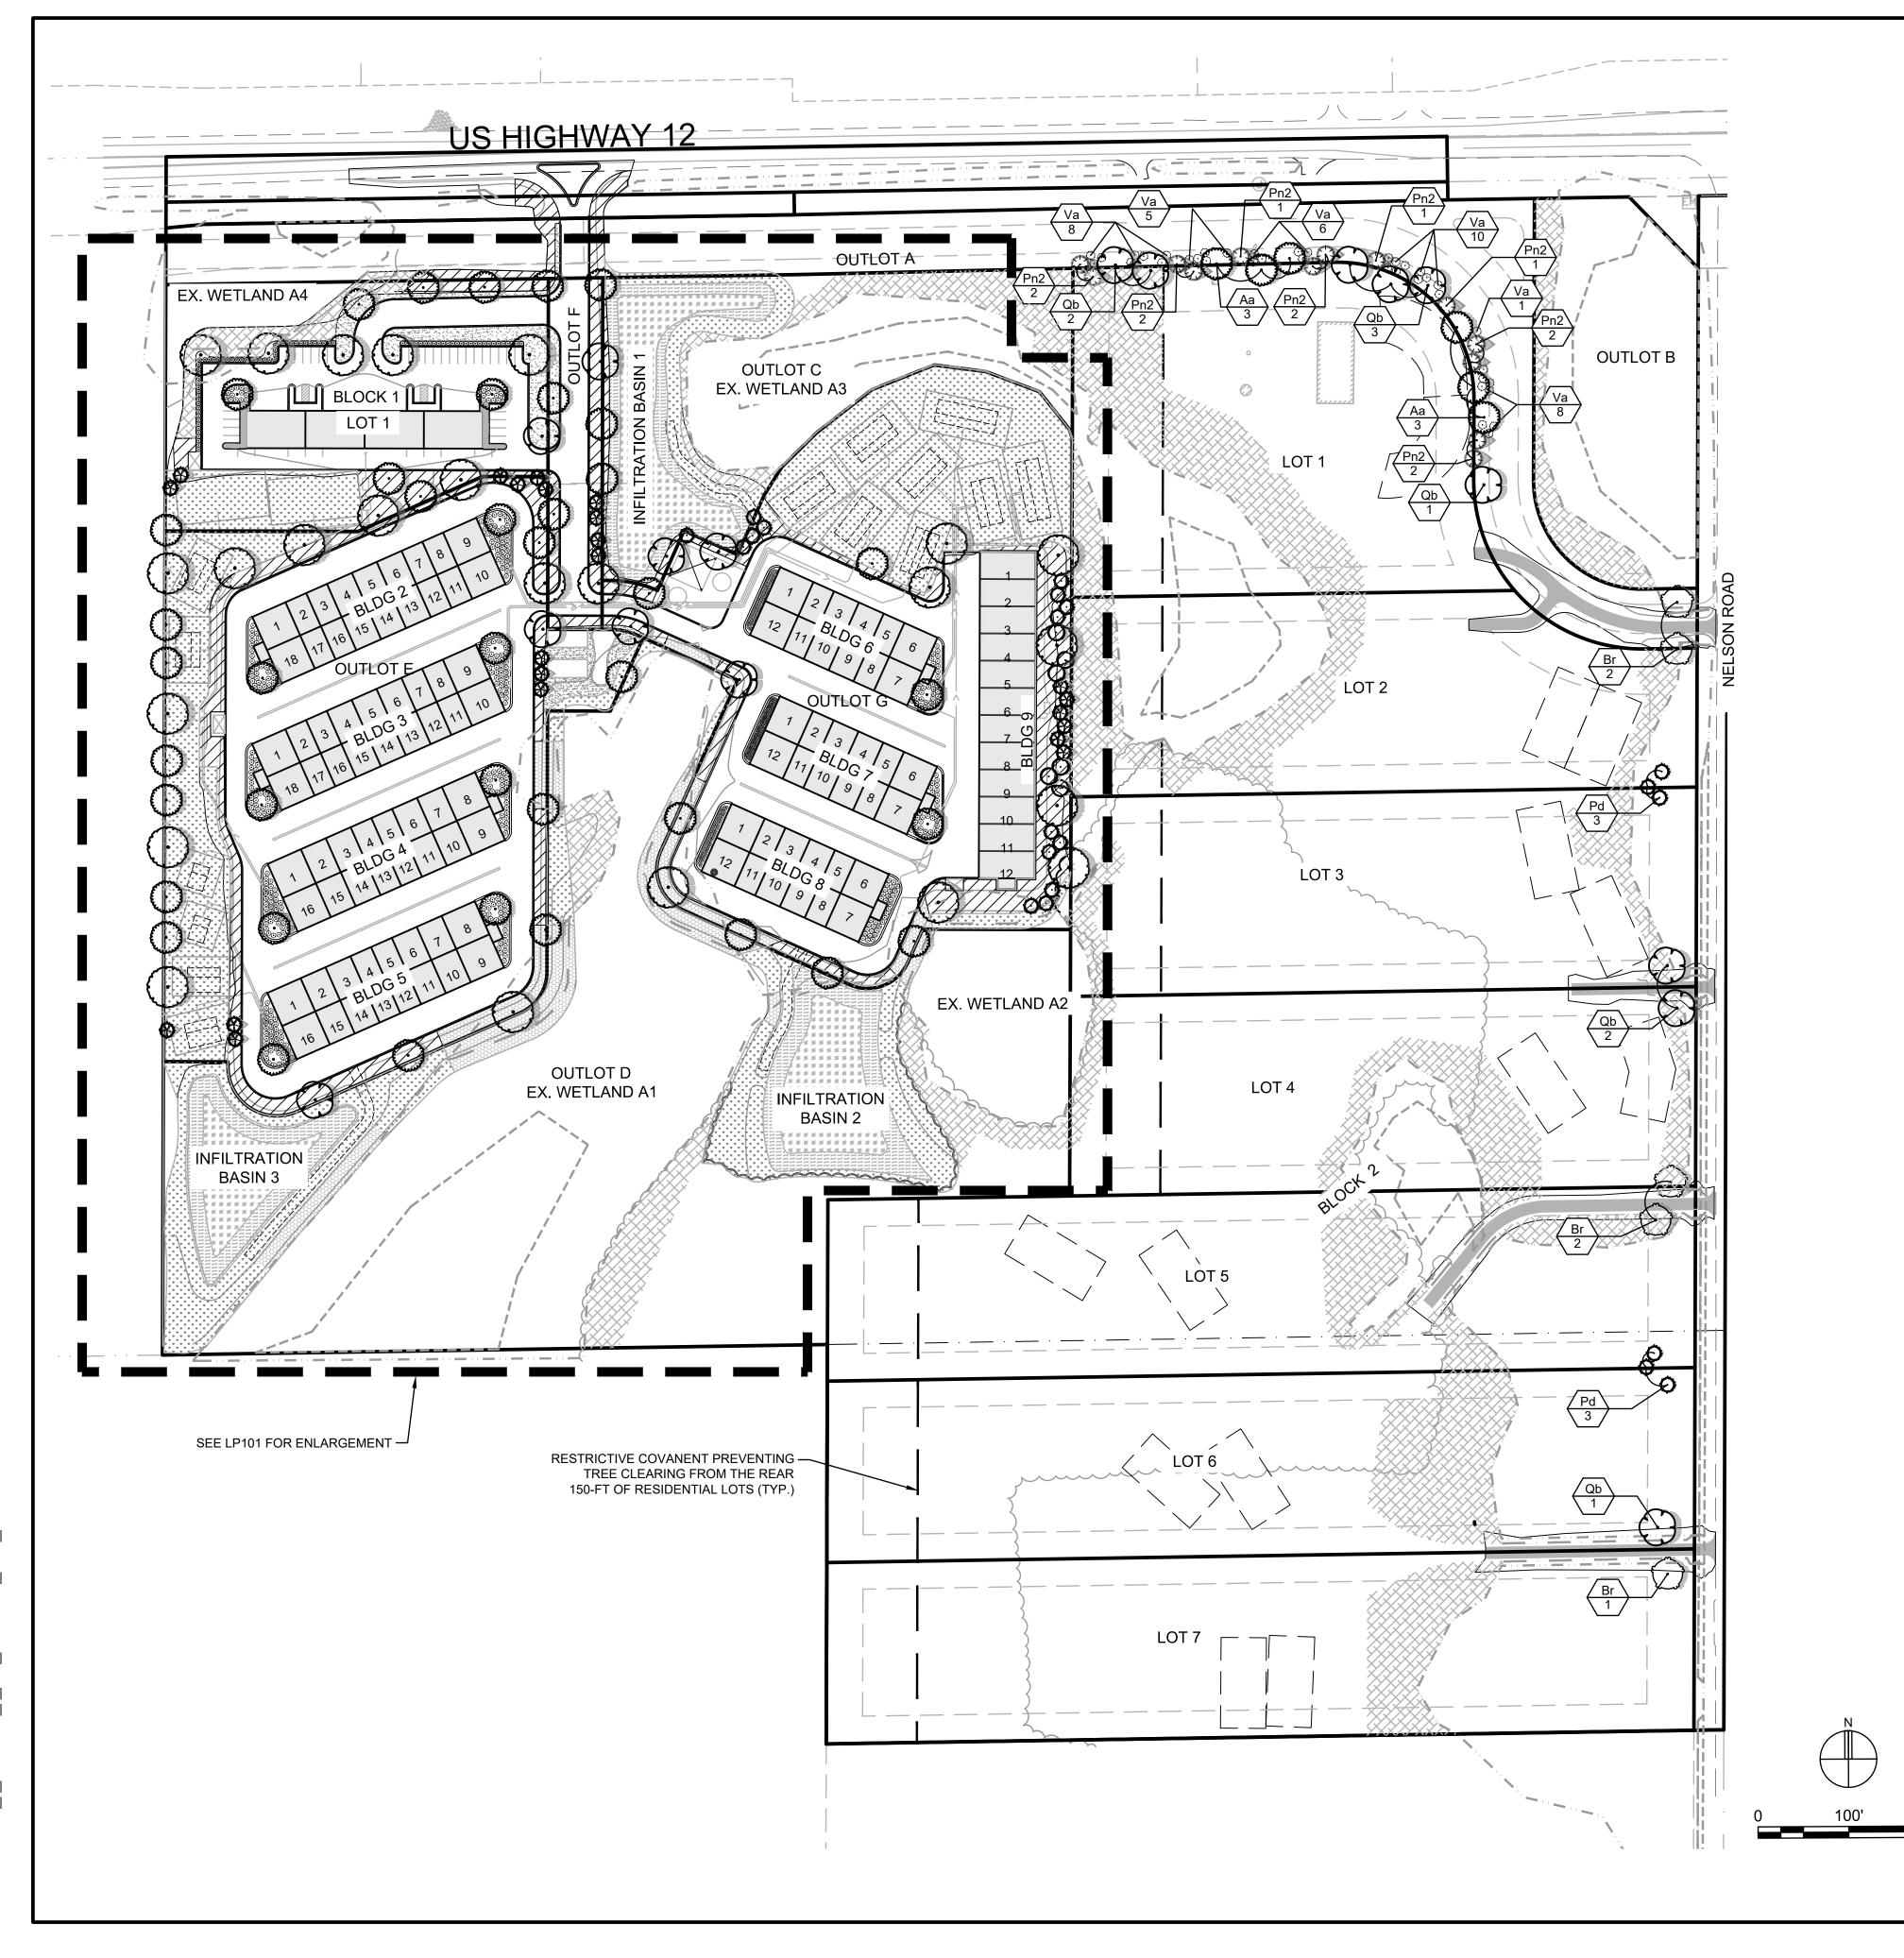

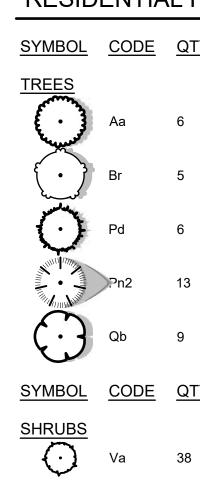

200'

LEGEND

	PROPERTY LIMITS ADJACENT PROPERTY DELINEATED WETLAND TYPE 1 DELINEATED WETLAND TYPE 2
	WET MEADOW SOUTH & WEST SEED MIX: MNDOT 34-271
	WETLAND BUFFER 2" PLUG PLANTINGS, 18" O.C.
	LOW MAINTENANCE TURF SEED MIX: MNDOT 25-131
	MESIC PRAIRIE GENERAL SEED MIX: MNDOT 35-241
× × × × × × × × × × × × × × × × × × ×	DRY SWALE/POND SEED MIX: MNDOT 33-262
	RIPARIAN SOUTH AND WEST SEED MIX: MNDOT 34-261
	SOD

RESIDENTIAL PLANT SCHEDULE

<u>QTY</u>	COMMON / BOTANICAL NAME	CONT	CAL
6	AUTUMN BLAZE® FREEMAN MAPLE ACER X FREEMANII 'JEFFERSRED'	B&B	2 - 1/2" CAL.
5	RIVER BIRCH BETULA NIGRA	B&B	2 - 1/2" CAL.
6	BLACK HILLS WHITE SPRUCE PICEA GLAUCA 'DENSATA'	B&B	6` HT.
13	AUSTRIAN PINE PINUS NIGRA	B&B	8` HT.
9	SWAMP WHITE OAK QUERCUS BICOLOR	B&B	2 - 1/2" CAL.
<u>QTY</u>	COMMON / BOTANICAL NAME	<u>CONT</u>	<u>SIZE</u>
38	AMERICAN CRANBERRYBUSH VIBURNUM TRILOBUM	CONT.	5 GAL.




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BRECKENRIDGE FARM

INDEPENDENCE, MINNESOTA

STODDARD COMPANIES

I HEREBY CERTIFY THAT THIS PLAN, SPECIFICATION, OR REPORT WAS PREPARED BY ME OR UNDER MY DIRECT SUPERVISION AND THAT I AM A DULY LICENSED PROFESSIONAL LANDSCAPE ARCHITECT UNDER THE LAWS OF THE STATE OF MINNESOTA.				
PRINT NAME: _	EFFREY W. DE	ITNER, PLA		
		< compared with the second sec		
SIGNATURE: _	<u> </u>			
DATE: <u>02/12/2</u>		NSE NO. <u>51899</u>		
REVISION LC	<u>)G</u>			
NO. DATE	DESCRIPTION	OF REVISIONS		
F	FINAL PLA	λT		
DESIGNED: JWD	DRAWN: AAW	CHECKED BY: JWD		
DRAWING TI	TLE			
DRAWING TITLE OVERALL LANDSCAPE PLAN				
DRAWING NO.				
LP100				
PLOTTE):	COMM. NO.		
02/12/202	4	16915		

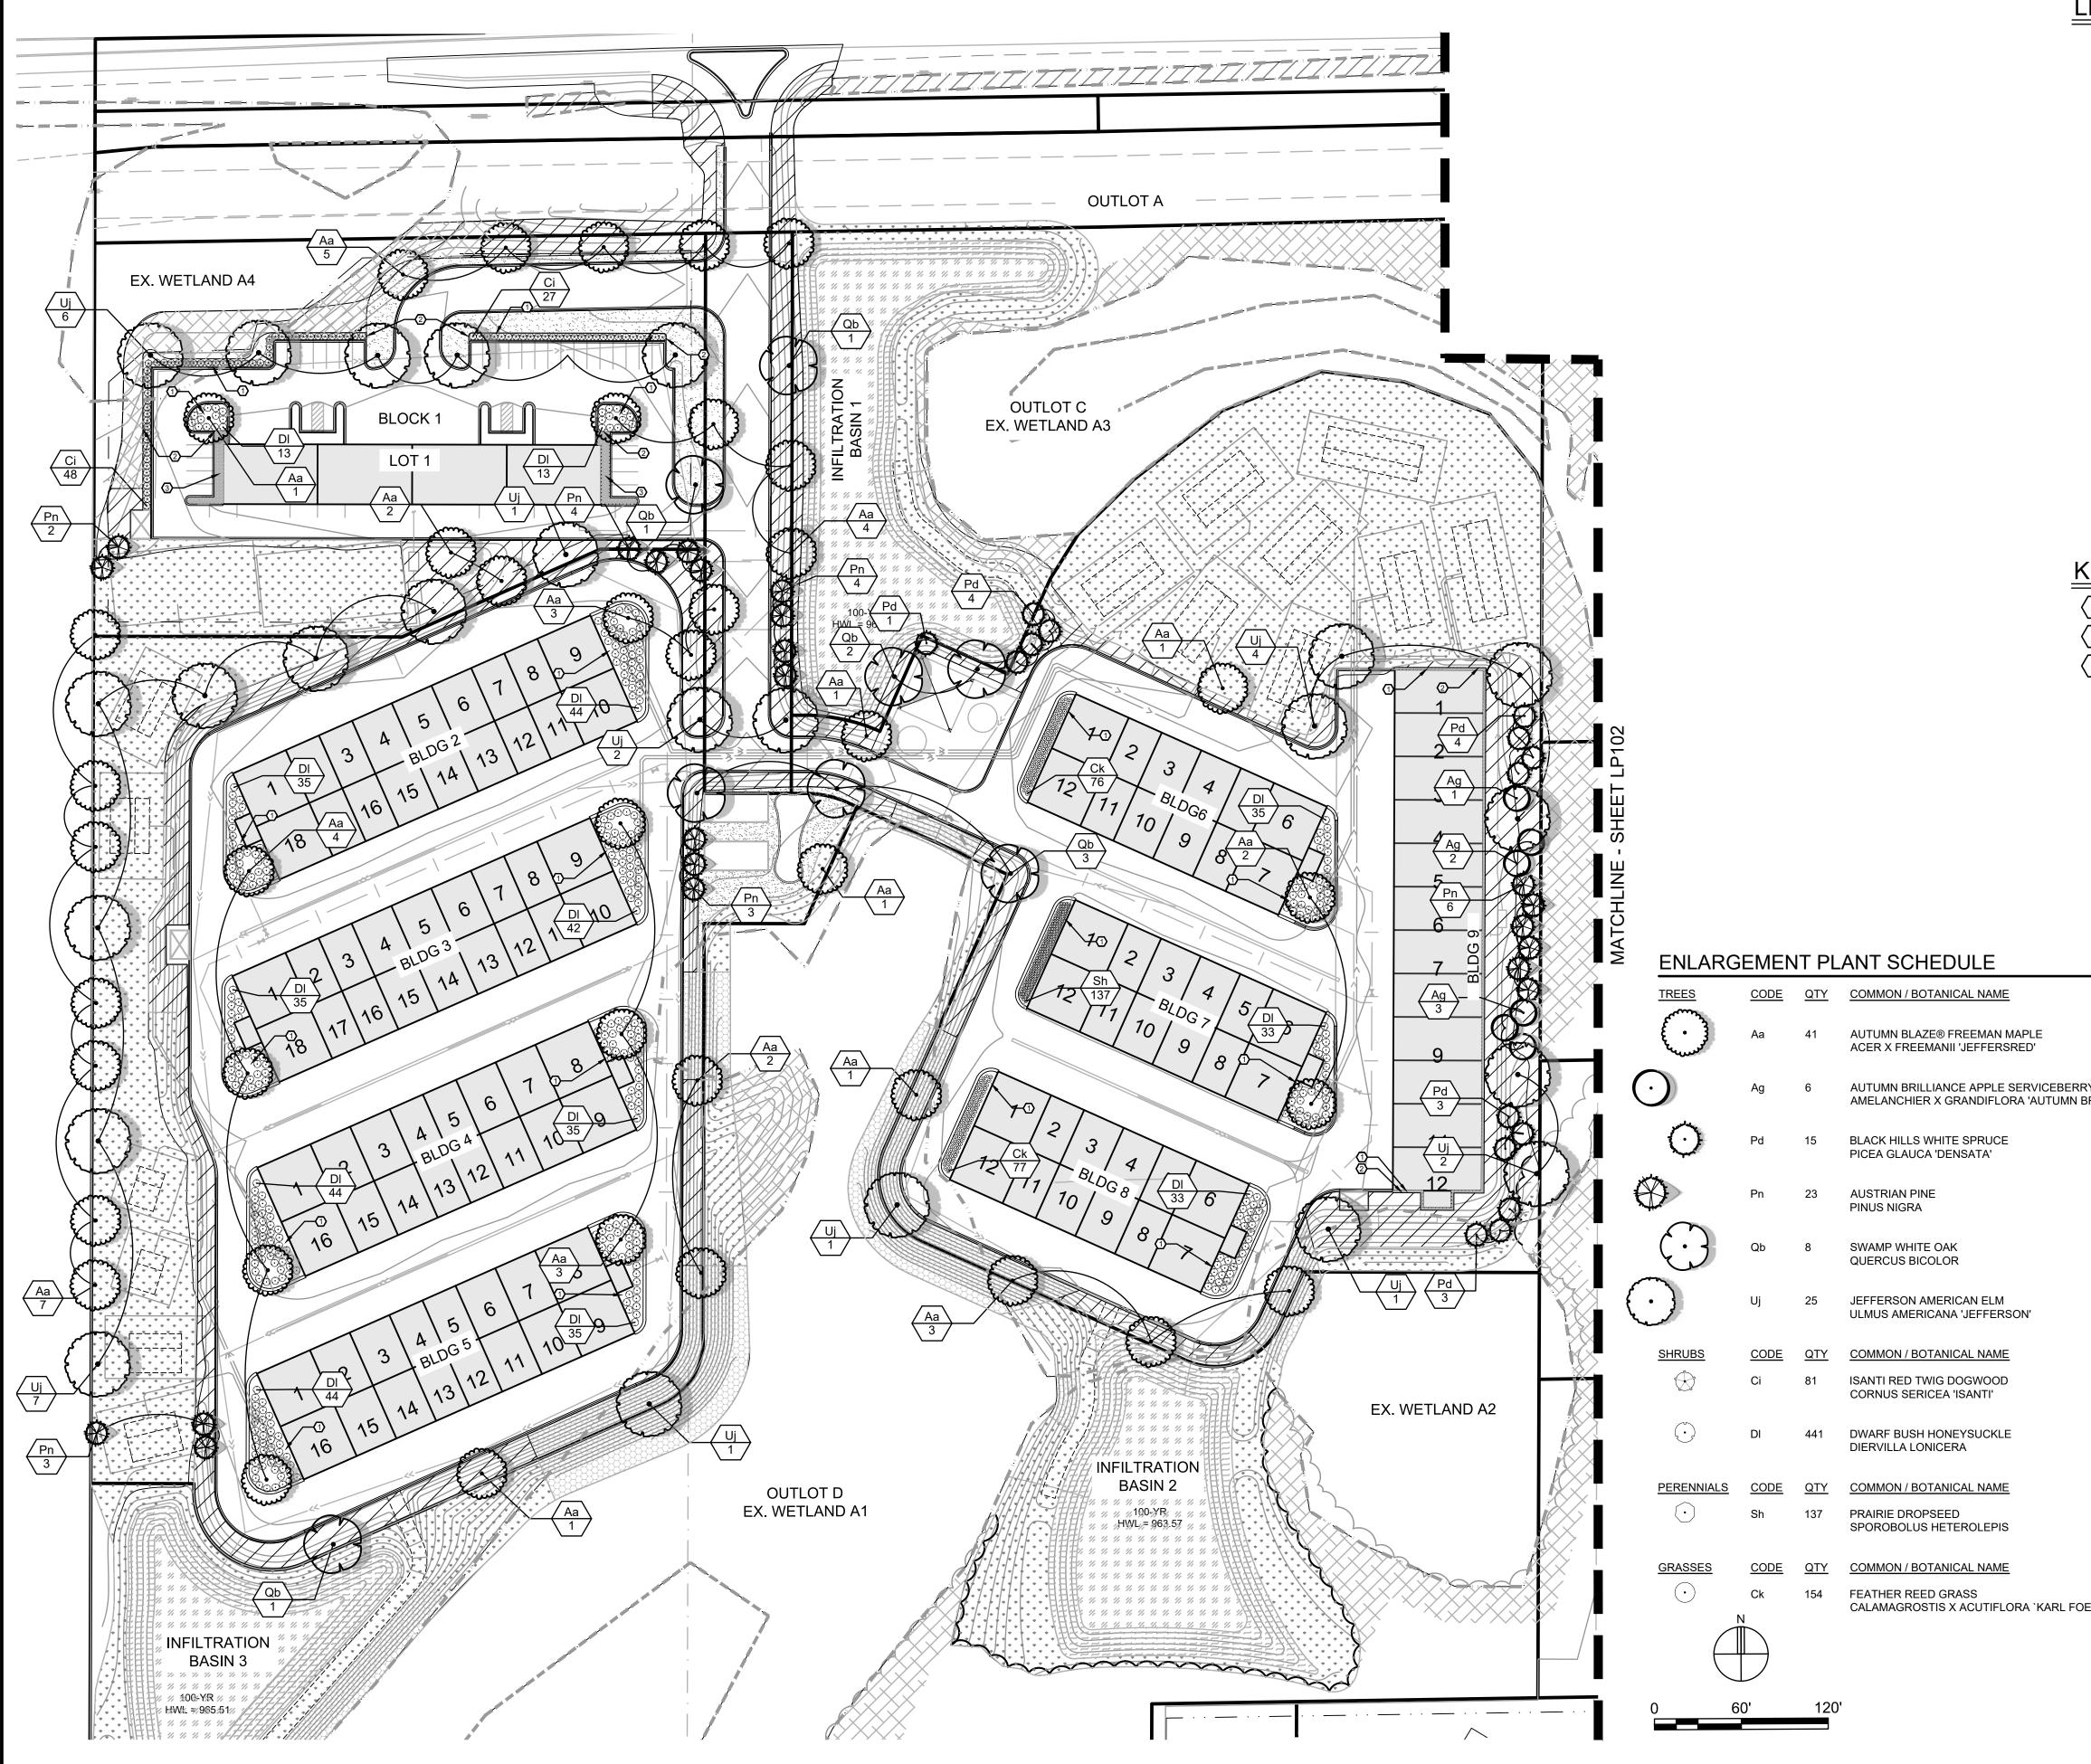


	PROPERTY LIMITS ADJACENT PROPERTY DELINEATED WETLAND TYPE 1 DELINEATED WETLAND TYPE 2
	WET MEADOW SOUTH & WEST SEED MIX: MNDOT 34-271
	WETLAND BUFFER 2" PLUG PLANTINGS, 18" O.C.
	LOW MAINTENANCE TURF SEED MIX: MNDOT 25-131
	MESIC PRAIRIE GENERAL SEED MIX: MNDOT 35-241
<i>n n n n n n n n n n n n</i> 11 11 11 11 11 11 11 11 11 11	DRY SWALE/POND SEED MIX: MNDOT 33-262
	RIPARIAN SOUTH AND WEST SEED MIX: MNDOT 34-261
	SOD

KEY NOTES

- $\langle 1 \rangle$ SHREDDED WOOD MULCH
- 2 LANDSCAPE EDGING, SEE DETAIL 1/LP104
- 3 ROCK MULCH

	CONT	CAL	REMARKS
	B&B	2 - 1/2" CAL.	
ry Brilliance'	B&B	6` HT. 3-5 STEMS	
	B&B	6` HT.	
	B&B	6` HT.	
	B&B	2 - 1/2" CAL.	
	B&B	2 - 1/2" CAL.	
	CONT	<u>SIZE</u>	REMARKS
	CONT.	5 GAL.	MIN. 5 CANES @ 12" HT.
	CONT.	5 GAL.	
	CONT	<u>SIZE</u>	REMARKS
	POT	3 GAL.	
	<u>CONT</u>	SIZE	REMARKS
ERSTER	CONT.	5 GAL.	

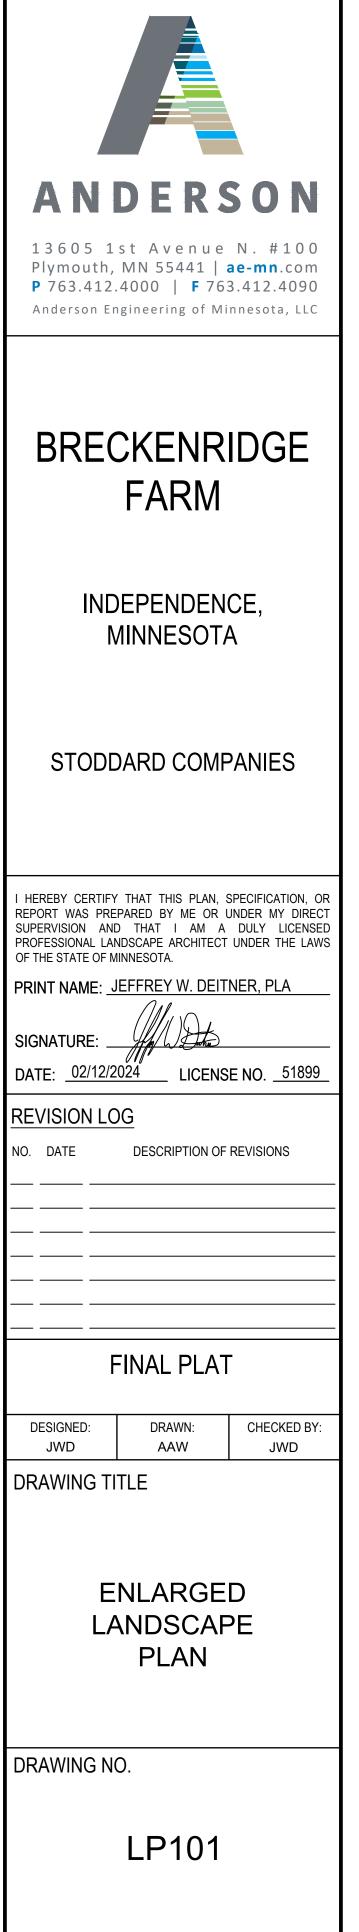

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GENERAL LANDSCAPE NOTES:

- LANDSCAPE CONTRACTOR SHALL VISIT THE PROJECT SITE PRIOR TO SUBMITTING A BID TO BECOME COMPLETELY FAMILIAR WITH SITE CONDITIONS.
- 2. ALL ROUGH AND FINISH GRADING TO BE DONE BY OTHERS.
- 3. NO PLANTING SHALL BE INSTALLED UNTIL ALL GRADING, BUILDING, CONSTRUCTION, UTILITY WORK & IRRIGATION (IF APPLICABLE) HAS BEEN COMPLETED IN THE AREAS TO BE PLANTED.
- 4. IT IS THE RESPONSIBILITY OF THE CONTRACTOR TO IDENTIFY ALL UNDERGROUND CABLES. CONDUITS. WIRES, ETC., ON THE PROPERTY.
- 5. IF THERE IS A DISCREPANCY BETWEEN THE NUMBER OF PLANTS SHOWN ON THE PLAN AND THE NUMBER OF PLANTS SHOWN IN THE PLANT LIST, THE NUMBER OF PLANTS SHOWN ON THE PLAN WILL TAKE PRECEDENCE.
- 6. ALL PROPOSED PLANT MATERIAL SHALL BE LOCATED CAREFULLY AS SHOWN ON THE PLAN. IF THE CONTRACTOR BELIEVES AN ERROR HAS BEEN MADE REGARDING SPACING OR LOCATION OF THE PLANT MATERIAL INDICATED ON THE PLAN, NOTIFY THE LANDSCAPE ARCHITECT PRIOR TO INSTALLATION.
- 7. THE CONTRACTOR IS RESPONSIBLE FOR COMPLETE MAINTENANCE OF THE PLANT MATERIAL (WATERING, SPRAYING, FERTILIZING, MOWING, ETC.) UNTIL THE WORK HAS BEEN ACCEPTED, BY THE OWNER.
- 8. THE CONTRACTOR IS RESPONSIBLE FOR ALL **REPAIRS TO PROPERTY DAMAGE FROM PLANTING** OPERATIONS AT NO COST TO THE OWNER.
- 9. ALL NEWLY PLANTED PLANT MATERIAL SHALL BE GUARANTEED THROUGH ONE CALENDAR YEAR STARTING FROM THE DATE OF ACCEPTANCE ESTABLISHED BY THE OWNER.
- 10. THE CONTRACTOR SHALL MEET WITH THE OWNER OR OWNERS REPRESENTATIVE ON SITE WHEN THEY FEEL THE PROJECT IS COMPLETE ACCORDING TO THE CONTRACT DOCUMENTS. IF ALL WORK IS SATISFACTORY AND COMPLETE ACCORDING TO THE CONDITIONS OF THE CONTRACT DOCUMENTS. THEN THE OWNER MUST DECLARE THE PROJECT COMPLETE. THIS DECLARATION WILL CONSTITUTE AS THE BEGINNING OF THE ONE (1) YEAR WARRANTEE PERIOD FOR ALL PLANT MATERIAL. THE **OWNER SHALL PROVIDE A LETTER WITH SIGNATURE** STATING THE DATE OF ACCEPTANCE.


GENERAL SODDING. SEEDING & TOPSOIL NOTES:

- LANDSCAPE CONTRACTOR SHALL ENSURE THAT NEW TREES MOVED ONTO THE SITE ARE DUG FROM SIMILAR SITES WITH SIMILAR SOILS TO THE SOILS OF THIS PROJECT (HEAVY TO HEAVY, LIGHT TO LIGHT. HEAVY TO LIGHT SOILS). CONTRACTOR SHALL **REVIEW SOIL CONDITIONS/TYPES WITH** OWNER/LANDSCAPE ARCHITECT PRIOR TO INSTALLATION.
- ALL NEWLY INSTALLED PLANT MATERIAL SHALL BE PLANTED IN WELL-DRAINED AREAS. NOTIFY THE LANDSCAPE ARCHITECT PRIOR TO INSTALLATION IF ANY PLANT MATERIAL IS LOCATED IN DRAINAGE SWALES OR WET & POORLY DRAINED AREAS.
- 3. ALL PLANTINGS SHALL RECEIVE FERTILIZER AS FOLLOWS:
- 3.1. SUMMER AND FALL PLANTING: 0-20-20 GRANULAR (IN SAUCER AROUND PLANT AT THE RATE OF 12 OZ. PER 2-3" CAL. TREE & 6 OZ. PER SHRUB).
- SPRING PLANTING: 10-10-10 GRANULAR (APPLY 3.2. ABOVE REFERENCED FERTILIZER AT A RATE OF 12 OZ. PER 1-1/2" CAL. TREE OR LARGER & 6 OZ. PER SHRUB & PERENNIAL.
- 4. ALL PLANTINGS SHALL RECEIVE AN AMENDED SOIL MIX CONSISTING OF THREE (3) PARTS:
- 4.1. 45% APPROVED TOPSOIL (ONE SITE PREFERRED)
- 4.2. 45% ORGANIC MATTER (TYPE 1 SPHAGNUM PEAT MOSS FINELY DIVIDED WITH A PH OF 3.1 - 5.0.) 4.3. 10% SAND (FINE CLEAN MASONRY SAND)

MATERIAL WILL NOT BE ACCEPTED. 12. CONTRACTOR CAN SUBSTITUTE MACHINE MOVED MATERIAL USING APPROPRIATE SIZE TREE SPADE FOR B & B WITH OWNER APPROVAL. 13. THE PRACTICE OF STAKING SHOULD NOT ALLOW NAILS, SCREWS, WIRES, ETC. TO PENETRATE THE OUTER SURFACE OF THE TREES.

11. WIND BURN OR OTHERWISE DAMAGED PLANT


- 14. THE CONTRACTOR WILL BE RESPONSIBLE FOR THE REMOVAL OF ALL TREE STAKES, GUYS, STRAPS AND TRUNK PROTECTION MEASURES FOLLOWING THE COMPLETION OF THE WARRANTEE PERIOD OR AS DIRECTED BY THE OWNER.
- 15. LANDSCAPE CONTRACTOR IS REQUIRED TO PROVIDE THE OWNER WITH MAINTENANCE INFORMATION DURING THE GUARANTEE PERIOD RELATING TO WATERING, FERTILIZING, PRUNING, PEST CONTROL AND RELATED ITEMS. THIS WILL BE PREPARED AND DELIVERED TO THE OWNER AFTER PROVISIONAL INSPECTION APPROVAL HAS BEEN GIVEN BY THE OWNER AND/OR LANDSCAPE ARCHITECT.
- 16. INSTALL CORRUGATED PLASTIC TREE GUARDS. WHITE IN COLOR, WITH THE SIZE OF TUBE 1" DIA. (MIN.) LARGER THAN THE CALIPER OF THE TREE TO BE PROTECTED.
- 17. CONTRACTOR TO FURNISH & STALL PLASTIC EDGING AS SHOWN ON THE PLANS & DETAILS. PLASTIC EDGING SHALL BE MEDIUM DENSITY POLYETHYLENE WITH U.V. INHIBITOR, BLACK IN COLOR, WITH A TOTAL DEPTH OF 5" (1" DIA. TOP AND 4" SHAFT WITH 1.5" V EVERY 3-1/2 FEET OF EDGING.
- 18. LANDSCAPE FABRIC (FILTER MAT) TO HAVE A COMBINED WEIGHT OF 4.5-5.5 OZ. PER S.Y. FABRIC SHOULD BE U.V. STABILIZED AND HAVE A FIVE YEAR MINIMUM WEATHERABILITY FACTOR IN FULL SUNLIGHT. FABRIC TO BE PHILLIPS DUON R OR EQUIVALENT. SAMPLE REQUIRED FOR APPROVAL
- 19. LANDSCAPE BED MULCH SHALL BE SHREDDED HARDWOOD MULCH. MULCH SHALL BE INSTALLED AT A DEPTH OF 3" WITH NO WEED BARRIER LANDSCAPE FABRIC.
- 20. 3" DEPTH SHREDDED HARDWOOD MULCH SHALL BE INSTALLED UNDER ALL TREES AND SHRUBS THAT ARE ISOLATED FROM GROUNDCOVER AREAS AND GENERAL SHRUB MASSES.
- 5. AREAS CONFINED TO A MASS PLANTING AREA (PLANTING BED) SHALL RECEIVE THE AMENDED SOIL MIX AT MIN. 12" DEPTH THROUGHOUT THE PLANTING AREA. AMENDED SOIL MIX SHALL BE MIXED THOROUGHLY AND INSTALLED IN 6" LIFTS.
- 6. AREAS TO RECEIVE SOD OR SEED SHALL HAVE A 4" MINIMUM DEPTH OF TOPSOIL. TOPSOIL SHALL PROVIDE FERTILE, FRIABLE, NATURAL LOAM, SURFACE SOIL, REASONABLY FREE OF SUBSOIL CLAY CLUMPS, BRUSH WEEDS AND OTHER LITTER, AND FREE OF ROOTS, STUMPS, STONE LARGER THAN 1" IN ANY DIMENSION, AND OTHER EXTRANEOUS OR TOXIC MATTER HARMFUL TO PLANT GROWTH.
- SOD SHALL BE HIGHLAND SOD, 30" X 100' ROLLS PREFERRED WHERE APPLICABLE, TO BE LAID PARALLEL WITH THE CONTOURS AND HAVE STAGGERED JOINTS. ON SLOPES STEEPER THAN 3:1 OR DRAINAGE SWALES, THE SOD SHALL BE STAKED INTO THE GROUND. SCARIFY THE EXISTING GRADES WITH FIELD CULTIVATOR PRIOR TO PLACING OF TOPSOIL AND FINISH GRADING FOR SOD. IMMEDIATELY PRIOR TO PLACING SOD, CONTRACTOR SHALL APPLY 10-6-4 FERTILIZER AT THE RATE OF 10 POUNDS PER 1000 SQ. FT.
- ALL AREAS SPECIFIED AS MNDOT SEED MIXES SHALL **BE INSTALLED PER MNDOT SEEDING MANUAL 2023** EDITION.

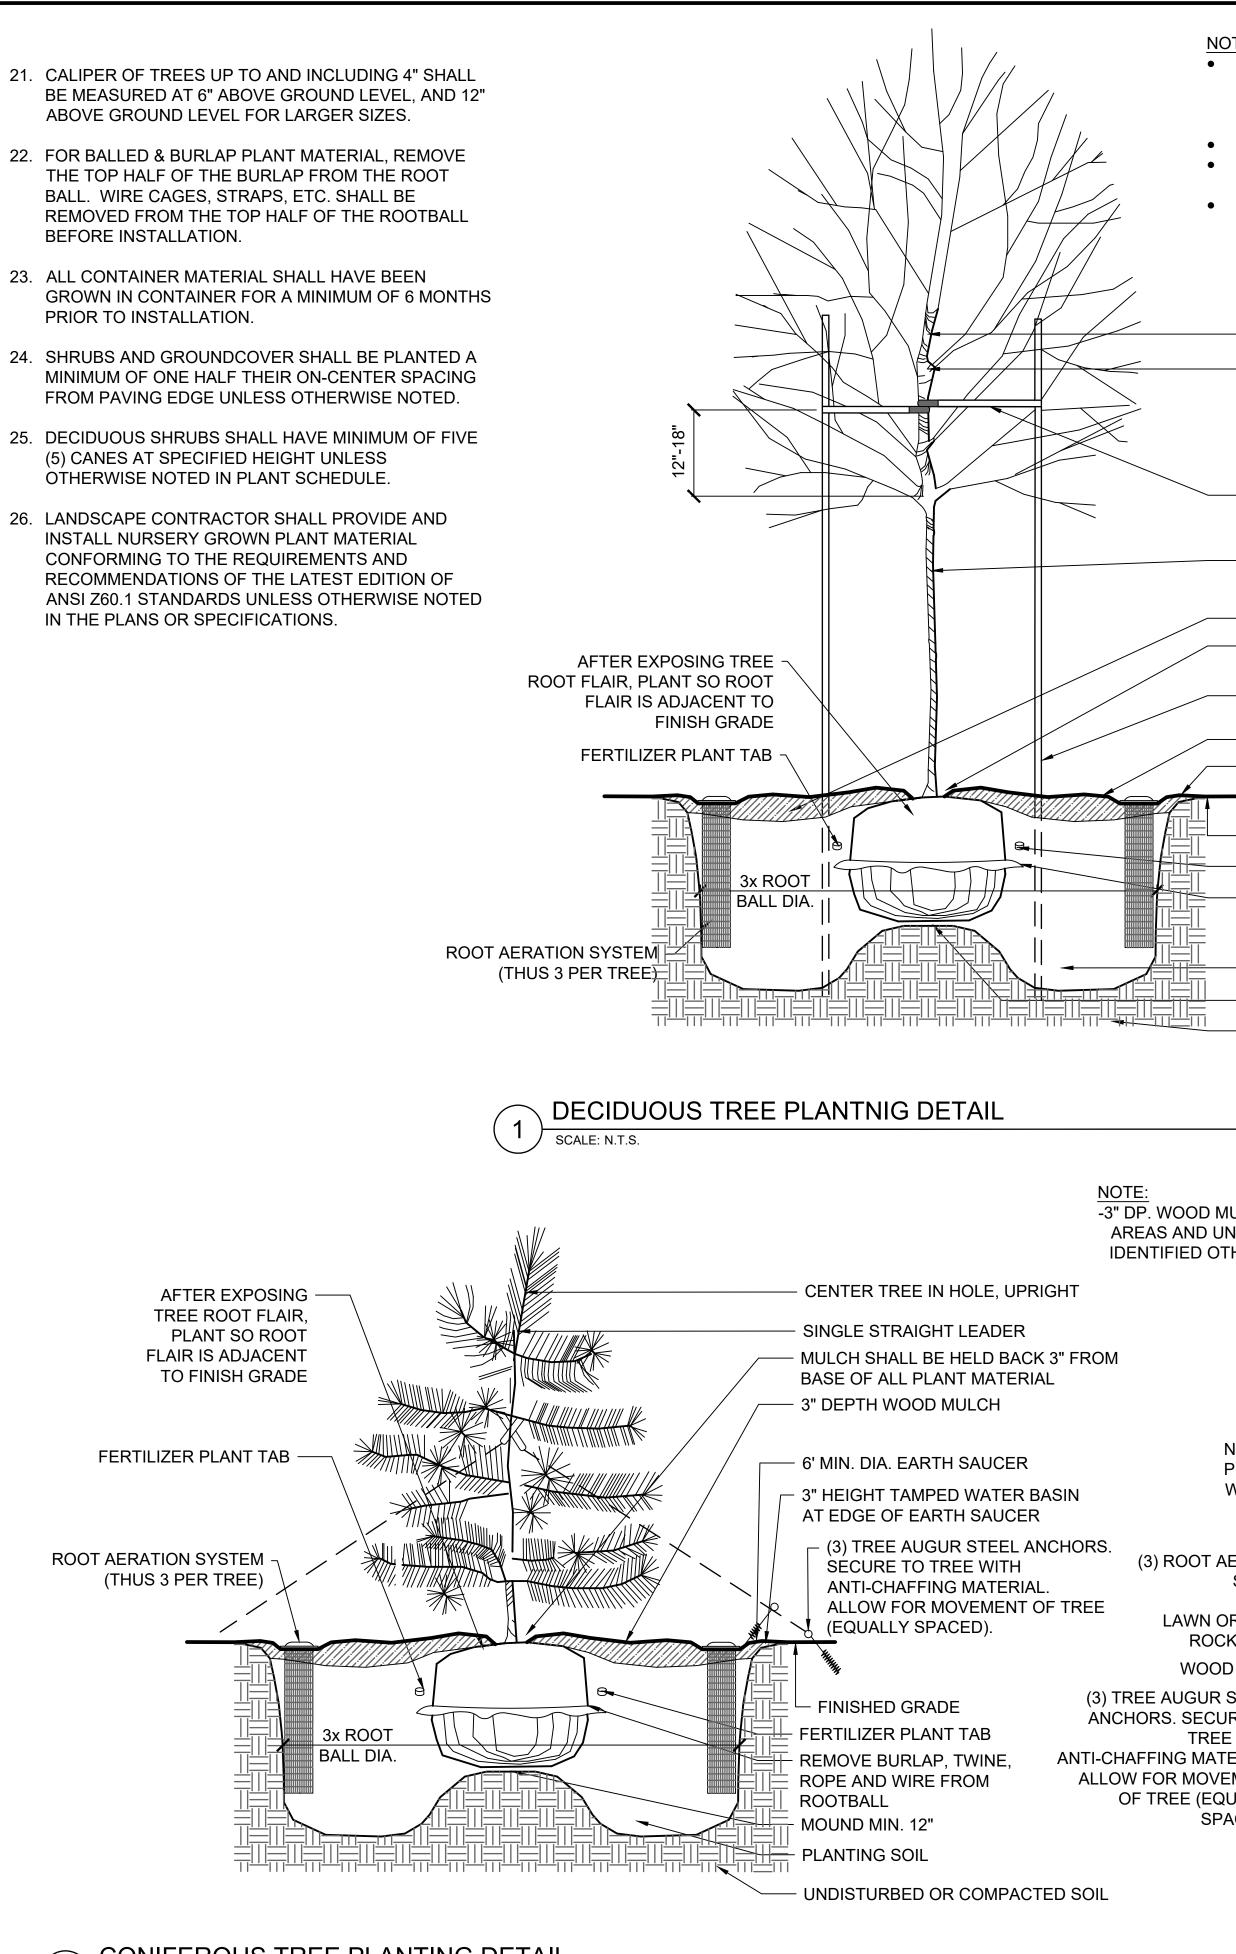


CONIFEROUS TREE PLANTING DETAIL


2 SCALE: N.T.S.


TE: 3" DP. WOOD MULCH SHALL BE USED IN ALL LANDSCAPE PLANTINGS AREAS AND UNDER TREES ISOLATED FROM PLANTING AREAS UNLESS IDENTIFIED OTHERWISE. KEEP MULCH APPX. 3" OFF PLANT TRUNK OR STEM SEE PLANT SCHEDULE FOR O.C. SPACING, IF APPLICABLE MULTI-STEM TREES SHALL NOT RECEIVE STAKING. THEY SHALL CONFORM TO ALL OTHER DECIDUOUS TREE PLANTING REQUIREMENTS. - CENTER TREE IN HOLE, UPRIGHT - SINGLE STRAIGHT LEADER	13605 1st Av Plymouth, MN 55 P 763.412.4000	RSON enue N. #100 441 ae-mn.com F 763.412.4090 ng of Minnesota, LLC
 TREE TIE SECURED TO STAKE. SECURE TO TREE WITH ANTI-CHAFFING MATERIAL. ALLOW FOR MOVEMENT OF TREE. WRAP TREE WITH TREE WRAPPING MATERIAL AS SPECIFIED TO 1ST BRANCH 	BRECKE FA	NRIDGE RM
 6' MIN. DIA. EARTH SAUCER MULCH SHALL BE HELD BACK 3" FROM BASE OF ALL PLANT MATERIAL (3) TREE STAKES DRIVEN A MIN. 2' BELOW GRADE (EQUALLY SPACED) 3" DEPTH WOOD MULCH 	INDEPEN MINNE	,
 - 3" HEIGHT TAMPED WATER BASIN AT EDGE OF EARTH SAUCER - FINISHED GRADE - FERTILIZER PLANT TAB 	STODDARD	COMPANIES
 REMOVE BURLAP, TWINE, ROPE AND WIRE FROM ROOTBALL PLANTING SOIL MOUND MIN. 12" UNDISTURBED OR COMPACTED SOIL 	REPORT WAS PREPARED BY SUPERVISION AND THAT PROFESSIONAL LANDSCAPE A OF THE STATE OF MINNESOTA. PRINT NAME: JEFFREY SIGNATURE:	I AM A DULY LICENSED ARCHITECT UNDER THE LAWS
JLCH SHALL BE USED IN ALL LANDSCAPE PLANTINGS IDER TREES ISOLATED FROM PLANTING AREAS UNLESS HERWISE.	REVISION LOG NO. DATE DESCR DESCR DESCR	IPTION OF REVISIONS
3X ROOTBALL DIA.	FINAL	PLAT
IORTHWEST PREVAILING VINDS	DESIGNED: DRA JWD AA	
ERATION SYSTEM R TYPE 1 MULCH MULCH OMULCH ETEEL RE TO WITH	LANDS(DET	CAPING AILS
ERIAL. MENT JALLY CED). MENT SOUTHEAST PREVAILING WINDS	DRAWING NO.	
<u>PLAN VIEW</u> NOT TO SCALE	LP	102
	PLOTTED:	COMM. NO.
	02/12/2024	16915

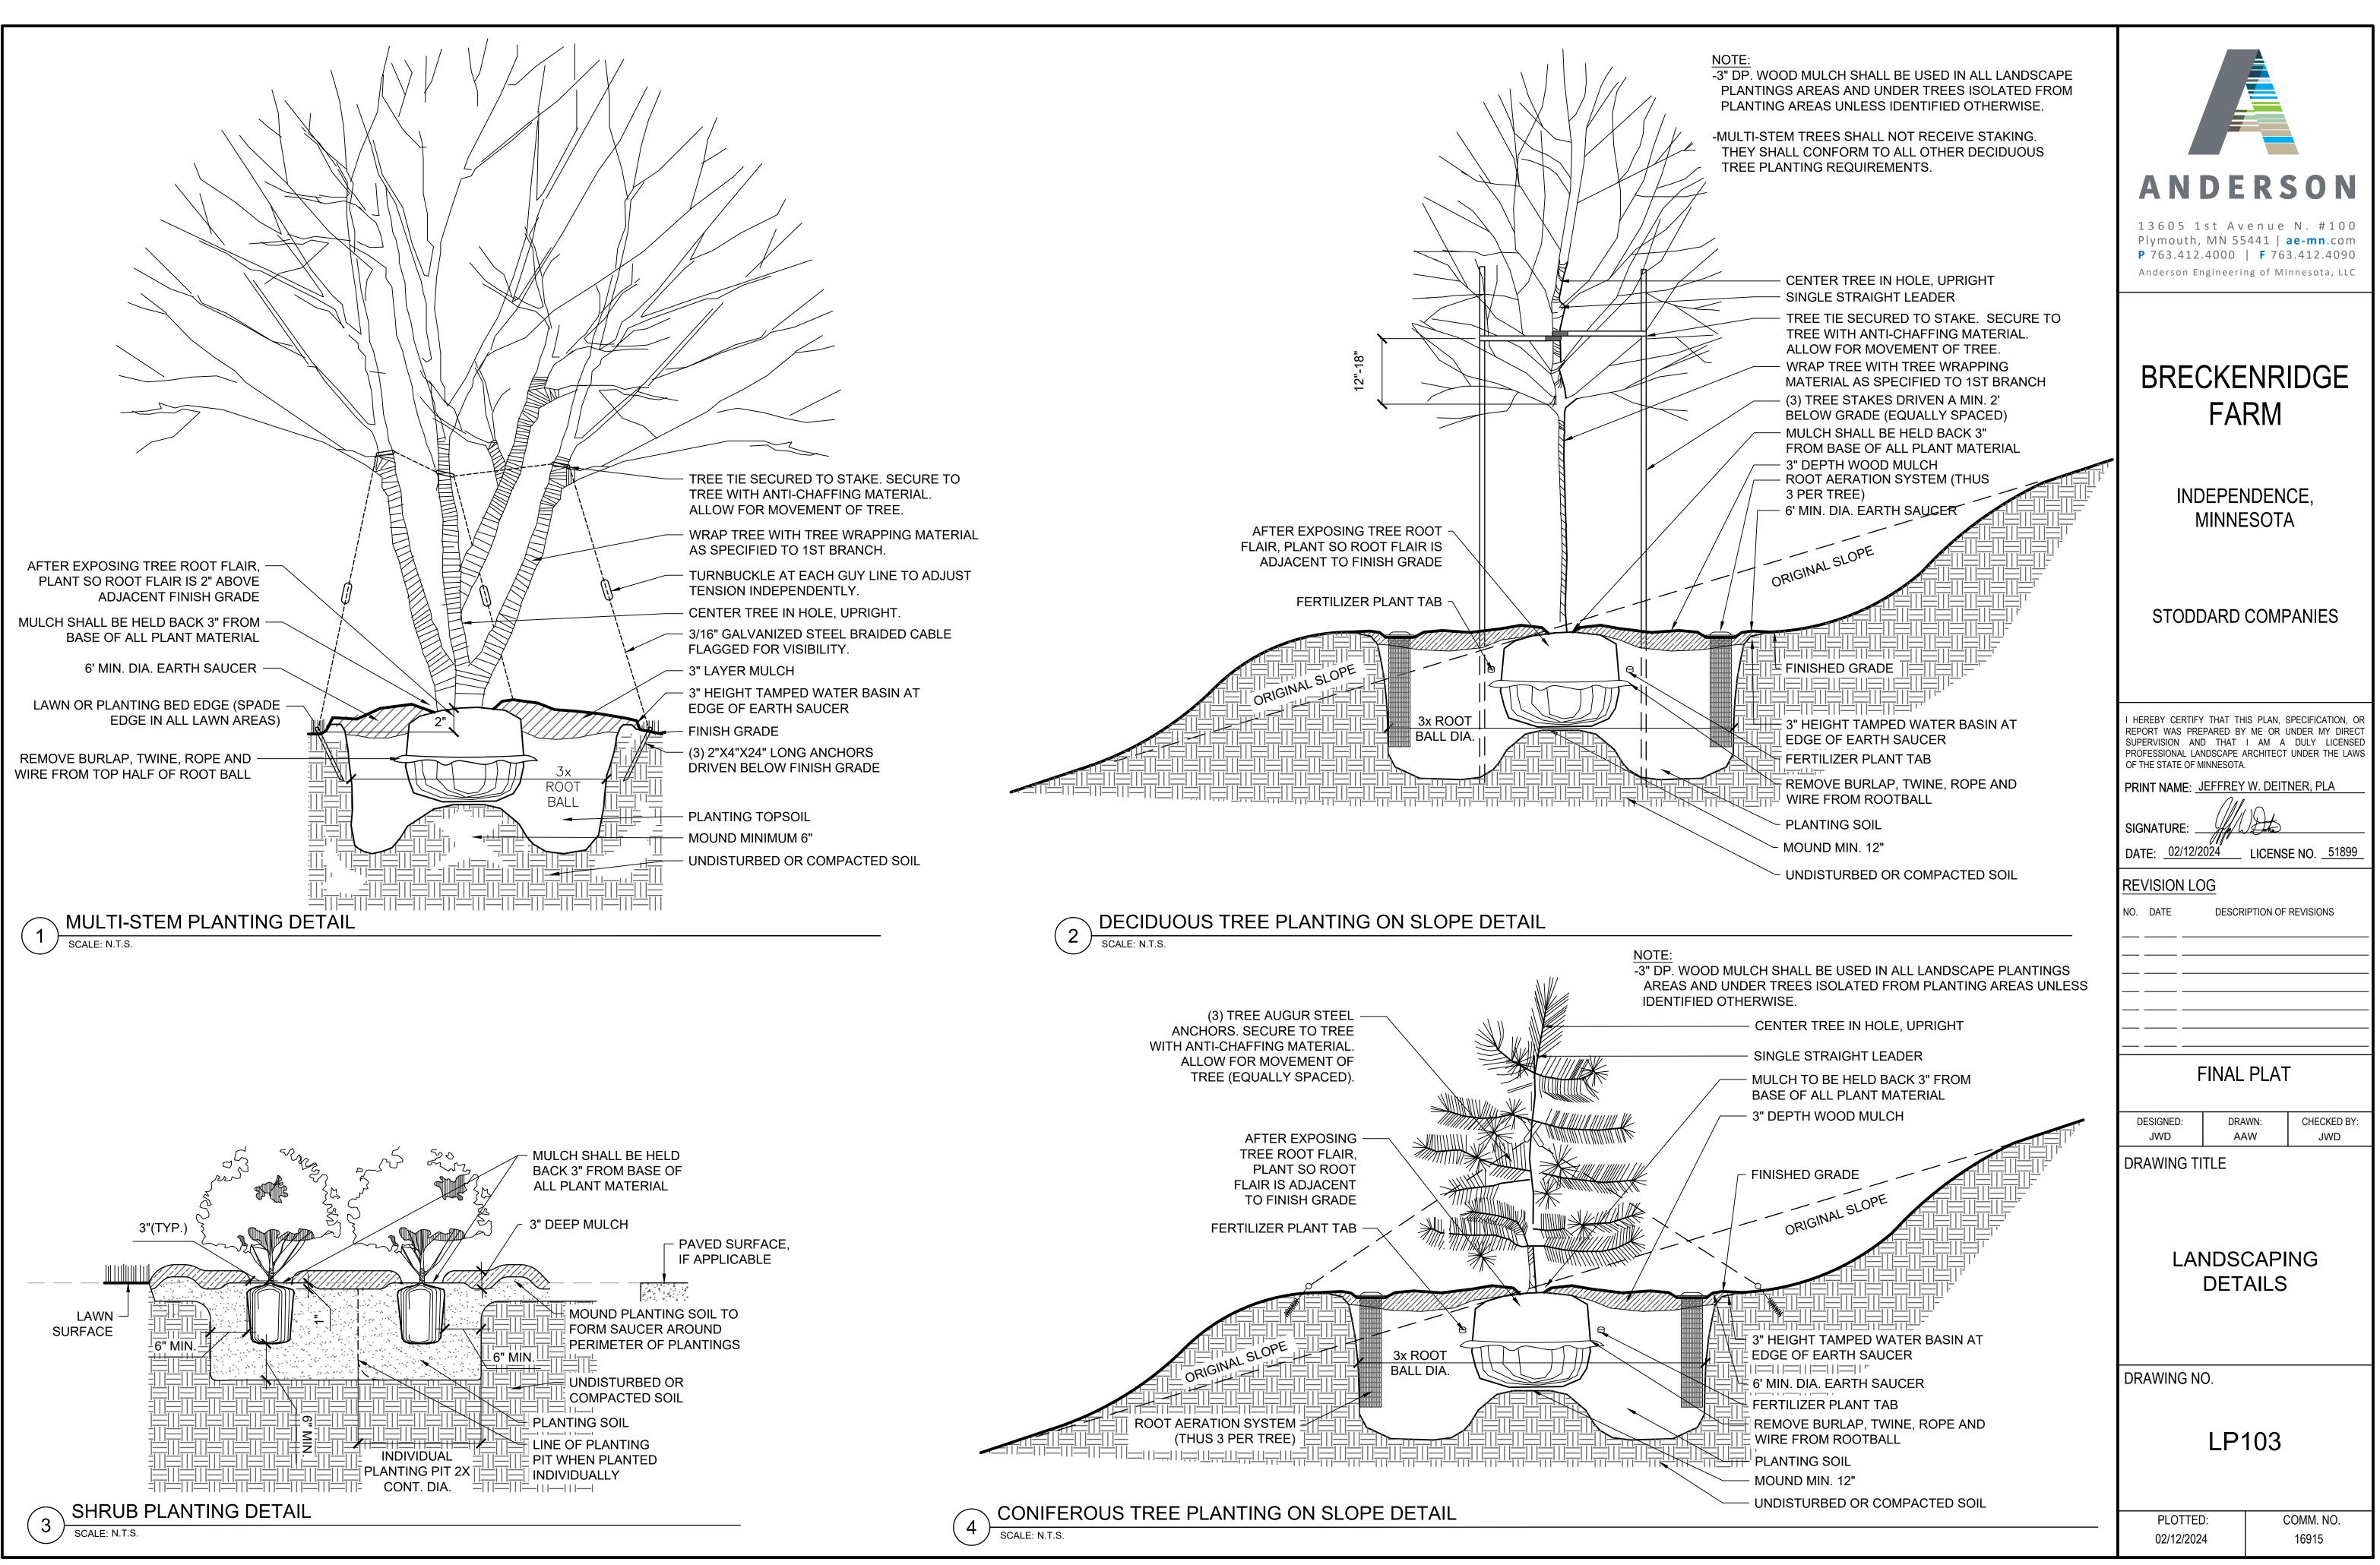

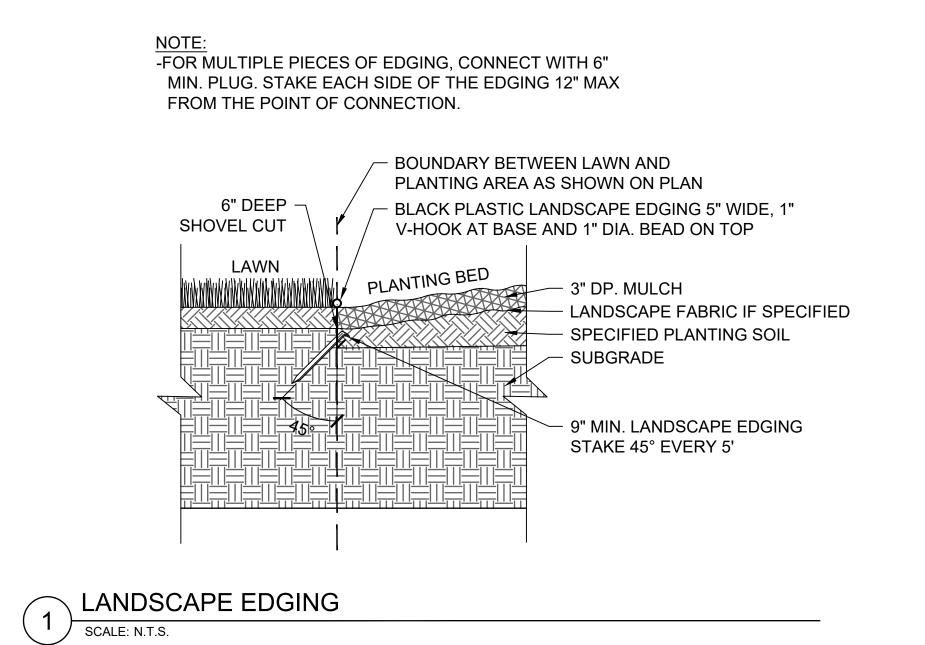



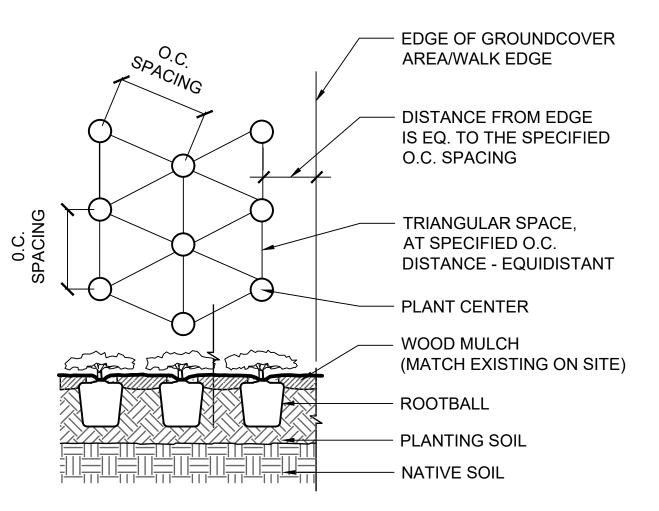

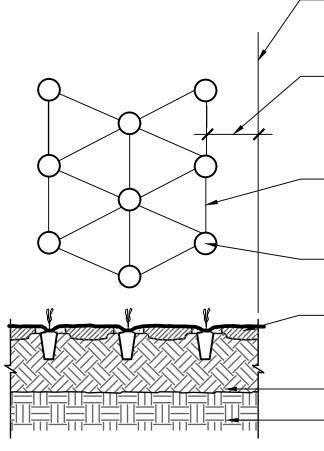

NOTE:

- KEEP MULCH APPX. 2" OFF PLANT TRUNK OR STEM
- SEE PLANT SCHEDULE FOR EACH PLANT'S APPROPRIATE O.C. SPACING

✓ PLANT BED SPACING DETAIL

SCALE: N.T.S.

(2)


3 PLUG SPACING DETAIL SCALE: N.T.S.

- EDGE OF	
GROUNDCOVER ARE	A

- DISTANCE FROM EDGE IS $\frac{1}{2}$ THE SPECIFIED O.C. SPACING
- TRIANGULAR SPACE,
 AT SPECIFIED O.C.
 DISTANCE EQUIDISTANT
- PLANT CENTER
- SEED
- PLANTING SOIL
- NATIVE SOIL





JVVD	AA	.vv	JWD	
DRAWING TI	TLE			
		וחאר		
		CAPI	NG	
	DET	AILS		
DRAWING NO	Э.			
	LP	104		
	LF	104		
PLOTTED):	C	OMM. NO.	
02/12/2024	4		16915	

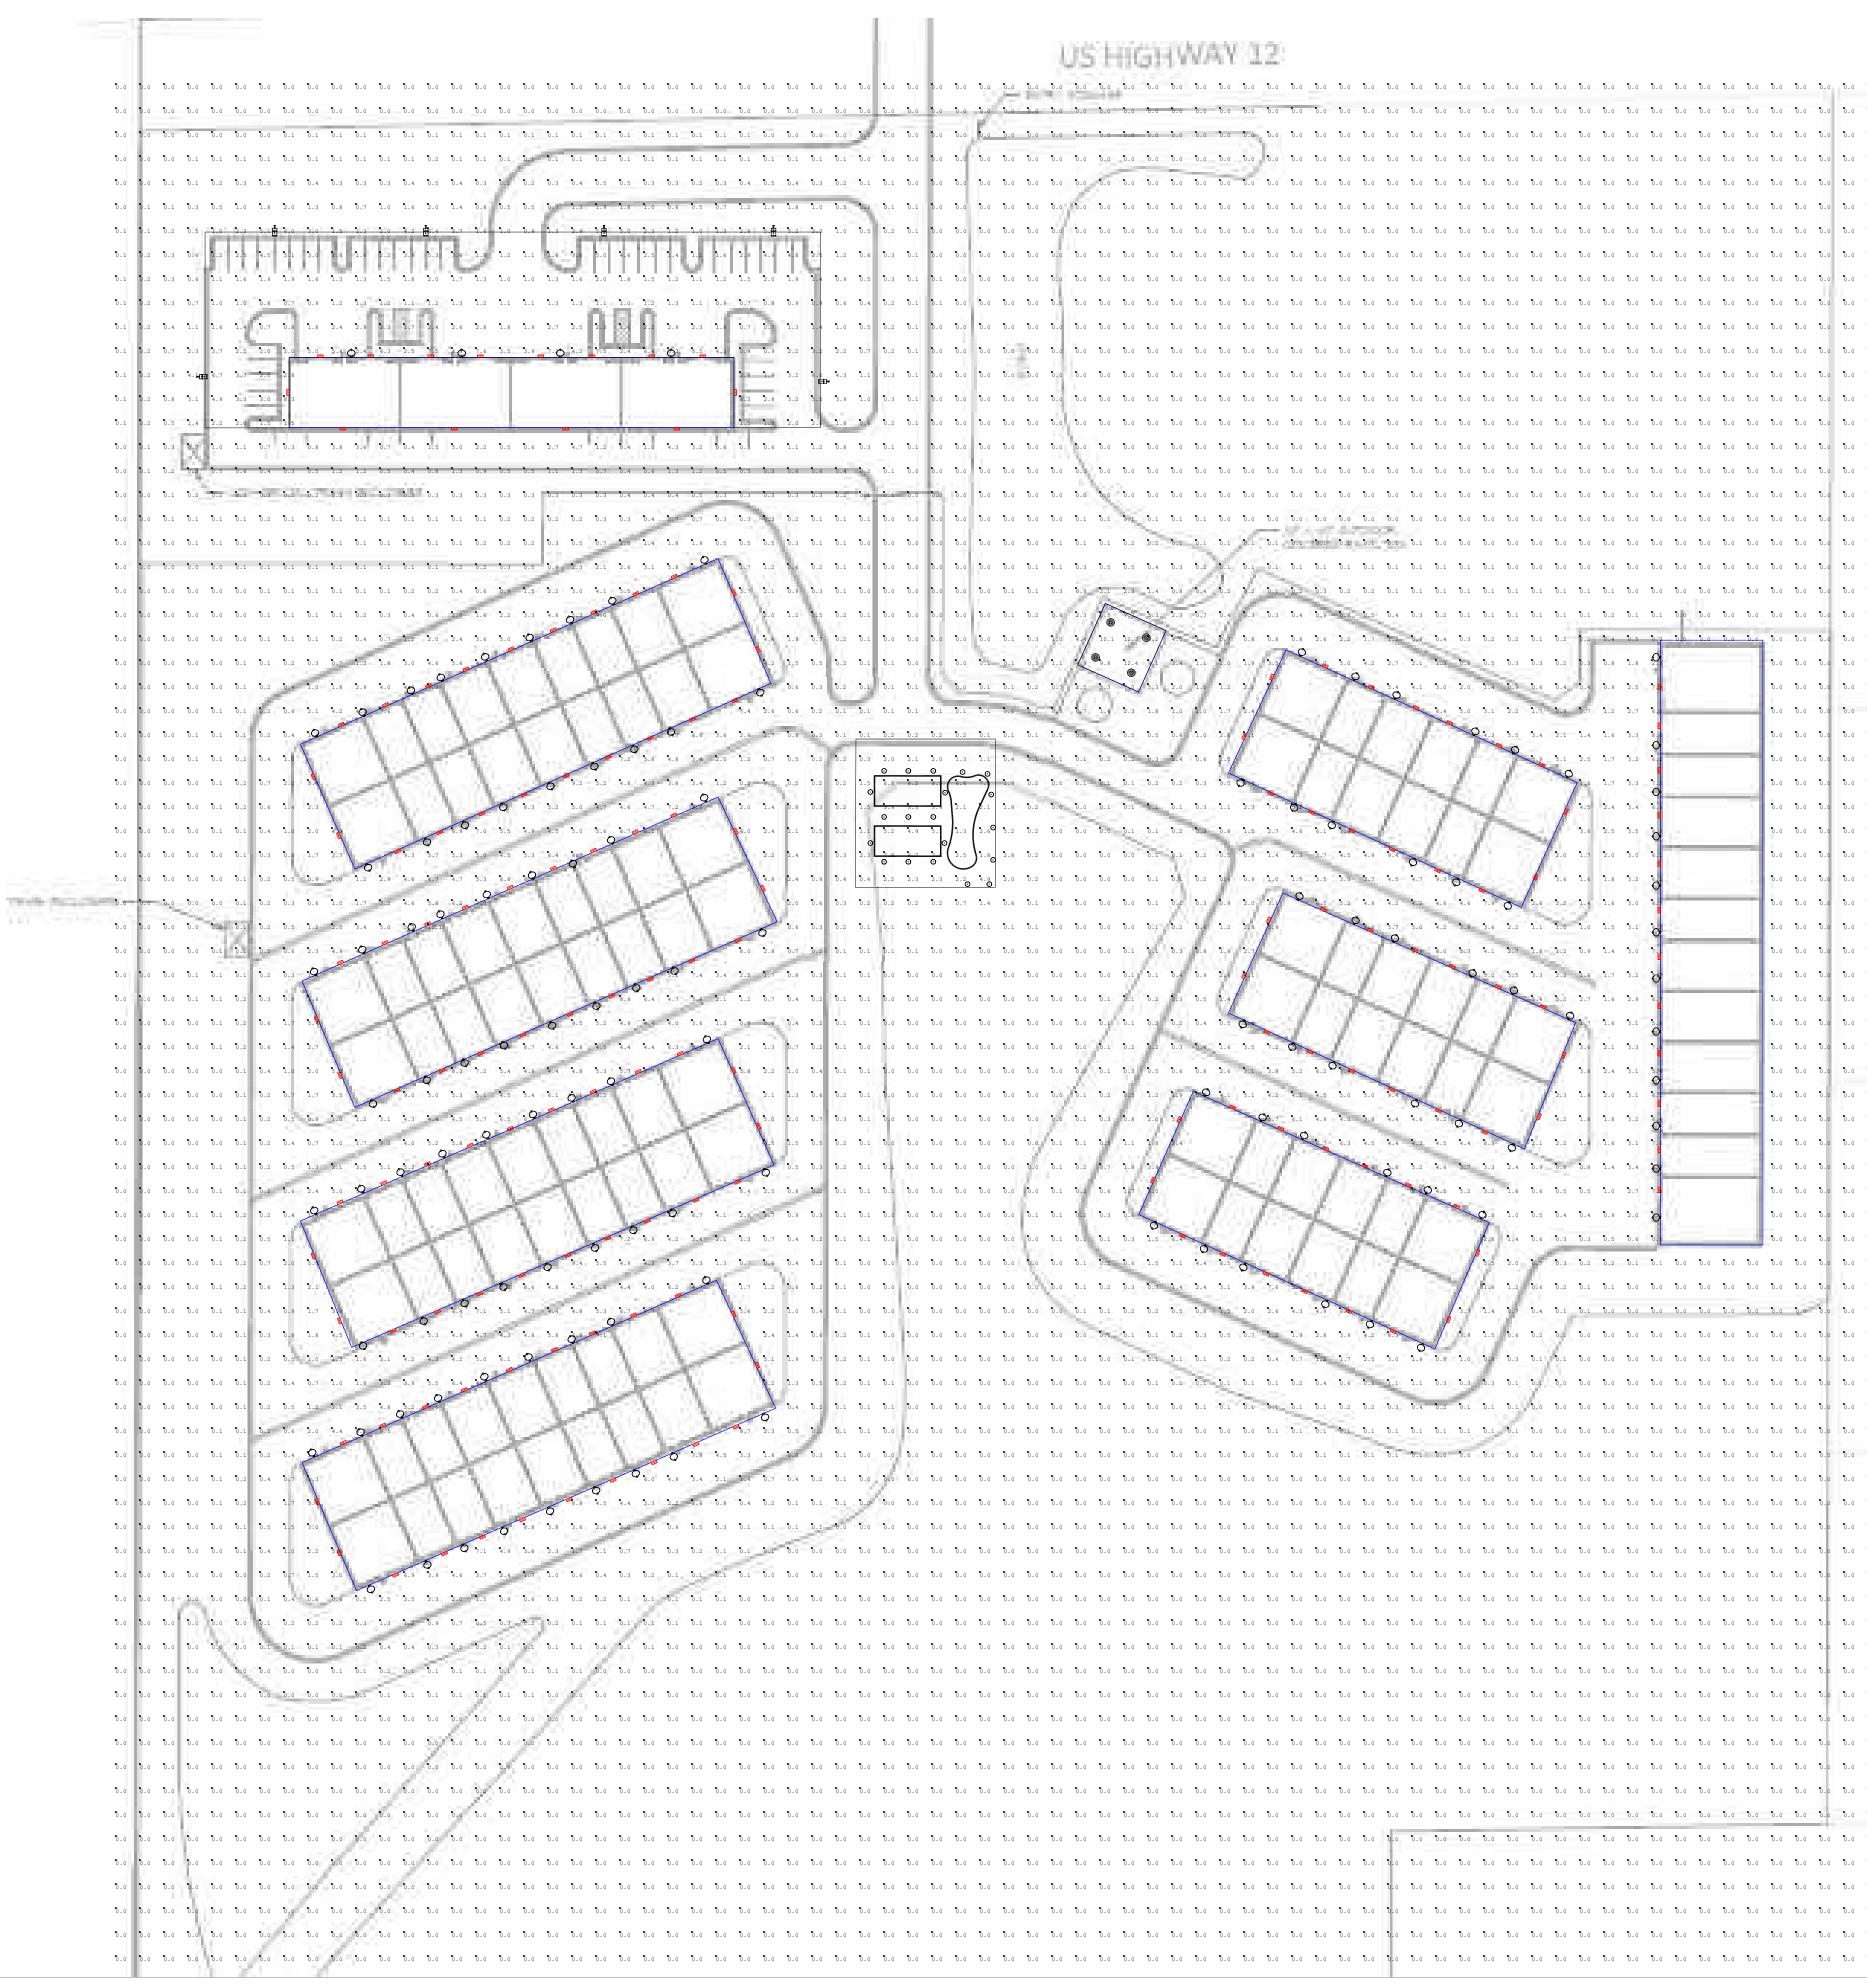


Scale: 1 inch= 60 Ft.

0.0 0.0	SINGLE FAMILY LOT			The use of the second of the s	With neither warranties, either implied or stated with regard to actual ption levels as compared to those illustrated by the Lighting pesign. ied or stated, nor represents the appropriateness, completeness or suitability faant with any applicable requistory code requirements with the exception of	ormational purposes and is not intendedfor construction nor as being part of package.	
b.o				provided by ROUZER ("ROUZER") repre- provided by ROUZER ("ROUZER") repre- based upon design parameters and in information provided by others have may vary from the actual field cond.	A subject of the contract of t	in part, as advisory documents for a project's construction documentat	
b.o	SINGLE FAMILY LOT		Scale: as noted	Date: 10/25/2023	Filename: Auto Condo.AGI	Drawn By: Eric Nephew	ndo.AGI
٥.٥ ٥.٥	SINGLE FAMILY LOT		Job Name: Auto Condos	Lighting Layout Version A			Filename: C:\Users\Eric\Rouzer Group\Rouzer Inside - Rouzer Inside Documents\RAB\Rouzer Layouts\Erics AGI\Auto Condo.AGI
b.0	SINGLE FAMILY LOT		Prepared For: ESG Architecture				Filename: C:\Users\Eric\Rouzer Group\Rouzer Inside - R
0.0 0.0 0.0 0.0 0.0 0.0 0.0				ROUZER	с R О U Р		

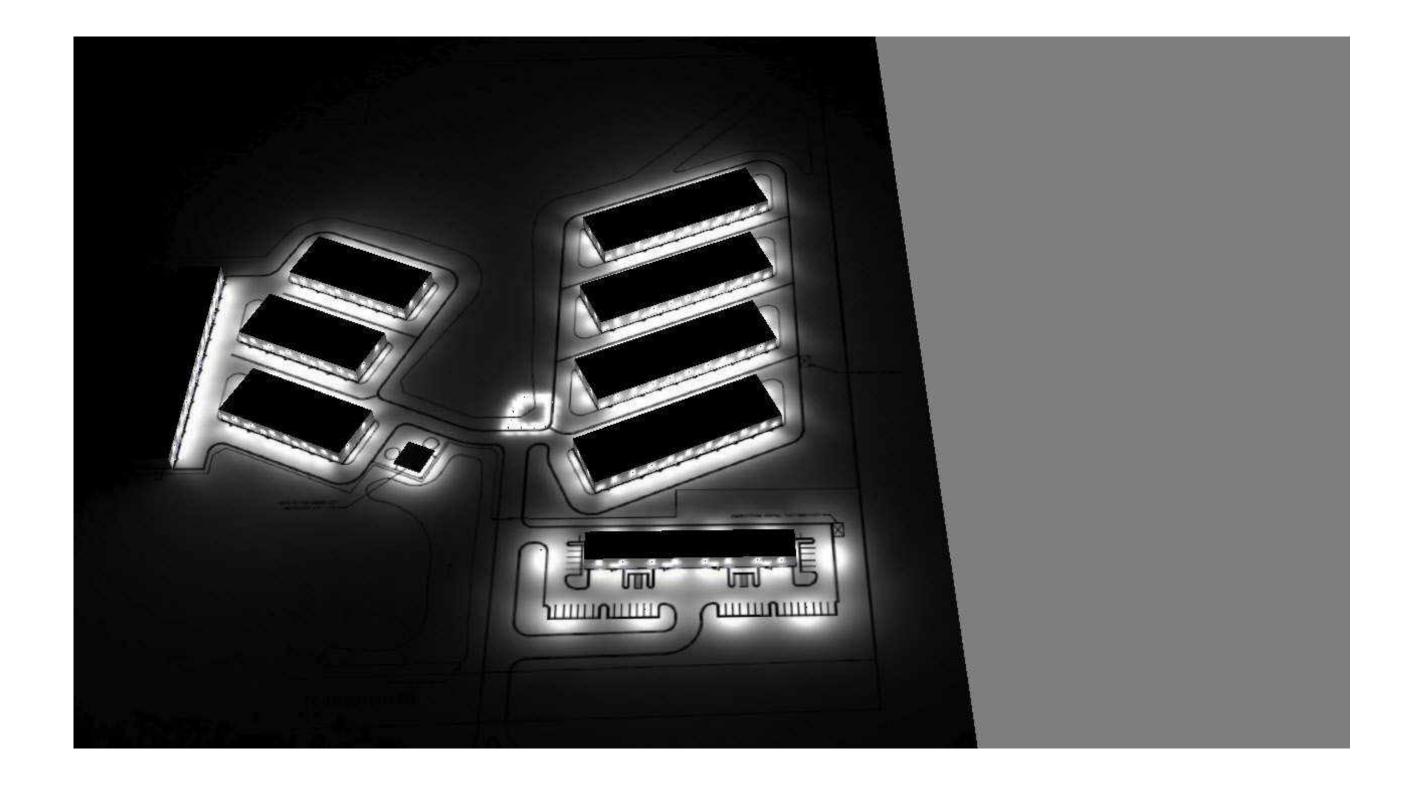

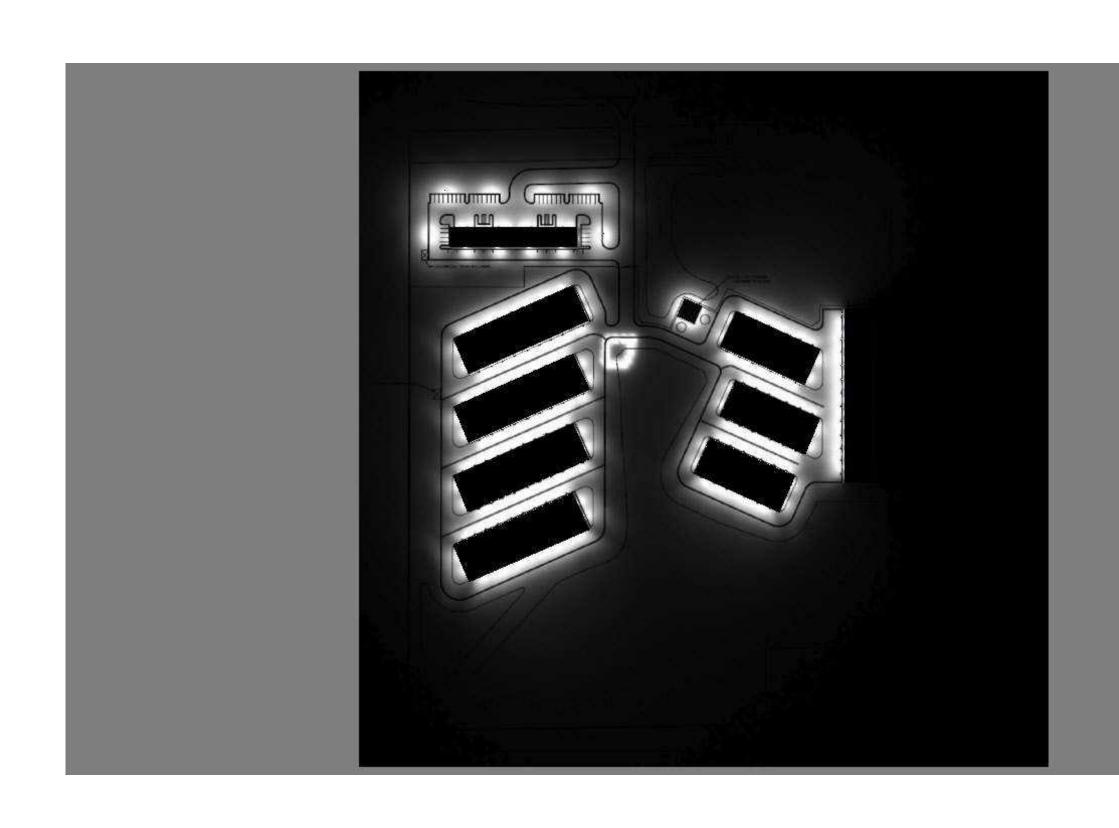

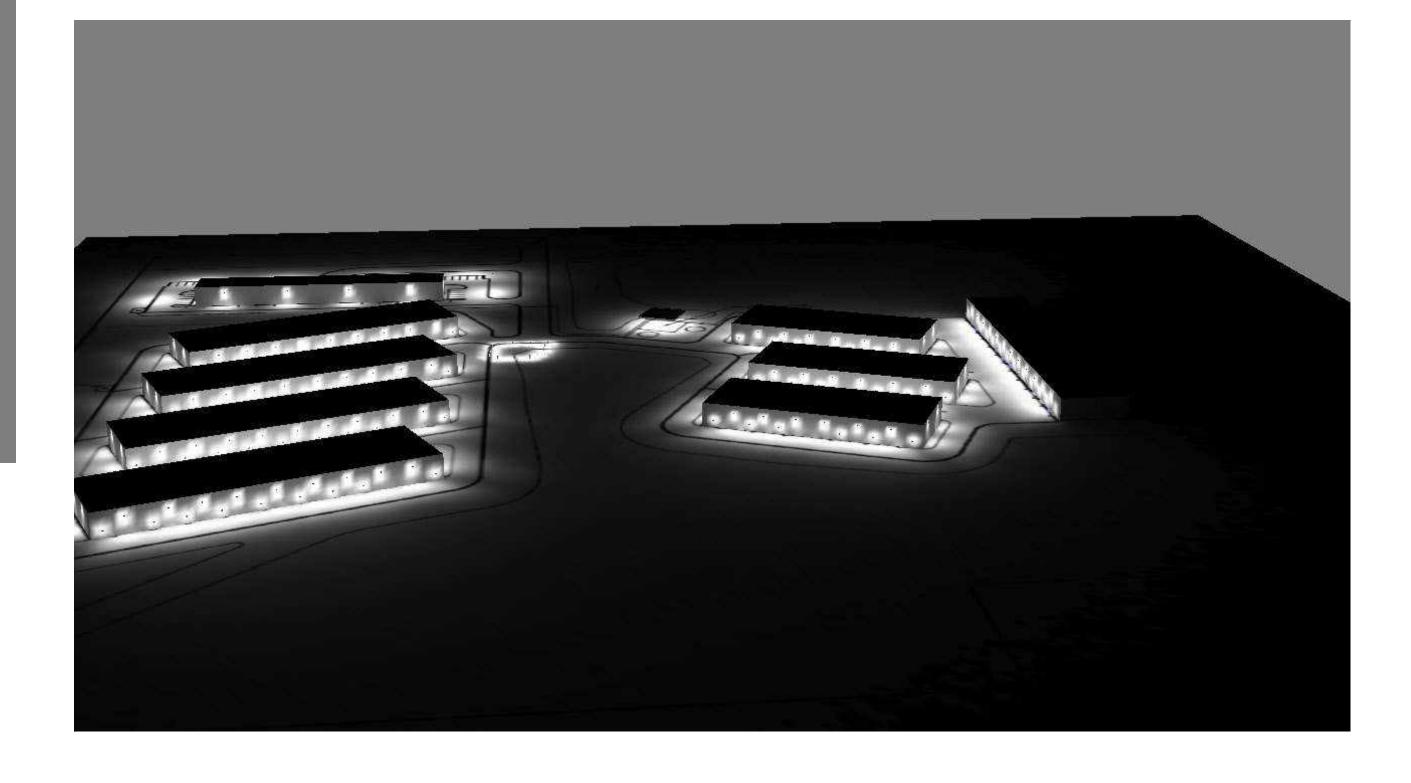

	The lighting Analysis, ezLayout, Energy Analysis and/or Visual Simulation ("Lighting Design) provided by ROUZER ("ROUZER") represents an anticipated prediction of Lighting system performance based upon design parameters and information supplied by others. These design parameters and information provided by others have not been field verified by ROUZER and therefore actual measured results may vary from the actual field conditions. ROUZER recommends that design parameters and and verified to reduce variation. ROUZER recommends that design parameters and other information be field verified to reduce variation. ROUZER recommends that design parameters and other information be ROUZER neither warranties, either implied or stated, nor represents the appropriateness, completeness or suitability to the Lighting Design intent as compliant with any applicable regulatory code requirements with the exception of those specifically stated on drawings created and submitted by ROUZER. The Lighting design is issued, in whole or in part, as advisory documents for informational purposes and is not intendedfor construction nor as being part of a project's construction package.									
Scale: as noted	Date:10/25/2023	Filename: Auto Condo.AGI	Drawn By: Eric Nephew							
Prepared For: ESG Architecture Job Name:	Lighting Layout Version A			Filename: C:\Users\Eric\Rouzer Group\Rouzer Inside - Rouzer Inside Documents\RAB\Rouzer Layouts\Erics AGI\Auto Condo.AGI						
Prep	ROUZER	G R O U P		Filenan						

Calculation Summa	ary										
Label	CalcType	Units	Avg	Max	Min	Avg/Min	Max/Min	Description	PtSpcLr	PtSpcTb	Meter Type
CalcPts_1	Illuminance	Fc	0.68	23.1	0.0	N.A.	N.A.	Readings taken at 0'-0" AFG	15	15	Horizontal
Amenity Area	Illuminance	Fc	4.16	23.1	0.1	41.60	231.00				
Parking Area	Illuminance	Fc	2.50	8.3	0.7	3.57	11.86				
Pavillion	Illuminance	Fc	9.70	12.4	7.0	1.39	1.77				

Luminaire Schedule

Symbol	Qty	Tag	Label	Arrangement	Lum. Lumens	Arr. Lum. Lumens	LLF	Description	Lum. Watts	Arr. Watts	Total Watts
	6	A	A17-3T100	SINGLE	14237	14237	1.000	A17-3T100	99.04	99.04	594.24
•	162	Т	SLIM17FAFC40	SINGLE	4595	4595	1.000	SLIM17FAFC40_5K	38.15	38.15	6180.3
	4		IVGT5-70L750ZU	SINGLE	7703	7703	1.000	IVGT5-70L750ZU	69.5046	69.5046	278.0184
□	124	С	CD34FA4W-20-508-KC	SINGLE	1735	1735	1.000	CD34FA4W-20-508-KC	18.4688	18.4688	2290.131
(+)	13	В	B17D	SINGLE	3470	3470	1.000	B17D 24W 5000K	22.9372	22.9372	298.1836

Expande	d Lumir	naire Location	Summary			
LumNo	Tag	X	Y	MTG HT	Orient	Tilt
1	A	196.9	1258.81	23	270	0
2	Α	291.27	1258.81	23	270	0
3	A	402.68	1258.81	23	270	0
4	A	508.62	1258.81	23	270	0
5	A	151.43	1167.67	23	0	0
6	A	540.09	1164.63	23	180	0
7	В	544.03	928.11	3.5	180	0
8	В	541.17	891.99	3.5	180	0
9	B	549.73	882.49	3.5	180	0
10	В	566.84	883.44	3.5	180	0
11	B	582.05	882.49	3.5	180	0
12	B	590.6	892.94	3.5	180	0
13	B	596.31	909.1	3.5	180	0
14	B	598.21	924.31	3.5	180	0
15	B	601.06	938.57	3.5	180	0
16	B	583	938.57	3.5	180	0
17	B	563.99	938.57	3.5	180	0
18	B	548.78	937.62	3.5	180	0
19	B	542.12	909.1	3.5	180	0
20	C	382.4	865.098	7	114.103	0
20	C	464.64	1054.89	7	114.103	0
	C		1029.389	7		0
22		407.04		7	114.103	
23	C	380.67	1017.498		114.103	0
24	C	355.42	1006.406	7	114.103	0
25	C	327.56	994.355	7	114.103	0
26	C	299.87	981.454	7	114.103	0
27	C	281.18	973.383	7	114.103	0
28	C	251.03	959.801	7	114.103	0
29	C	221.3	946.73	7	114.103	0
30	C	256.05	859.01	7	294.023	0
31	C	292.859	874.974	7	294.023	0
32	C	316.638	885.488	7	294.023	0
33	C	340.476	896.781	7	294.023	0
34	C	370.025	909.845	7	294.023	0
35	C	397.444	922.199	7	294.023	0
36	C	422.413	933.003	7	294.023	0
37	C	445.421	943.816	7	294.023	0
38	С	501.11	968.41	7	294.023	0
39	С	220.62	797.66	7	114.103	0
40	С	250.79	811.331	7	114.103	0
41	С	281.69	825.463	7	114.103	0
42	С	299.64	833.474	7	114.103	0
43	С	328.6	845.795	7	114.103	0
44	С	356.84	857.896	7	114.103	0
45	С	406.3	879.869	7	114.103	0
46	С	464.47	906.31	7	114.103	0
47	С	259.09	711.37	7	294.023	0
48	С	292.709	726.134	7	294.023	0
Total Qua	antity: 30	09 (48 show	n, 1 through	48)		

NOTES:

to the plane of calculation.

* RAB Lighting Inc. luminaire and product designs are protected under U.S. and International intellectual property laws. horizontal, vertical or inclined as designated in the calculation summary. Meter orientation is normal Patents issued or pending apply.

*****LAYOUT AND BOM ARE SUBJECT**

* The light loss factor (LLF) is a product of many variables, only lamp lumen depreciation (LLD) has been applied to the calculated results unless otherwise noted. The LLD is the result (quotient) of mean lumens / initial lumens per lamp manufacturers' specifications.

* Illumination values shown (in footcandles) are the predicted results for planes of calculation either

* The calculated results of this lighting simulation represent an anticipated prediction of system performance. Actual measured results may vary from the anticipated performance and are subject to means and methods which are beyond the control of the designer.

* Mounting height determination is job site specific, our lighting simulations assume a mounting height (insertion point of the luminaire symbol) to be taken at the top of the symbol for ceiling mounted luminaires and at the bottom of the symbol for all other luminaire mounting configurations.

s	Filename a17-3t100.ies SLIM17FAFC40_5K.ies IVGT5-70L750ZU - DLF1811104-9aMOD50.IES cd34fa4w-20-508-kc-20w-full-4000k.ies b17d_24w_5000k.ies O APPROVAL * * *		<pre>provided by ROUZER ("ROUZER")represents and/or Visual Simulation ("Lighting Design) provided by ROUZER ("ROUZER")represents an anticipated prediction of lighting system performance based upon design parameters and information supplied by others. These design parameters and information provided by others have not been field verified by ROUZER and therefore actual measured results may vary from the actual field conditions. ROUZER recommends that design parameters and other information he contact actual results</pre>	The d vertified to reduce variation. ROUZER neither warranties, either implied or stated with regard to actual measured light levels or energy consumption levels as compared to those illustrated by the Lighting Design. ROUZER neither warranties, either implied or stated, nor represents the appropriateness, completeness or suitability of the Lighting Design intent as compliant with any applicable regulatory code requirements with the exception of those specifically stated on drawings created and submitted by NOTZER The regulatory code requirements with the exception of	in part, as advisory documents for informational purposes and is not intendedfor construction nor as being part of a project's construction nor as being part of	
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		Prepared For: ESG Architecture				Filename: C:\Users\Eric\Rouzer Group\Rouzer Inside - Rouz
			NUZER	1000		